

40 RAKELY COURT, TORONTO, ON, M9C 5A5

ZONING BY-LAW AMENDMENT Version 3



175 Bloor St. East North Tower, 15th Floor

norr.com

Toronto, ON Canada M4W 3R8

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## CONSULTANT TEAM 40 RAKELY COURT - ONBL18-0225

**CLIENT:** 

RAKELY EGLINTON CORPORATE CENTRE, LIMITED PARTNERSHIP 1984 YONGE STREET TORONTO, ON M4S 1Z7

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GABRIEL FAIN ARCHITECTS

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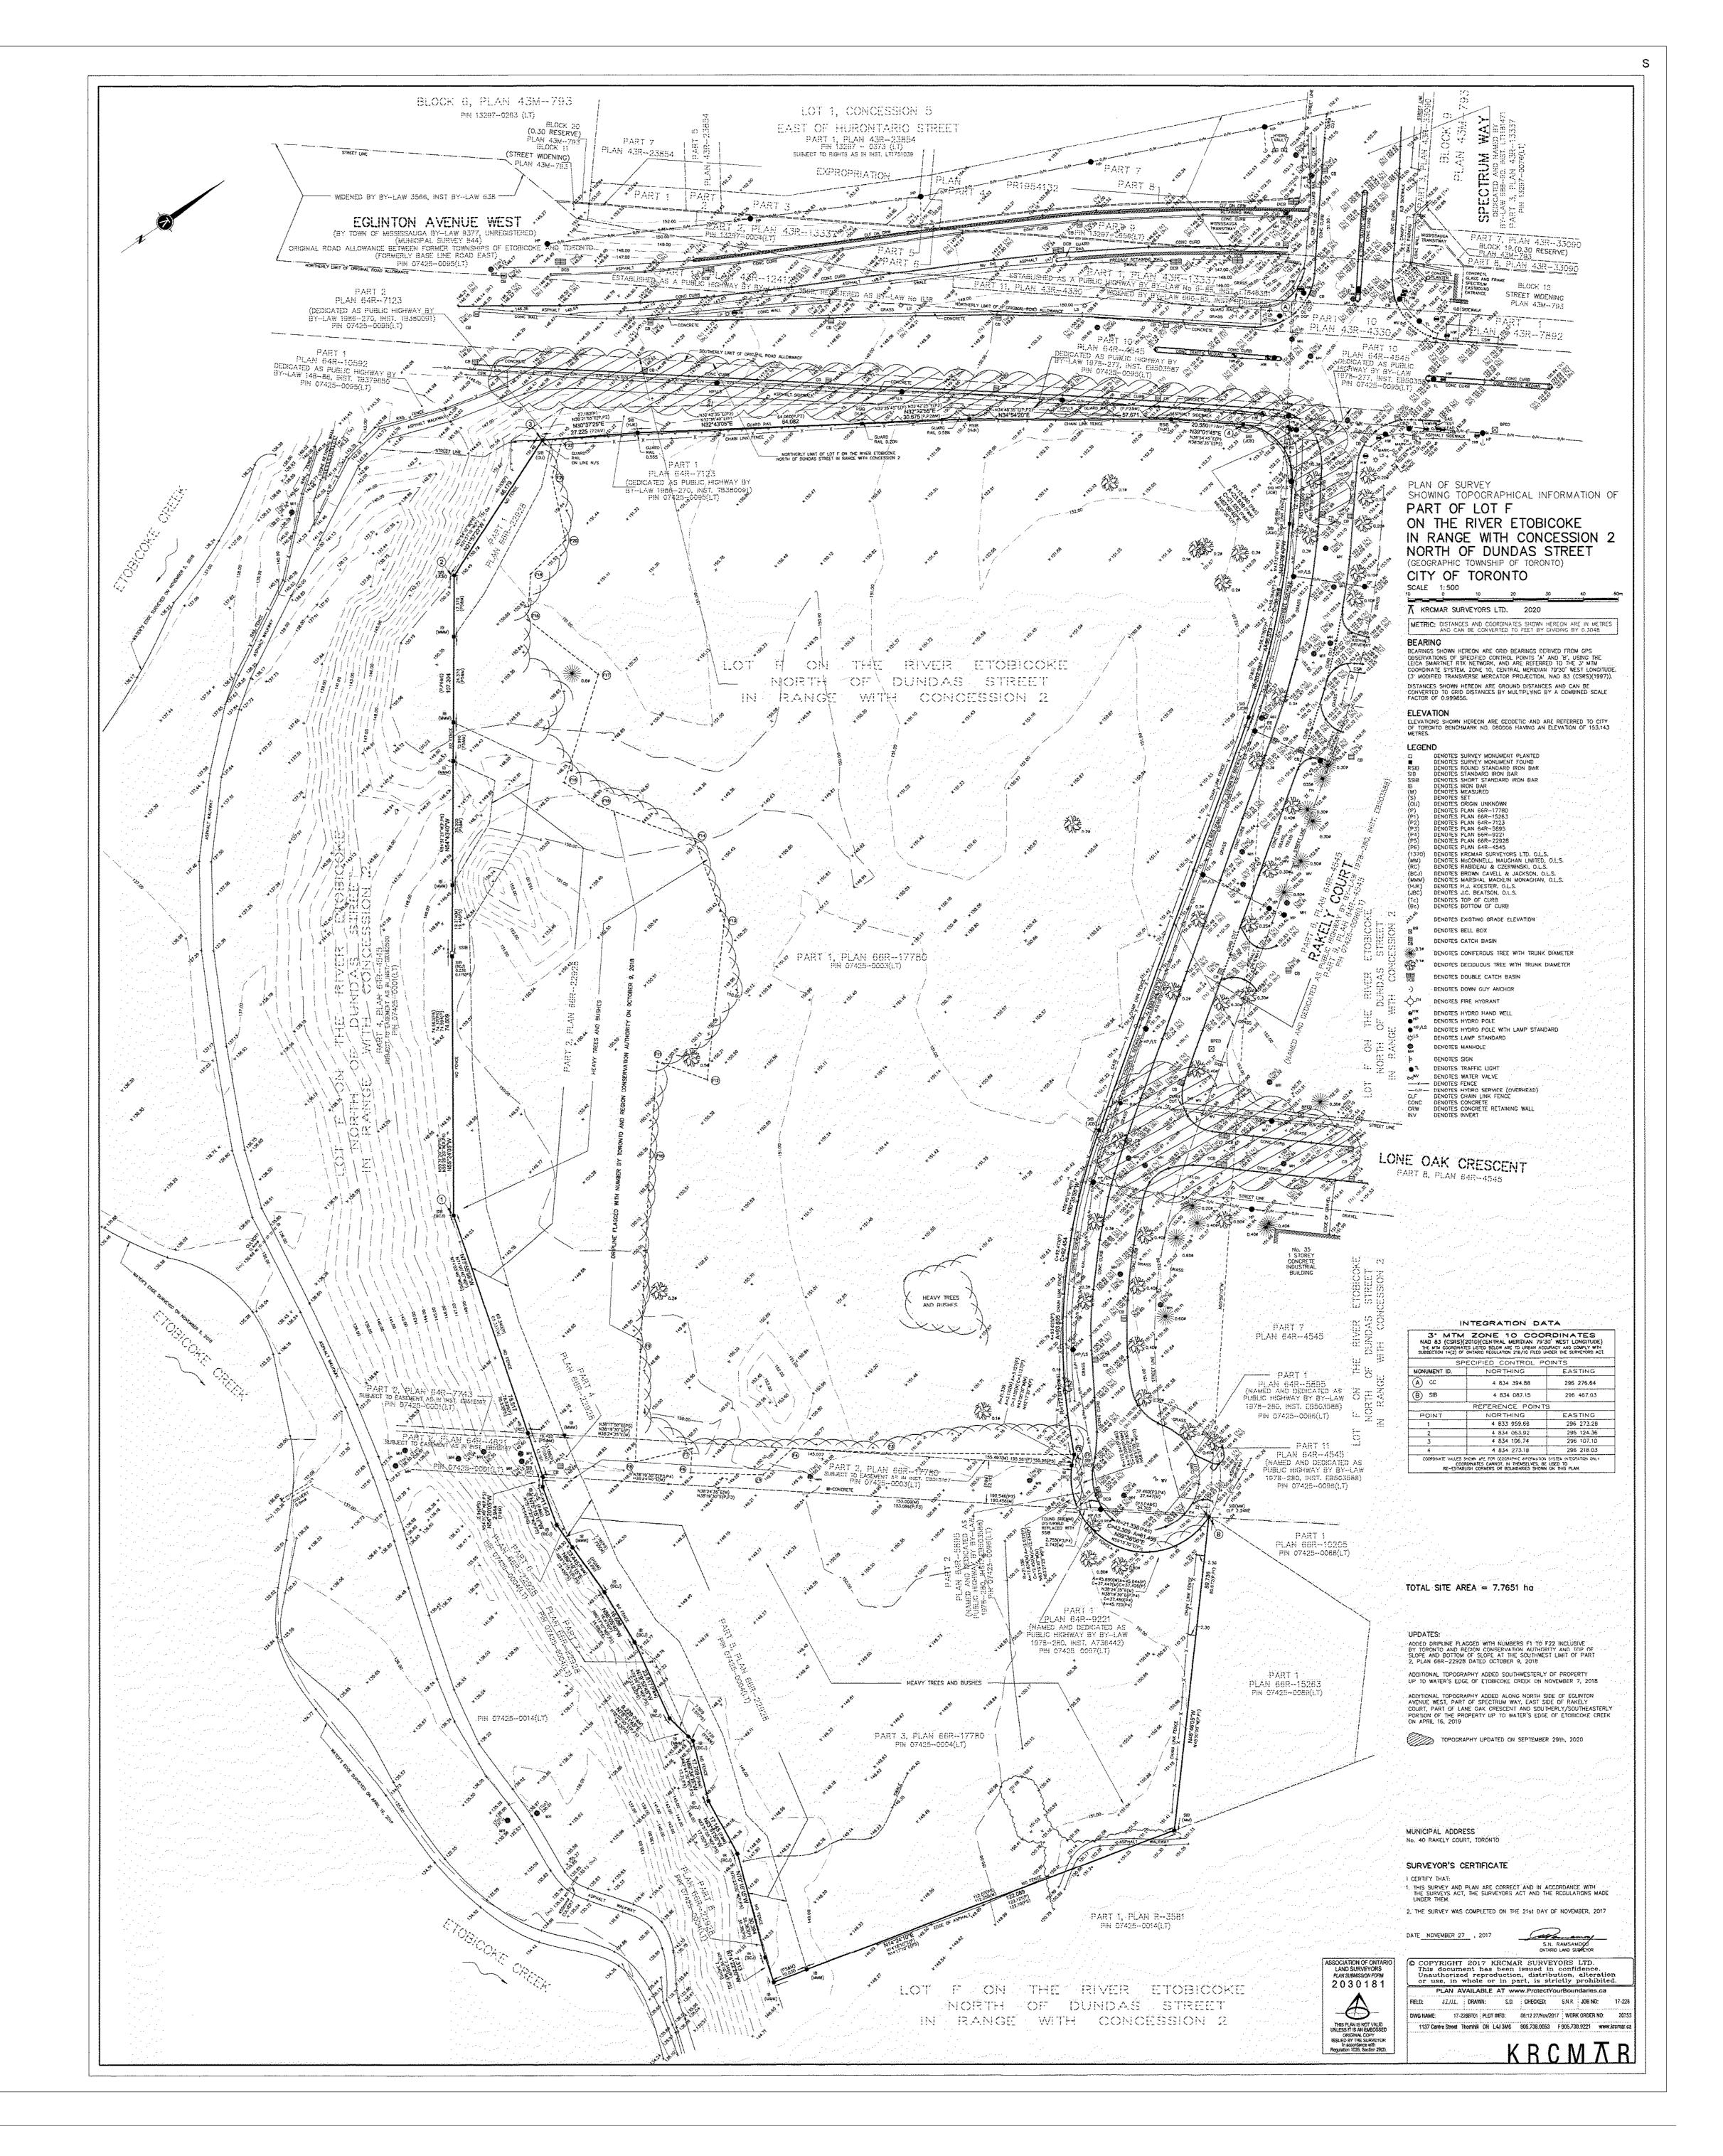
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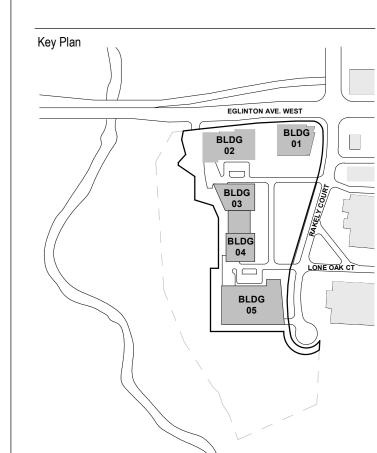
2018-06-25 ZONING BY-LAW AMENDMENT

2021-01-15 ZONING BY-LAW AMENDMENT

2022-10-03 ZONING BY-LAW AMENDMENT

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Consultants

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Landscape: JANET ROSENBERG & STUDIO INC.
Architecture: NORR ARCHITECTS AND ENGINEERS LIMITED
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Planning: URBAN STRATEGIES INC.
Consultant: GABRIEL FAIN ARCHITECTS INC.

Seal(s)

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Rakely Eglinton Corporate
Centre, Limited Partnership

40 RAKELY COURT, TORONTO, ON, M9C 5A5

Drawing Title
SITE SURVEY


Scale

Project No.

ONBL 18-0225

Drawing No.

A00-01

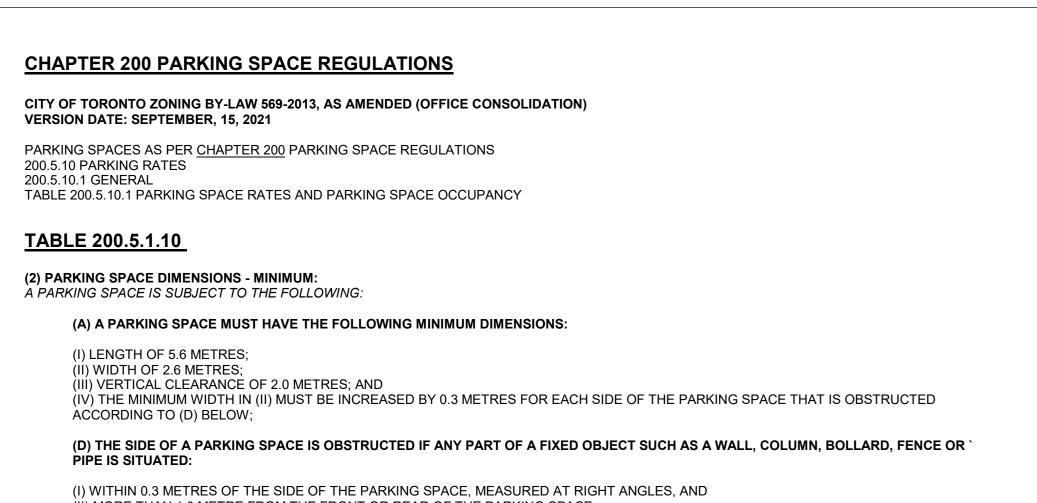

(II) MORE THAN 1.0 METRE FROM THE FRONT OR REAR OF THE PARKING SPACE (8) CALCULATION OF PARKING SPACE REQUIREMENT: IF A PARKING SPACE RATE IS EXPRESSED AS A RATIO OF PARKING SPACES TO THE GROSS FLOOR AREA, THE PARKING SPACE REQUIREMENT FOR A USE IS CALCULATED BY MULTIPLYING THE GROSS FLOOR AREA OF THE USE BY THE APPLICABLE RATE FOUND IN

(11) PARKING SPACE CALCULATION -GROSS FLOOR AREA EXCLUSION: THE INTERIOR FLOOR AREA OF THAT PORTION OF A BUILDING USED EXCLUSIVELY FOR HEATING, COOLING, VENTILATION, ELECTRICAL. FIRE EMERGENCY STAIRWELLS, ELEVATOR SHAFTS, ATRIUMS, UTILITY AREAS, STORAGE AREAS IN THE BASEMENT, PARKING SPACE, LOADING SPACE, OR A DRIVE AISLE USED TO ACCESS A PARKING SPACE OR LOADING SPACE, IS NOT INCLUDED IN THE GROSS FLOOR AREA FOR THE PURPOSE OF CALCULATING PARKING SPACE REQUIREMENTS.

#### TABLE 200.5.10.1 PARKING SPACE RATES

OFFICE (EXCLUDING MEDICAL OFFICE) PARKING SPACES MUST BE PROVIDED:

(D) IN ALL OTHER AREAS OF THE CITY, AT A MINIMUM RATE OF 1.5 FOR EACH 100 SQUARE METRES OF GROSS FLOOR AREA.

PARKING SPACES MUST BE PROVIDED IF THE GROSS FLOOR AREA ON A LOT IS MORE THAN 200 SQUARE METRES: (C) IN ALL OTHER AREAS OF THE CITY:

(I) IF THE GROSS FLOOR AREA IS MORE THAN 200 SQUARE METRES AND LESS THAN 10,000 SQUARE METRES, AT A MINIMUM RATE OF 1.5 FOR EACH 100 SQUARE METRES OF GROSS FLOOR AREA; AND

(II) IF THE GROSS FLOOR AREA IS 10,000 SQUARE METRES OR MORE BUT LESS THAN 20,000 SQUARE METRES, AT A MINIMUM RATE OF 3.0 FOR EACH 100 SQUARE METRES OF GROSS FLOOR AREA; AND

(III) IF THE GROSS FLOOR AREA IS 20,000 SQUARE METRES OR MORE, AT A MINIMUM RATE OF 6.0 FOR EACH 100 SQUARE METRES OF GROSS FLOOR AREA; AND

(D) IF THE GROSS FLOOR AREA ON A LOT IS 200 SQUARE METRES OR LESS, NO PARKING SPACE IS EQUIRED.

#### 200.15 REGULATIONS APPLYING TO ACCESSIBLE PARKING SPACE

TABLE 200.5.10.1 PARKING SPACE RATES AND PARKING SPACE OCCUPANCY.

CITY OF TORONTO ZONING BY-LAW 569-2013, AS AMENDED (OFFICE CONSOLIDATION) **VERSION DATE: SEPTEMBER, 15, 2021** 


ACCESSIBLE PARKING REQUIRED AS PER CHAPTER 200 PARKING SPACE REGULATIONS


200.15.15.4 TRANSITION: PARKING SPACE GENERAL REQUIREMENTS

#### 3) PARKING RATES - ACCESSIBLE PARKING SPACES IF THE TOTAL PARKING SPACE REQUIREMENT IS 5 OR MORE, CLEARLY IDENTIFIED OFF- STREET ACCESSIBLE PARKING SPACES MUST BE PROVIDED ON THE SAME LOT AS EVERY BUILDING OR STRUCTURE ERECTED OR ENLARGED, IN COMPLIANCE WITH THE FOLLOWING:

(C) IF THE NUMBER OF REQUIRED PARKING SPACES IS MORE THAN 100, A MINIMUM OF 4 PARKING SPACES PLUS 1 PARKING SPACE FOR EVERY 50 PARKING SPACES OR PART THEREOF IN EXCESS OF 100 PARKING SPACES, MUST COMPLY WITH THE MINIMUM DIMENSIONS FOR AN ACCESSIBLE PARKING SPACE. [BY-LAW: 579-2017]

# 10 PARKING DEFINITIONS

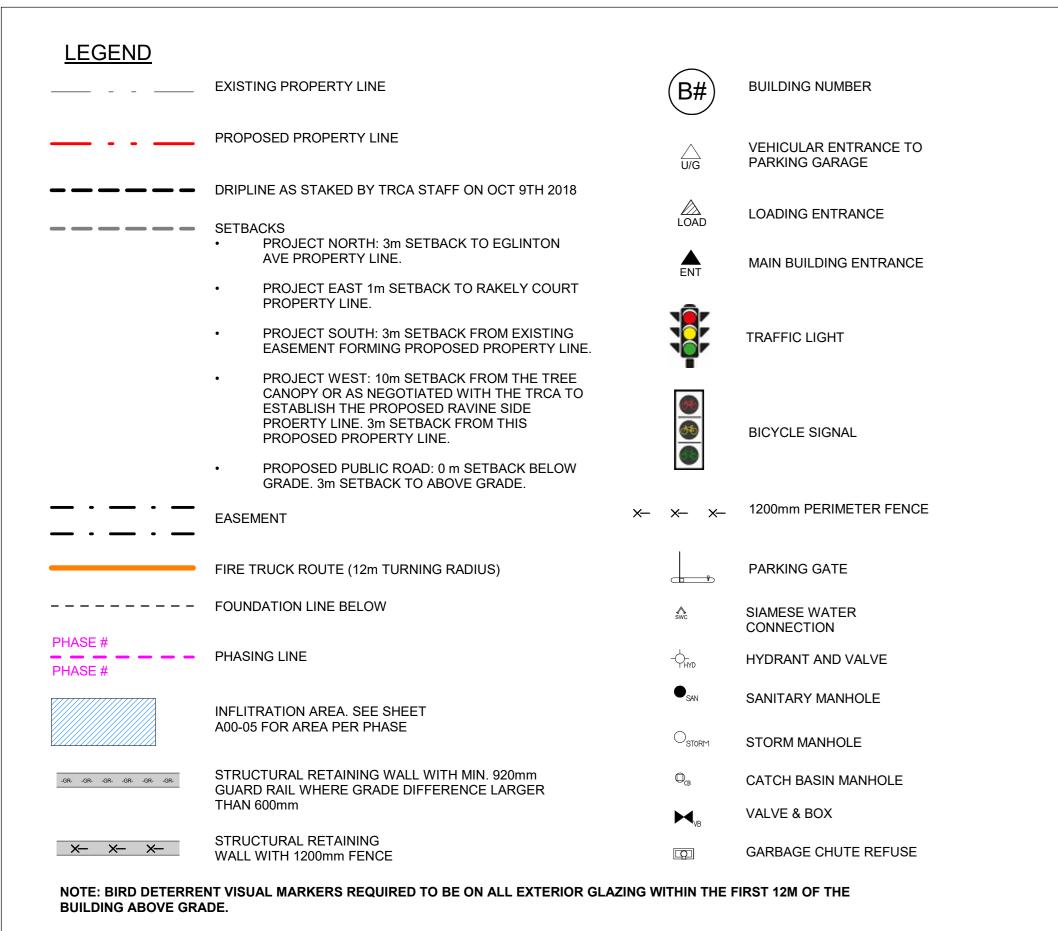

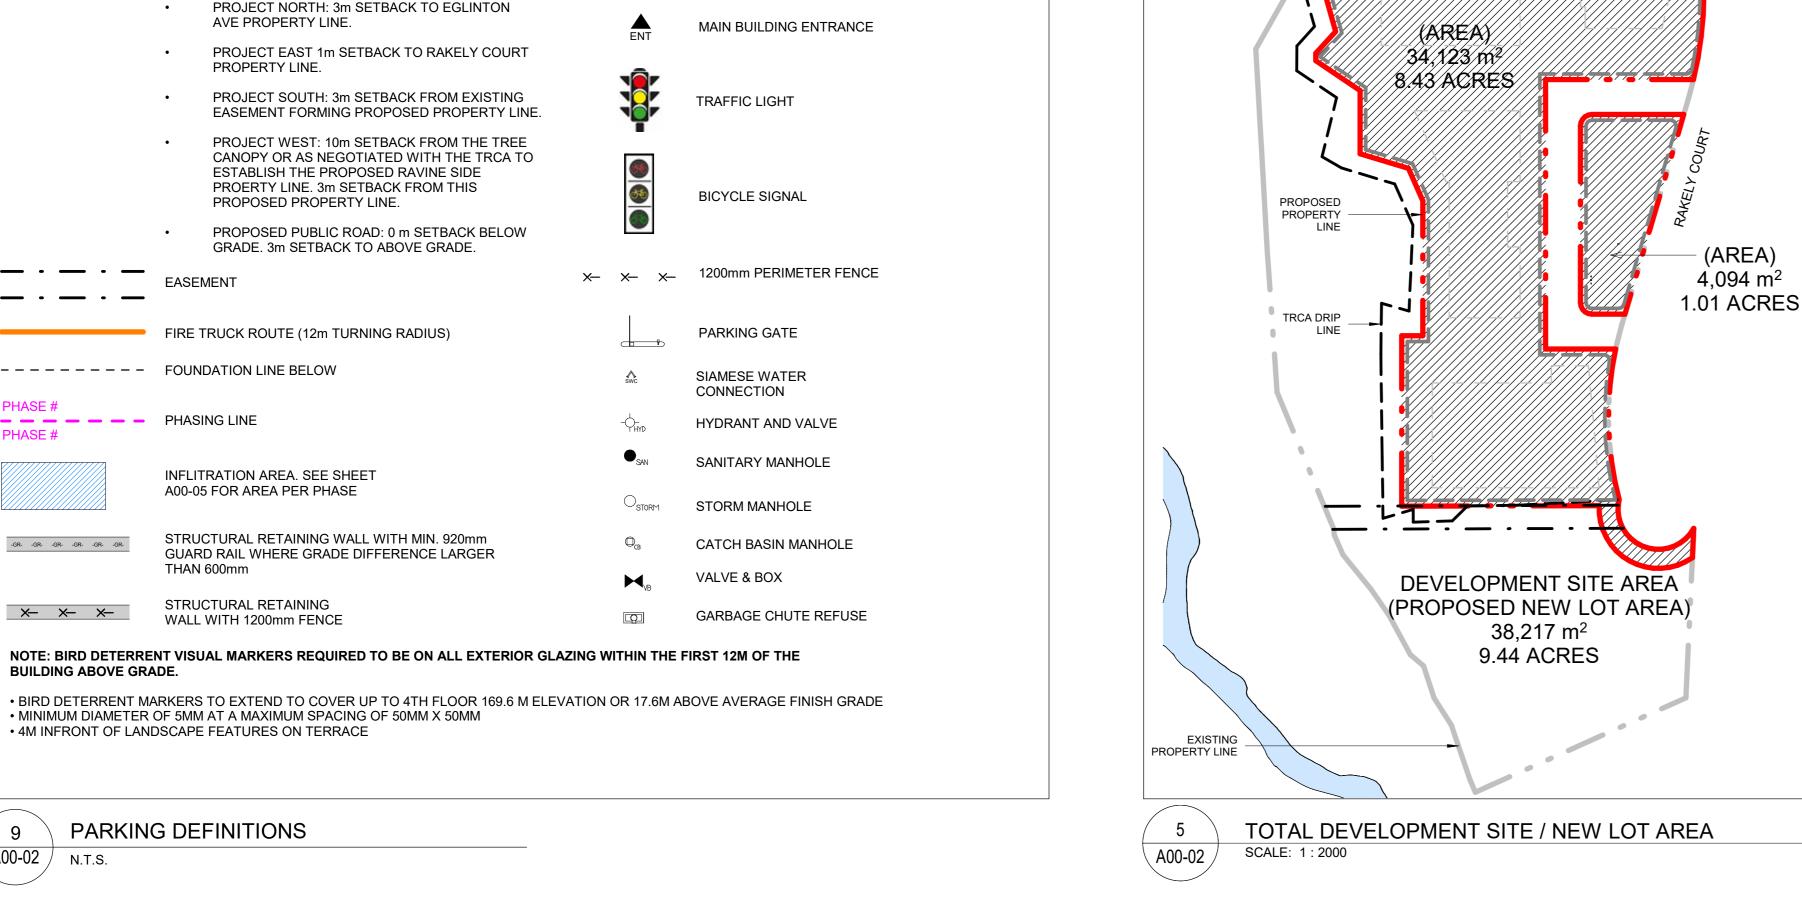

SCALE: 1:2000

NEW PRIVATE DRIVEWAY

SCALE: 1:2000

**EGLINTON AVE WEST** 

PROPOSED PAVED

SURFACE AREA


 $9,927 \text{ m}^2$ 


EGLINTON AVE WEST

2.453 ACRES

PROPOSED PAVED SURFACE AREA



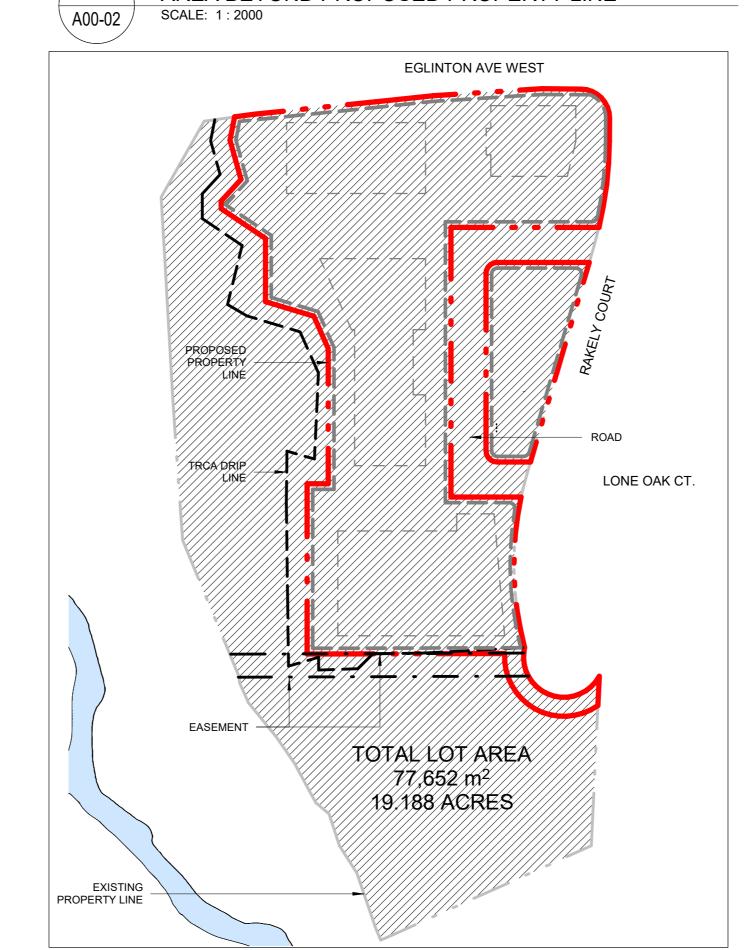

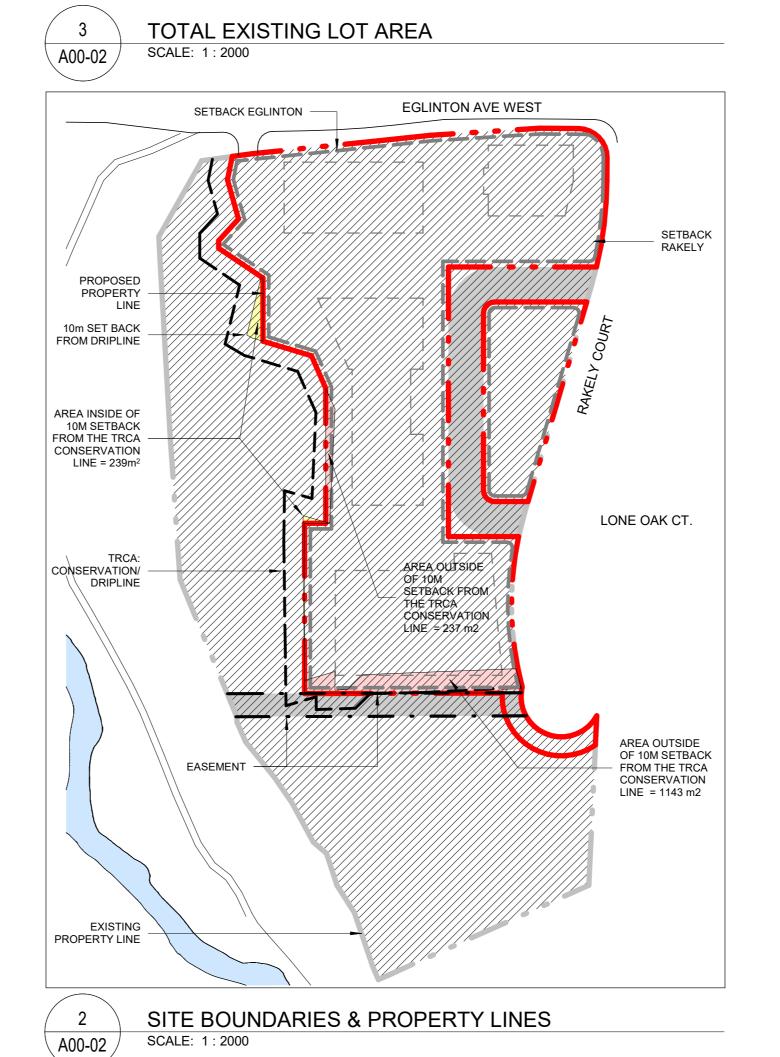

PROJECT STATISTICS OWNER	RAKELY EGLIN	TON CORPORATE CEI	NTRE LIMITED PA	RTNFRSHIP				
OWNER ADDRESS	1984 YONGE STREET, TORONTO, ON, M4S 1Z7							
LEGAL DESCRIPTION	LOT F ON THE	RIVER ETOBICOKE NO CONCESSION 2 (GEOG	RTH OF DUNDAS	_				
PROPOSED DEVELOPMENT MUNICIPAL ADDRESS	40 RAKEL COU	40 RAKEL COURT, TORONTO, ON, M9C 5A5						
OFFICIAL PLAN DESIGNATION	EMPLOYMENT	INDUSTRIAL						
SITE GRADE	152M							
SITE GRADE CURRENT ZONING	CITY OF ETOBICOKE BY-LAW 11-737 IC1 AND BY-LAW 1988-268							
	Hectares	m²	Acres	ft²				
TOTAL LOT AREA (TO EXISTING PROPERTY LINE)	7.7652	77,652	19.188	835,839				
DEVELOPMENT SITE AREA (PROPOSED NEW LOT AREA)	3.8217	38,217	9.44	411,364				
LOT FRONTAGE (m)	299.178	RAKELY COURT						
LOT DEPTH (m)	206.376.4	EGLINTON AVE. WE	ST					

	m²	Acres	RATIO
FLOOR SPACE RATIO (TOTAL GFA (ALLOWABLE) / TOTAL LOT AREA)	92,653	23.88	1.19
FLOOR SPACE RATIO (TOTAL GFA (ALLOWABLE) / DEVELOPMENT SITE AREA)	92,653	23.88	2.42
LOT COVERAGE RATIO (FOUNDATION FOOTPRINT / DEVELOPMENT SITE AREA)	28,893	7.140	0.756
LOT COVERAGE RATIO (GROUND FLOOR AREA / DEVELOPMENT SITE AREA)	13,776	3.404	0.360

	GFA (WITH	GFA (WITH DEDUCTIONS)  m² ft²  90,776 m² 977,104 ft²  1,877 m² 20,200 ft²  92,653 m² 997,304 ft²
		· · · · · · · · · · · · · · · · · · ·
GFA ABOVE GRADE (WITH ALLOWABLE DEDUCTIONS)	90,776 m²	977,104 ft²
GFA BELOW GRADE (WITH ALLOWABLE DEDUCTIONS)	1,877 m²	20,200 ft <sup>2</sup>
GFA ABOVE & BELOW GRADE (WITH ALLOWABLE DEDUCTIONS)	92,653 m²	997,304 ft <sup>2</sup>

BUILDING HEIGHT (m)*					
	BUILDING	STORIES	m	ft	GEODETIC
***************************************	B1	9	37.4m	122.7ft	189.4
*MEASURE TO TOP OF ROOF SLAB (WITHOUT MECHANICAL PENTHOUSE) GTAA BUILDING HEIGHT RESTRICTION. 66.48m	B2	9	37.4m	122.7ft	189.4
	В3	6	27.0m	88.6ft	179.0
	B4	6	27.0m	88.6ft	179.0
	B5	8	33.6m	110.2ft	185.6


DUII DINO #	TOTA	L GFA	COM.OFI	FICE GFA	COM.RETAIL GFA		
BUILDING #	m²	sf²	m²	sf²	m²	sf²	
PHASE 1							
B1	16,045 m²	172,712 ft²	13,693 m²	147,387 ft²	2,353 m²	25,325 ft²	
B2	24,539 m²	264,141 ft <sup>2</sup>	20,526 m <sup>2</sup>	220,938 ft <sup>2</sup>	4,014 m²	43,203 ft <sup>2</sup>	
BELOW GRADE	1,171 m²	12,606 ft <sup>2</sup>	822 m²	8,852 ft <sup>2</sup>	349 m²	3,754 ft <sup>2</sup>	
	41,756 m <sup>2</sup>	449,459 ft <sup>2</sup>	35,041 m <sup>2</sup>	377,177 ft <sup>2</sup>	6,715 m <sup>2</sup>	72,282 ft <sup>2</sup>	
PHASE 2							
ATRIUM	1,699 m²	18,284 ft²	1,699 m²	18,284 ft²	0 m²	0 ft²	
В3	11,080 m²	119,263 ft <sup>2</sup>	9,985 m²	107,478 ft <sup>2</sup>	1,095 m²	11,786 ft <sup>2</sup>	
B4	9,342 m²	100,554 ft <sup>2</sup>	8,492 m²	91,405 ft <sup>2</sup>	850 m²	9,149 ft <sup>2</sup>	
BELOW GRADE	412 m²	4,437 ft <sup>2</sup>	412 m²	4,437 ft <sup>2</sup>	0 m²	0 ft²	
	22,532 m²	242,538 ft <sup>2</sup>	20,588 m <sup>2</sup>	221,603 ft <sup>2</sup>	1,945 m²	20,935 ft <sup>2</sup>	
PHASE 3							
B5	28,071 m <sup>2</sup>	302,150 ft <sup>2</sup>	27,464 m²	295,615 ft <sup>2</sup>	607 m²	6,535 ft <sup>2</sup>	
BELOW GRADE	293 m²	3,158 ft²	293 m²	3,158 ft²	0 m²	0 ft²	
	28,364 m²	305,308 ft <sup>2</sup>	27,757 m <sup>2</sup>	298,773 ft <sup>2</sup>	607 m²	6,535 ft <sup>2</sup>	
TOTAL	92,653 m <sup>2</sup>	997,304 ft <sup>2</sup>	83,385 m <sup>2</sup>	897,553 ft <sup>2</sup>	9,267 m <sup>2</sup>	99,752 ft <sup>2</sup>	

ACCESSIE	BILITY PARKIN	1G	200.15.10 Parking Rate (1)Parking Rates - Accessible Parking Spaces	EVSE VEHICLE PARKING				
BRE	AKDOWN		(C) if the number of required parking spaces is more than 100, a minimum of 5 parking spaces	BY PHASE				
	PROPOSED PARKING COUNT	PARKING USE	<ul> <li>plus 1 parking space for every 50 parking spaces or part thereof in excess of 100 parking spaces, must comply with all regulations for an accessible parking space in Section 200.15. [ By-law: 579-2017 ]</li> </ul>	(TOTAL) PROPOSED	25% REQUIRED	EVSE PROPOSED		
Phase 1	3	POPs		PARKING EVSE		PARKING		
Dhaca 1			PHASE 1 = 5min + (608/50) 13 = <b>18 SPACES REQUIRED</b>	Phase 1		Phase 1		
Phase 1	15	Tenants	- 10 OF AGES REQUIRED	706	177	180		
Phase 2	11	<b>11</b> Tenants PHASE 2 = 5min + (358/50) 6		Phase 2	Phase 2			
	11	Tonanto	= 11 SPACES REQUIRED	356	89	90		
Phase 3	12	Tenants	PHASE 3 = 5min + (425/50) 7 = <b>12 SPACES REQUIRED</b>	Phase 3	1	Phase 3		
TOTALS ACCESSIBLE			ALL PHASES	425	106	108		
PARKING PROVIDED	41		= 41 SPACES REQUIRED	1487	372	378		

PHASING	BUILDING NO.#	LUILDING NO #						
FIIASING	BUILDING NO.#	TYPE A	TYPE B	TYPE C	TYPE G	TOTAL		
PHASE 1	B1+B2	-	3	3	-	6		
PHASE 2	B3 + B4	-	3	2	-	5		
PHASE 3	B5	-	3	3	-	6		
TOTAL		-	9	8	-	17		


BICYCLE PARKIN	<u>IG</u>				
AS PER TORONTO GREEN STAND. LONG-TERM AND SHORT-TERM BI IDENTIFIED WIN CHAPTER 230 OF	CYCLE PARKING SPACES CO	NSISTENT WITH			RETAIL PROPOS
COMMERICAL RETAIL					Level LONG TERM
					LEVEL P1
GFA WITH ALLOWABLE	SHORT TERM RETAI	IL SPACES	LONG TERM SPACES	TOTAL RETAIL	SHORT TERM
DEDUCTIONS (m <sup>2</sup> )	(0.25 SPACES/100m <sup>2</sup> )	+ 3 SPACES	(0.13 SPACES/ 100m <sup>2</sup> )	REQUIRED	LEVEL P1
0.0072	22		40	<b>F</b> 0	LEVEL 1
9,267 m²	23	3	12	53	TOTAL PROPOSED

COMMERICAL OFFICE						OFFICE PROPOS	SED
						Level	TOTAL
GFA WITH ALLOWABLE	SHORT TERM OFFICE	CE SPACES	LONG TERM SPACES	TOTAL OFFICE	Ī	ONG TERM	
DEDUCTIONS (m²)	(0.15 SPACES/100m <sup>2</sup> )	+3 SPACES		BIKES		LEVEL P1	126
2230110110 (iii )	(0.10 01 A020/100111 )	-0 OI AOLO	(6.15 6.715 26.11.7	REQUIRED	5	SHORT TERM	
83,385 m²	125	2	108	275		LEVEL P1	149
00,000 111	123	3	100	213		TOTAL PROPOSED	275

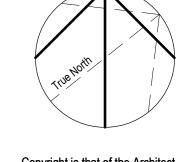

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Consultants Civil: R.J. BURNSIDE & ASSOCIATES LIMITED JANET ROSENBERG & STUDIO INC. Landscape: Architecture: NORR ARCHITECTS AND ENGINEERS LIMITED NORR ARCHITECTS AND ENGINEERS LIMITED NORR ARCHITECTS AND ENGINEERS LIMITED Mechanical: NORR ARCHITECTS AND ENGINEERS LIMITED Electrical: Traffic: BA CONSULTING GROUP LTD URBAN STRATEGIES INC. GABRIEL FAIN ARCHITECTS INC.

## NORR
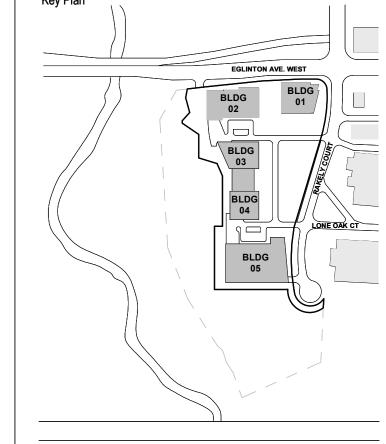
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Rakely Eglinton Corporate Centre, Limited Partnership

40 RAKELY COURT, TORONTO, ON, M9C 5A5

Drawing Title SITE STATISTICS & **BOUNDARY PLANS** 

As indicated Project No. ONBL 18-0225 Drawing No.

A00-02

PROJECT SITE INFORMATION A00-02 N.T.S.

9 PARKING DEFINITIONS


4M INFRONT OF LANDSCAPE FEATURES ON TERRACE

THE INTERIOR FLOOR AREA OF THAT PORTION OF A BUILDING USED EXCLUSIVELY FOR HEATING, COOLING, VENTILATION, ELECTRICAL, FIRE EMERGENCY STAIRWELLS, ELEVATOR SHAFTS, **ATRIUMS**, UTILITY AREAS, STORAGE AREAS IN THE BASEMENT, PARKING SPACE, LOADING SPACE, OR A DRIVE AISLE USED TO ACCESS A PARKING SPACE OR LOADING SPACE, IS NOT INCLUDED IN THE GROSS FLOOR AREA FOR THE


## **GFA DEFINITIONS**

(11) PARKING SPACE CALCULATION -GROSS FLOOR AREA EXCLUSION

PURPOSE OF CALCULATING PARKING SPACE REQUIREMENTS.

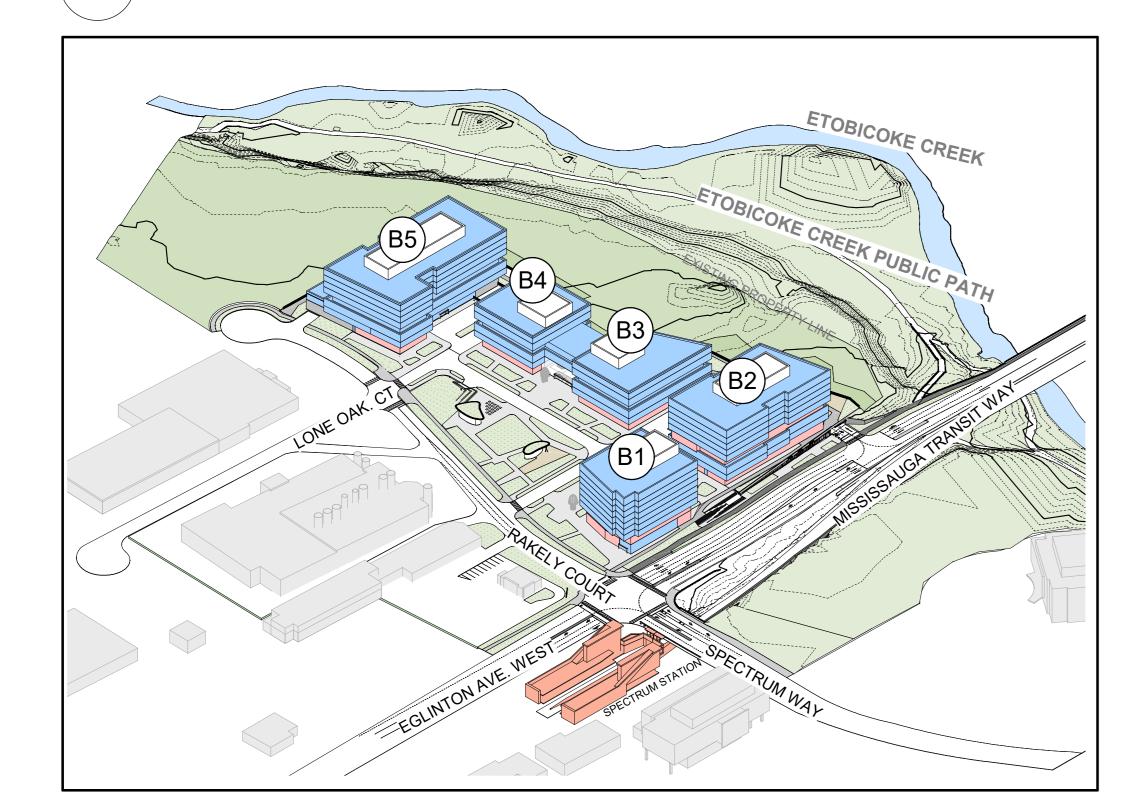

## SITE PERSPECTIVE FROM RAKELY

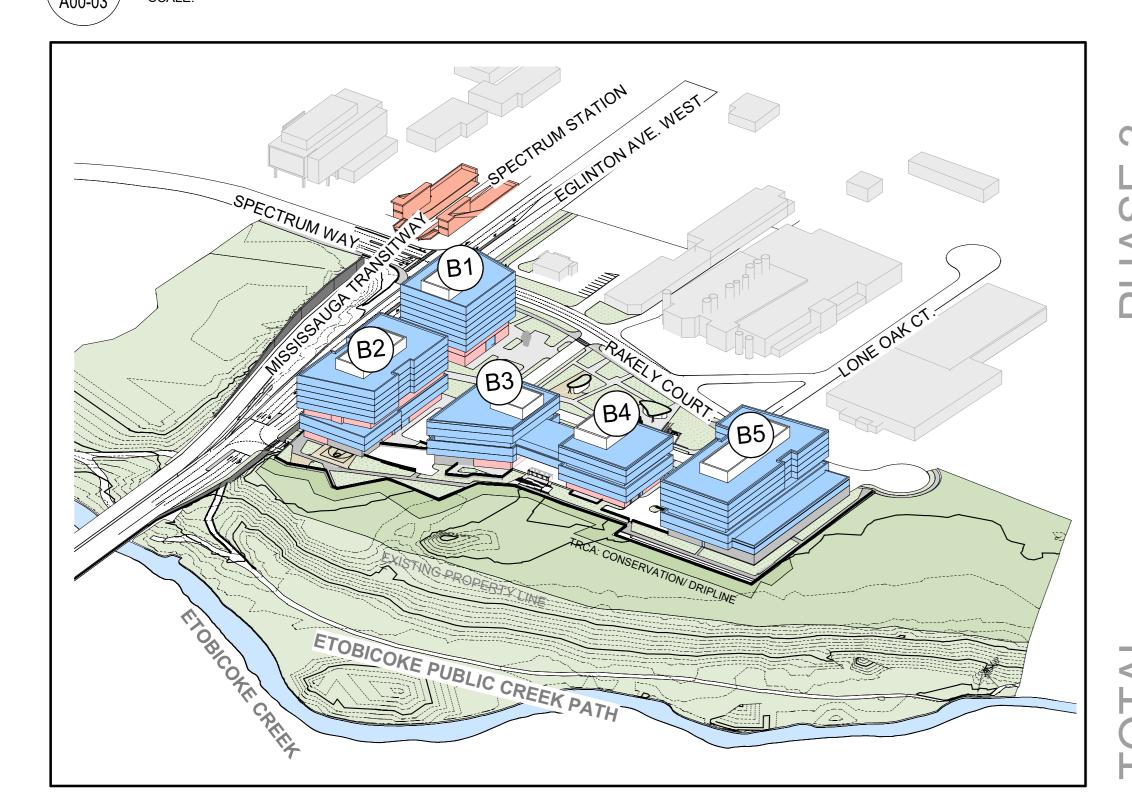

		IOIAL GFA (WITH	OUT DEDUCTIONS)	DEDUC	SHONS	GFA (WITH L	DEDUCTIONS)	RETAIL GFA (WI	TH DEDUCTIONS)	OFFICE GFA (WI	TH DEDUCTIONS)		PARKING RATI	<i>=</i>
NO#	LEVEL	m²	sf²	m²	sf²	m²	sf²	m²	sf²	m²	sf²		OFFICE (1.5 STALLS/ 100 m²)	TOTAL PARKING REQUIRE
PHASE 1														
B1	LEVEL 1	1,680 m²	18,080 ft²	475 m²	5,115 ft <sup>2</sup>	1,204 m²	12,964 ft²	951 m²	10,239 ft <sup>2</sup>	253 m²	2,726 ft²	14	4	18
B1	LEVEL 2	1,682 m²	18,102 ft²	280 m <sup>2</sup>	3,015 ft <sup>2</sup>	1,402 m²	15,087 ft <sup>2</sup>	1,402 m²	15,087 ft <sup>2</sup>	0 m <sup>2</sup>	0 ft²	21	0	21
B1	LEVEL 3	2,102 m <sup>2</sup>	22,622 ft <sup>2</sup>	182 m²	1,957 ft²	1,920 m <sup>2</sup>	20,666 ft <sup>2</sup>	0 m <sup>2</sup>	0 ft²	1,920 m²	20,666 ft <sup>2</sup>	0	29	29
B1	LEVEL 4	2,102 m <sup>2</sup>	22,622 ft <sup>2</sup>	182 m²	1,957 ft²	1,920 m <sup>2</sup>	20,666 ft <sup>2</sup>	0 m <sup>2</sup>	0 ft²	1,920 m²	20,666 ft <sup>2</sup>	0	29	29
B1	LEVEL 5	2,102 m <sup>2</sup>	22,622 ft <sup>2</sup>	182 m²	1,957 ft²	1,920 m²	20,666 ft <sup>2</sup>	0 m <sup>2</sup>	0 ft²	1,920 m²	20,666 ft <sup>2</sup>	0	29	29
B1	LEVEL 6	2,102 m <sup>2</sup>	22,622 ft <sup>2</sup>	182 m²	1,957 ft²	1,920 m <sup>2</sup>	20,666 ft <sup>2</sup>	0 m <sup>2</sup>	0 ft²	1,920 m²	20,666 ft <sup>2</sup>	0	29	29
B1	LEVEL 7	2,102 m <sup>2</sup>	22,622 ft <sup>2</sup>	182 m²	1,957 ft²	1,920 m²	20,666 ft <sup>2</sup>	0 m <sup>2</sup>	0 ft²	1,920 m²	20,666 ft <sup>2</sup>	0	29	29
B1	LEVEL 8	2,102 m <sup>2</sup>	22,622 ft <sup>2</sup>	182 m²	1,957 ft²	1,920 m²	20,666 ft <sup>2</sup>	0 m <sup>2</sup>	0 ft²	1,920 m²	20,666 ft <sup>2</sup>	0	29	29
B1	LEVEL 9	2,102 m <sup>2</sup>	22,622 ft <sup>2</sup>	182 m²	1,957 ft²	1,920 m <sup>2</sup>	20,666 ft <sup>2</sup>	0 m <sup>2</sup>	0 ft²	1,920 m²	20,666 ft <sup>2</sup>	0	29	29
1 ABOVE GRADE-GRO	SS FLOOR AREA	18,073 m <sup>2</sup>	194,539 ft <sup>2</sup>	2,028 m <sup>2</sup>	21,826 ft <sup>2</sup>	16,045 m²	172,712 ft²	2,353 m²	25,325 ft <sup>2</sup>	13,693 m²	147,387 ft <sup>2</sup>	35	205	241
B2	LEVEL 1	2,753 m²	29,635 ft <sup>2</sup>	827 m²	8,902 ft <sup>2</sup>	1,926 m²	20,733 ft <sup>2</sup>	1,712 m²	18,431 ft²	214 m²	2,301 ft <sup>2</sup>	26	3	29
B2	LEVEL 2	3,374 m <sup>2</sup>	36,314 ft²	280 m²	3,018 ft <sup>2</sup>	3,093 m <sup>2</sup>	33,296 ft <sup>2</sup>	0 m <sup>2</sup>	0 ft <sup>2</sup>	3,093 m <sup>2</sup>	33,296 ft <sup>2</sup>	0	46	46
B2	LEVEL 3	3,374 m <sup>2</sup>	36,314 ft²	280 m²	3,018 ft <sup>2</sup>	3,093 m <sup>2</sup>	33,296 ft <sup>2</sup>	0 m <sup>2</sup>	0 ft <sup>2</sup>	3,093 m <sup>2</sup>	33,296 ft <sup>2</sup>	0	46	46
B2	LEVEL 4	2,657 m²	28,602 ft <sup>2</sup>	356 m²	3,831 ft²	2,301 m <sup>2</sup>	24,771 ft <sup>2</sup>	2,301 m <sup>2</sup>	24,771 ft <sup>2</sup>	0 m <sup>2</sup>	0 ft <sup>2</sup>	35	0	35
B2	LEVEL 5	3,143 m <sup>2</sup>	33,827 ft <sup>2</sup>	424 m²	4,561 ft²	2,719 m <sup>2</sup>	29,265 ft <sup>2</sup>	0 m <sup>2</sup>	0 ft²	2,719 m <sup>2</sup>	29,265 ft <sup>2</sup>	0	41	41
B2	LEVEL 6	3,143 m <sup>2</sup>	33,827 ft <sup>2</sup>	291 m²	3,132 ft²	2,852 m <sup>2</sup>	30,695 ft <sup>2</sup>	0 m <sup>2</sup>	0 ft²	2,852 m <sup>2</sup>	30,695 ft <sup>2</sup>	0	43	43
B2	LEVEL 7	3,143 m <sup>2</sup>	33,827 ft²	291 m²	3,132 ft²	2,852 m <sup>2</sup>	30,695 ft <sup>2</sup>	0 m <sup>2</sup>	0 ft²	2,852 m <sup>2</sup>	30,695 ft <sup>2</sup>	0	43	43
B2	LEVEL 8	3,143 m <sup>2</sup>	33,827 ft²	291 m²	3,132 ft²	2,852 m <sup>2</sup>	30,695 ft <sup>2</sup>	0 m <sup>2</sup>	0 ft²	2,852 m <sup>2</sup>	30,695 ft <sup>2</sup>	0	43	43
B2	LEVEL 9	3,143 m <sup>2</sup>	33,827 ft²	291 m²	3,132 ft²	2,852 m <sup>2</sup>	30,695 ft <sup>2</sup>	0 m <sup>2</sup>	0 ft²	2,852 m <sup>2</sup>	30,695 ft <sup>2</sup>	0	43	43
ABOVE GRADE-GRO	SS FLOOR AREA	27,871 m²	299,999 ft <sup>2</sup>	3,331 m²	35,858 ft <sup>2</sup>	24,539 m²	264,141 ft <sup>2</sup>	4,014 m²	43,203 ft <sup>2</sup>	20,526 m²	220,938 ft <sup>2</sup>	60	308	368
BELOW GRADE	LEVEL P2	16,630 m²	179,005 ft²	16,267 m²	175,097 ft²	363 m²	3,908 ft²	0 m²	0 ft²	363 m²	3,908 ft <sup>2</sup>	0	5	5
BELOW GRADE	LEVEL P1	16,144 m²	173,775 ft²	15,336 m²	165,076 ft²	808 m <sup>2</sup>	8,698 ft <sup>2</sup>	349 m²	3,754 ft²	459 m²	4,944 ft <sup>2</sup>	5	7	12
ELOW GRADE-GROSS	I	32,774 m²	352,779 ft <sup>2</sup>	31,603 m <sup>2</sup>	340,173 ft <sup>2</sup>	1,171 m²	12,606 ft <sup>2</sup>	349 m²	3,754 ft <sup>2</sup>	822 m²	8,852 ft <sup>2</sup>	5	12	18
HASE 1-TOTAL SITE G		•	847,317 ft <sup>2</sup>	36,962 m <sup>2</sup>	397,858 ft <sup>2</sup>	41,756 m <sup>2</sup>	449,459 ft <sup>2</sup>	6,715 m <sup>2</sup>	72,282 ft <sup>2</sup>	35,041 m <sup>2</sup>	377,177 ft <sup>2</sup>	101	526	626
PHASE 2														
ATRIUM	LEVEL 1	1,070 m²	11,518 ft²	1,070 m²	11,518 ft²	0 m <sup>2</sup>	0 ft²	0 m <sup>2</sup>	0 ft²	0 m <sup>2</sup>	0 ft²	0	0	0

GFA (WITH DEDUCTIONS)

TOTAL GFA (WITHOUT DEDUCTIONS)

DEDUCTIONS

RETAIL GFA (WITH DEDUCTIONS) OFFICE GFA (WITH DEDUCTIONS)

PHASE 2														
ATRIUM	LEVEL 1	1,070 m²	11,518 ft²	1,070 m²	11,518 ft²	0 m <sup>2</sup>	0 ft <sup>2</sup>	0 m <sup>2</sup>	0 ft²	0 m <sup>2</sup>	0 ft²	0	0	0
ATRIUM	LEVEL 2	916 m²	9,861 ft <sup>2</sup>	916 m²	9,861 ft <sup>2</sup>	0 m <sup>2</sup>	0 ft²	0 m²	0 ft²	0 m <sup>2</sup>	0 ft²	0	0	0
ATRIUM	LEVEL 3	916 m²	9,861 ft <sup>2</sup>	0 m <sup>2</sup>	0 ft²	916 m²	9,861 ft <sup>2</sup>	0 m <sup>2</sup>	0 ft²	916 m²	9,861 ft <sup>2</sup>	0	14	14
ATRIUM	LEVEL 4	782 m²	8,423 ft <sup>2</sup>	0 m <sup>2</sup>	0 ft²	782 m²	8,423 ft <sup>2</sup>	0 m <sup>2</sup>	0 ft²	782 m²	8,423 ft <sup>2</sup>	0	12	12
ATRIUM-GROSS FLO	OR AREA	3,685 m²	39,663 ft <sup>2</sup>	1,986 m²	21,379 ft <sup>2</sup>	1,699 m²	18,284 ft²	0 m²	0 ft²	1,699 m²	18,284 ft <sup>2</sup>	0	25	25
В3	LEVEL 1	1,798 m²	19,353 ft²	678 m²	7,297 ft²	1,120 m²	12,056 ft²	1,095 m²	11,786 ft²	25 m²	270 ft²	16	0	17
B3	LEVEL 2	2,233 m <sup>2</sup>	24,034 ft <sup>2</sup>	155 m²	1,674 ft²	2,077 m <sup>2</sup>	22,360 ft <sup>2</sup>	0 m <sup>2</sup>	0 ft²	2,077 m <sup>2</sup>	22,360 ft <sup>2</sup>	0	31	31
В3	LEVEL 3	2,233 m <sup>2</sup>	24,034 ft <sup>2</sup>	155 m²	1,674 ft²	2,077 m <sup>2</sup>	22,360 ft <sup>2</sup>	0 m <sup>2</sup>	0 ft²	2,077 m <sup>2</sup>	22,360 ft <sup>2</sup>	0	31	31
В3	LEVEL 4	1,806 m²	19,439 ft²	155 m²	1,674 ft²	1,650 m <sup>2</sup>	17,766 ft²	0 m <sup>2</sup>	0 ft²	1,650 m²	17,766 ft²	0	25	25
B3	LEVEL 5	2,233 m <sup>2</sup>	24,034 ft <sup>2</sup>	155 m²	1,674 ft²	2,077 m <sup>2</sup>	22,360 ft <sup>2</sup>	0 m²	0 ft²	2,077 m²	22,360 ft <sup>2</sup>	0	31	31
В3	LEVEL 6	2,233 m <sup>2</sup>	24,034 ft <sup>2</sup>	155 m²	1,674 ft²	2,077 m <sup>2</sup>	22,360 ft <sup>2</sup>	0 m²	0 ft²	2,077 m²	22,360 ft <sup>2</sup>	0	31	31
B3 ABOVE GRADE-G	ROSS FLOOR AREA	12,535 m²	134,928 ft <sup>2</sup>	1,455 m²	15,665 ft <sup>2</sup>	11,080 m <sup>2</sup>	119,263 ft <sup>2</sup>	1,095 m²	11,786 ft <sup>2</sup>	9,985 m²	107,478 ft²	16	150	166
B4	LEVEL 1	1,381 m²	14,869 ft²	357 m²	3,844 ft²	1,024 m²	11,025 ft <sup>2</sup>	850 m²	9,149 ft <sup>2</sup>	174 m²	1,876 ft²	13	3	15
B4	LEVEL 2	1,901 m <sup>2</sup>	20,462 ft <sup>2</sup>	151 m²	1,624 ft²	1,750 m <sup>2</sup>	18,838 ft²	0 m <sup>2</sup>	0 ft²	1,750 m²	18,838 ft²	0	26	26
B4	LEVEL 3	1,901 m²	20,462 ft <sup>2</sup>	151 m²	1,624 ft²	1,750 m <sup>2</sup>	18,838 ft²	0 m <sup>2</sup>	0 ft²	1,750 m²	18,838 ft²	0	26	26
B4	LEVEL 4	1,468 m²	15,800 ft <sup>2</sup>	151 m²	1,624 ft²	1,317 m <sup>2</sup>	14,176 ft <sup>2</sup>	0 m²	0 ft²	1,317 m²	14,176 ft²	0	20	20
B4	LEVEL 5	1,901 m²	20,462 ft <sup>2</sup>	151 m²	1,624 ft²	1,750 m²	18,838 ft²	0 m²	0 ft²	1,750 m²	18,838 ft²	0	26	26
B4	LEVEL 6	1,901 m²	20,462 ft <sup>2</sup>	151 m²	1,624 ft²	1,750 m²	18,838 ft²	0 m²	0 ft²	1,750 m²	18,838 ft²	0	26	26
B4 ABOVE GRADE-G	ROSS FLOOR AREA	10,453 m²	112,516 ft <sup>2</sup>	1,111 m²	11,962 ft <sup>2</sup>	9,342 m²	100,554 ft <sup>2</sup>	850 m <sup>2</sup>	9,149 ft <sup>2</sup>	8,492 m <sup>2</sup>	91,405 ft <sup>2</sup>	13	127	140
BELOW GRADE	LEVEL P2	8,046 m²	86,607 ft <sup>2</sup>	7,901 m <sup>2</sup>	85,041 ft²	146 m²	1,566 ft²	0 m²	0 ft²	146 m²	1,566 ft²	0	2	2
BELOW GRADE	LEVEL P1	8,047 m <sup>2</sup>	86,614 ft <sup>2</sup>	7,780 m <sup>2</sup>	83,743 ft <sup>2</sup>	267 m²	2,870 ft <sup>2</sup>	0 m²	0 ft²	267 m²	2,870 ft <sup>2</sup>	0	4	4
BELOW GRADE-GRO	SS FLOOR AREA	16,093 m²	173,221 ft <sup>2</sup>	15,681 m²	168,784 ft <sup>2</sup>	412 m²	4,437 ft <sup>2</sup>	0 m²	0 ft²	412 m²	4,437 ft <sup>2</sup>	0	6	6
PHASE 2-TOTAL SITE	E GROSS FLOOR AREA	42,766 m <sup>2</sup>	460,328 ft <sup>2</sup>	20,233 m <sup>2</sup>	217,790 ft <sup>2</sup>	22,532 m <sup>2</sup>	242,538 ft <sup>2</sup>	1,945 m²	20,935 ft <sup>2</sup>	20,588 m <sup>2</sup>	221,603 ft <sup>2</sup>	29	309	338

PHASE 3														
B5	LEVEL 1	4,948 m²	53,256 ft <sup>2</sup>	3,966 m²	42,694 ft²	981 m²	10,562 ft <sup>2</sup>	607 m²	6,535 ft <sup>2</sup>	374 m²	4,027 ft <sup>2</sup>	9	6	15
B5	LEVEL 2	5,463 m²	58,799 ft <sup>2</sup>	801 m²	8,626 ft <sup>2</sup>	4,661 m <sup>2</sup>	50,173 ft <sup>2</sup>	0 m²	0 ft <sup>2</sup>	4,661 m <sup>2</sup>	50,173 ft <sup>2</sup>	0	70	70
B5	LEVEL 3	4,201 m <sup>2</sup>	45,218 ft <sup>2</sup>	274 m²	2,944 ft²	3,927 m <sup>2</sup>	42,274 ft <sup>2</sup>	0 m²	0 ft <sup>2</sup>	3,927 m²	42,274 ft <sup>2</sup>	0	59	59
B5	LEVEL 4	3,352 m²	36,078 ft <sup>2</sup>	274 m²	2,944 ft²	3,078 m <sup>2</sup>	33,133 ft <sup>2</sup>	0 m²	0 ft <sup>2</sup>	3,078 m <sup>2</sup>	33,133 ft <sup>2</sup>	0	46	46
B5	LEVEL 5	4,127 m <sup>2</sup>	44,425 ft <sup>2</sup>	274 m²	2,944 ft²	3,854 m²	41,481 ft <sup>2</sup>	0 m²	0 ft <sup>2</sup>	3,854 m²	41,481 ft²	0	58	58
B5	LEVEL 6	4,130 m <sup>2</sup>	44,453 ft <sup>2</sup>	274 m²	2,944 ft²	3,856 m <sup>2</sup>	41,509 ft <sup>2</sup>	0 m²	0 ft <sup>2</sup>	3,856 m²	41,509 ft <sup>2</sup>	0	58	58
B5	LEVEL 7	4,130 m²	44,454 ft²	274 m²	2,944 ft²	3,856 m <sup>2</sup>	41,509 ft <sup>2</sup>	0 m²	0 ft <sup>2</sup>	3,856 m <sup>2</sup>	41,509 ft <sup>2</sup>	0	58	58
B5	LEVEL 8	4,130 m²	44,453 ft <sup>2</sup>	274 m²	2,944 ft²	3,856 m <sup>2</sup>	41,509 ft <sup>2</sup>	0 m²	0 ft <sup>2</sup>	3,856 m <sup>2</sup>	41,509 ft <sup>2</sup>	0	58	58
<b>B5 ABOVE GRADE-</b> 0	GROSS FLOOR AREA	34,480 m <sup>2</sup>	371,137 ft <sup>2</sup>	6,409 m <sup>2</sup>	68,986 ft <sup>2</sup>	28,071 m <sup>2</sup>	302,150 ft <sup>2</sup>	607 m <sup>2</sup>	6,535 ft <sup>2</sup>	27,464 m²	295,615 ft <sup>2</sup>	9	412	421
BELOW GRADE	LEVEL P2	7,798 m²	83,934 ft²	7,647 m²	82,315 ft²	150 m²	1,619 ft²	0 m²	0 ft²	150 m²	1,619 ft²	0	2	2
BELOW GRADE	LEVEL P1	7,797 m²	83,927 ft <sup>2</sup>	7,654 m²	82,389 ft <sup>2</sup>	143 m²	1,538 ft²	0 m²	0 ft <sup>2</sup>	143 m²	1,538 ft²	0	2	2
BELOW GRADE-GRO	OSS FLOOR AREA	15,595 m²	167,861 ft <sup>2</sup>	15,301 m²	164,704 ft <sup>2</sup>	293 m²	3,158 ft <sup>2</sup>	0 m²	0 ft²	293 m²	3,158 ft <sup>2</sup>	0	4	4
PHASE 3-TOTAL SIT	TE GROSS FLOOR AREA	50,075 m <sup>2</sup>	538,998 ft <sup>2</sup>	21,710 m <sup>2</sup>	233,690 ft <sup>2</sup>	28,364 m <sup>2</sup>	305,308 ft <sup>2</sup>	607 m <sup>2</sup>	6,535 ft <sup>2</sup>	27,757 m <sup>2</sup>	298,773 ft <sup>2</sup>	9	416	425

	GFA				GFA		RETAIL GFA		OFFICE GFA		VEHICLE PARKING RATES REQUIRED PER GFA WITH ALLOWABLE DEDUCTIONS BASED	
	(WITHOUT D	EDUCTIONS)	m²	ft²	(WITH DED	DUCTIONS)	(WITH DEI	DUCTIONS)	(WITH DEI	DUCTIONS)	ON 1.5 PARKING STALLS PER 100m <sup>2</sup> OFFICE &	
	m²	ft²	111	16	m²	ft²	m²	ft²	m²	ft²	1.5 PARKING STALLS PER 100m <sup>2</sup> RETAIL	
TOTAL ABOVE GRADE - GROSS FLOOR AREA	107,097 m²	1,152,781 ft²	16,321 m²	175,677 ft²	90,776 m²	977,104 ft²	8,918 m <sup>2</sup>	95,998 ft²	81,857 m <sup>2</sup>	881,106 ft <sup>2</sup>	1362	
TOTAL BELOW GRADE - GROSS FLOOR AREA	64,462 m²	693,861 ft <sup>2</sup>	62,585 m²	673,661 ft <sup>2</sup>	1,877 m²	20,200 ft <sup>2</sup>	349 m²	3,754 ft²	1,528 m²	16,446 ft²	28	
								T	I	, ,		
TOTAL SITE - GROSS FLOOR AREA	171,559 m²	1,846,642 ft²	78,906 m²	849,338 ft <sup>2</sup>	92,653 m <sup>2</sup>	997,304 ft²	9,267 m <sup>2</sup>	99,752 ft <sup>2</sup>	83,385 m <sup>2</sup>	897,553 ft <sup>2</sup>	1390	

TOTAL ALL PHASES: 414		69,598 m²	749,147 ft <sup>2</sup>	TOTAL A
PHASE 3: 125	1	23,708 m²	255,186 ft²	PHASE 3
B5	125 OFFICE UNITS	23,708 m²	255,186 ft²	Ш
PHASE 3				PHASE 3
PHASE 2: 105		17,280 m²	186,001 ft²	PHASE 2
B4	50 OFFICE UNITS	7,103 m²	76,456 ft²	
В3	45 OFFICE UNITS	8,622 m²	92,808 ft²	
ATRIUM	10 OFFICE UNITS	1,555 m²	16,737 ft²	PHASE 2
PHASE 2				PHASE 1
PHASE 1: 184		28,610 m²	307,960 ft <sup>2</sup>	BEI
B2	114 OFFICE UNITS	17,219 m²	185,343 ft²	
B1	70 OFFICE UNITS	11,392 m²	122,617 ft²	Z
PHASE 1				PHASE 1
BUILDING NO.	UNIT COUNTS	GFA (m²)	GFA (sf²)	BU
OFFICE U	NIT COUNT, BREAI	KDOWN PER PHASE &	PER BUILDING	

<u>RETAIL UN</u>	NIT CC	OUNT, BREAKDO	WN PER PHASE &	PER BUILDING
BUILDING NO.		RETAIL UNITS	GFA (m²)	GFA (sf²)
PHASE 1				
B1	7	RETAIL UNITS	2,353 m²	25,325 ft²
B2	15	RETAIL UNITS	4,014 m²	43,203 ft²
BELOW GRADE	1	RETAIL UNITS	349 m²	3,754 ft²
PHASE 1: 23			6,715 m²	72,282 ft²
PHASE 2				
В3	6	RETAIL UNITS	1,095 m²	11,786 ft²
B4	6	RETAIL UNITS	850 m²	9,149 ft²
PHASE 2: 12			1,945 m²	20,935 ft <sup>2</sup>
PHASE 3				
B5	5	RETAIL UNITS	607 m²	6,535 ft²
PHASE 3: 5			607 m²	6,535 ft <sup>2</sup>
TOTAL ALL PHASES: 40			9,267 m <sup>2</sup>	99,752 ft <sup>2</sup>

(PHASE 1) PROVIDED PAR	KING
	PROPOSED PARKING
Phase 1	
POPs	
LEVEL P1	
2.6 x 5.6m	31
2.6 x 5.6m EVSE	38
3.4 x 5.6m ACCESSIBLE SPACE	1
	70
LEVEL P2	
2.6 x 5.6m	70
2.6 x 5.6m EVSE	3
3.4 x 5.6m ACCESSIBLE SPACE	2
	75
Tenants	
LEVEL P1	
2.6 x 5.6m	156
2.6 x 5.6m EVSE	84
3.4 x 5.6m ACCESSIBLE SPACE	7
O. P. A. G.G.III / LOGICOIDEL GI / LOE	247
LEVEL P2	<b>₽</b> Ŧ1
2.6 x 5.6m	251
2.6 x 5.6m EVSE	55
3.4 x 5.6m ACCESSIBLE SPACE	8
J.4 A J.UIII ACCESSIBLE SPACE	
	314
PHASE 1 PARKING TOTALS PROVIDED	706

PROVIDED

	PROPOSED PARKING
Phase 2	
LEVEL P2	
2.6 x 5.6m	147
2.6 x 5.6m EVSE	45
3.4 x 5.6m ACCESSIBLE SPACE	7
	199
LEVEL P1	
2.6 x 5.6m	108
2.6 x 5.6m EVSE	45
3.4 x 5.6m ACCESSIBLE SPACE	4
	157
PHASE 2 PARKING TOTALS PROVIDED	356

	PROPOSED PARKING
Phase 3	
LEVEL P2	
2.6 x 5.6m	151
2.6 x 5.6m EVSE	47
3.4 x 5.6m ACCESSIBLE SPACE	4
LEVEL P1	
2.6 x 5.6m	104
2.6 x 5.6m EVSE	58
3.4 x 5.6m ACCESSIBLE SPACE	6
LEVEL 1	
2.6 x 5.6m	50
2.6 x 5.6m EVSE	3
3.4 x 5.6m ACCESSIBLE SPACE	2
PHASE 3 PARKING TOTALS PROVIDED	425


(TOTAL ALL PHASES) PROV	IDED PARKING
	ALL PHASES
POPs	
LEVEL P1	70
LEVEL P2	75
	145
Tenants	
LEVEL 1	55
LEVEL P1	572
LEVEL P2	715
	1342
ALL PHASES PARKING TOTALS PROVIDED	1487

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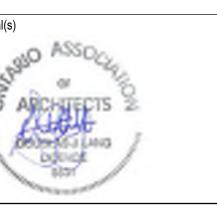
2018-06-25

ZONING BY-LAW AMENDMENT ZONING BY-LAW AMENDMENT

2022-10-03 ZONING BY-LAW AMENDMENT

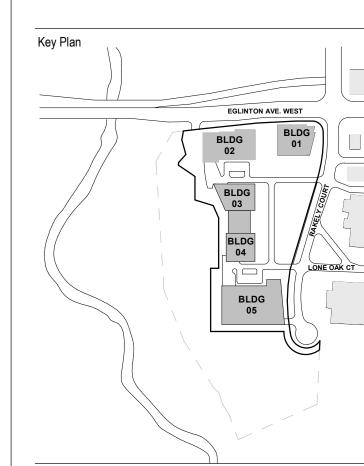

nsultants	
ivil: andscape: rchitecture: tructural: lechanical: lectrical: raffic: lanning: consultant:	R.J. BURNSIDE & ASSOCIATES LIMITED JANET ROSENBERG & STUDIO INC. NORR ARCHITECTS AND ENGINEERS LIMI BA CONSULTING GROUP LTD URBAN STRATEGIES INC. GABRIEL FAIN ARCHITECTS INC.



## NORR

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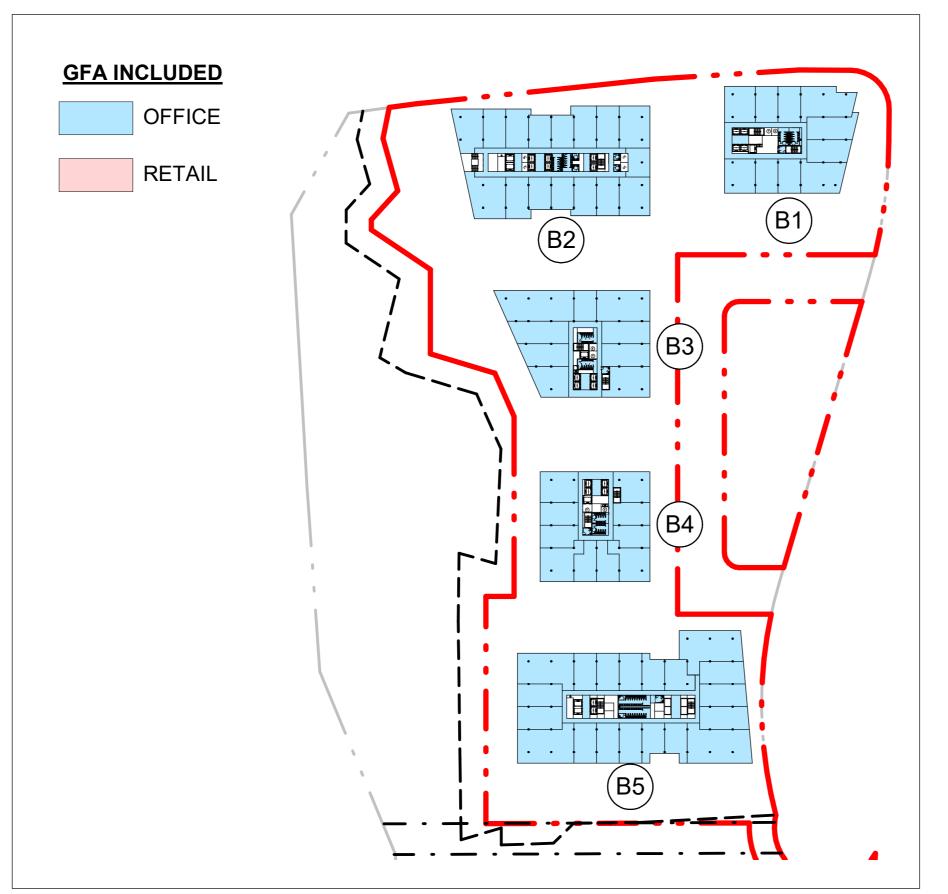
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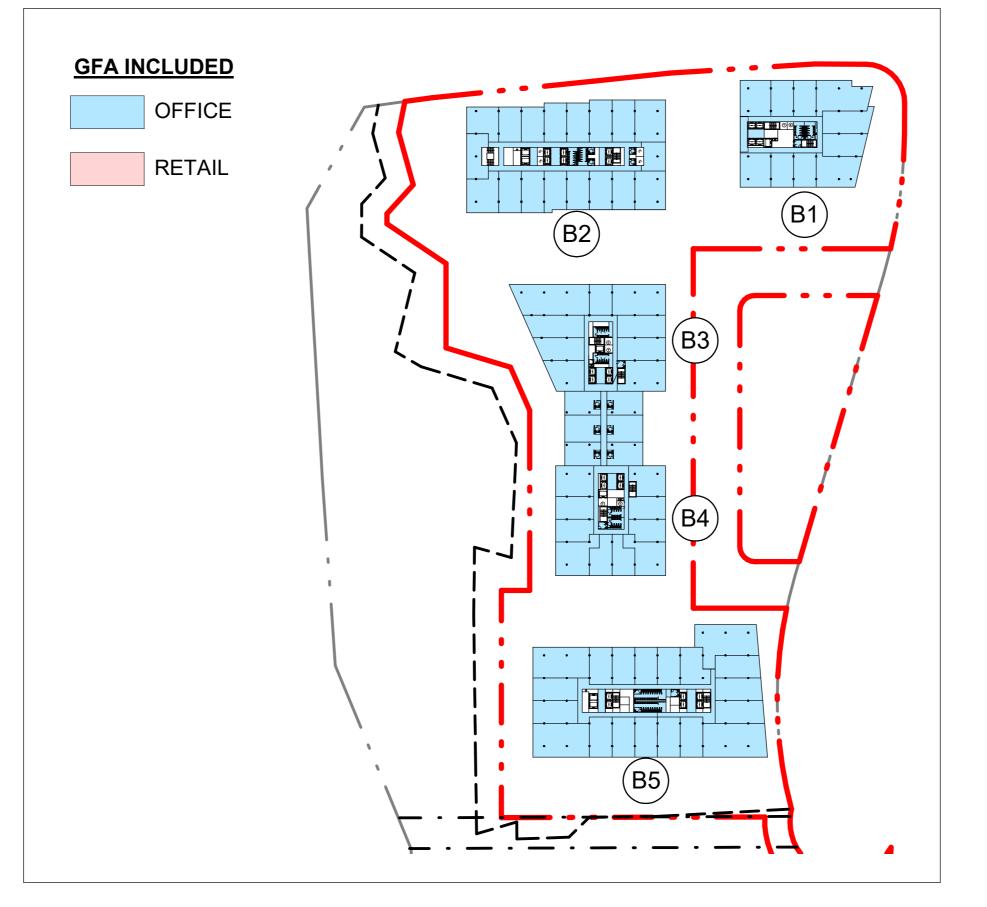
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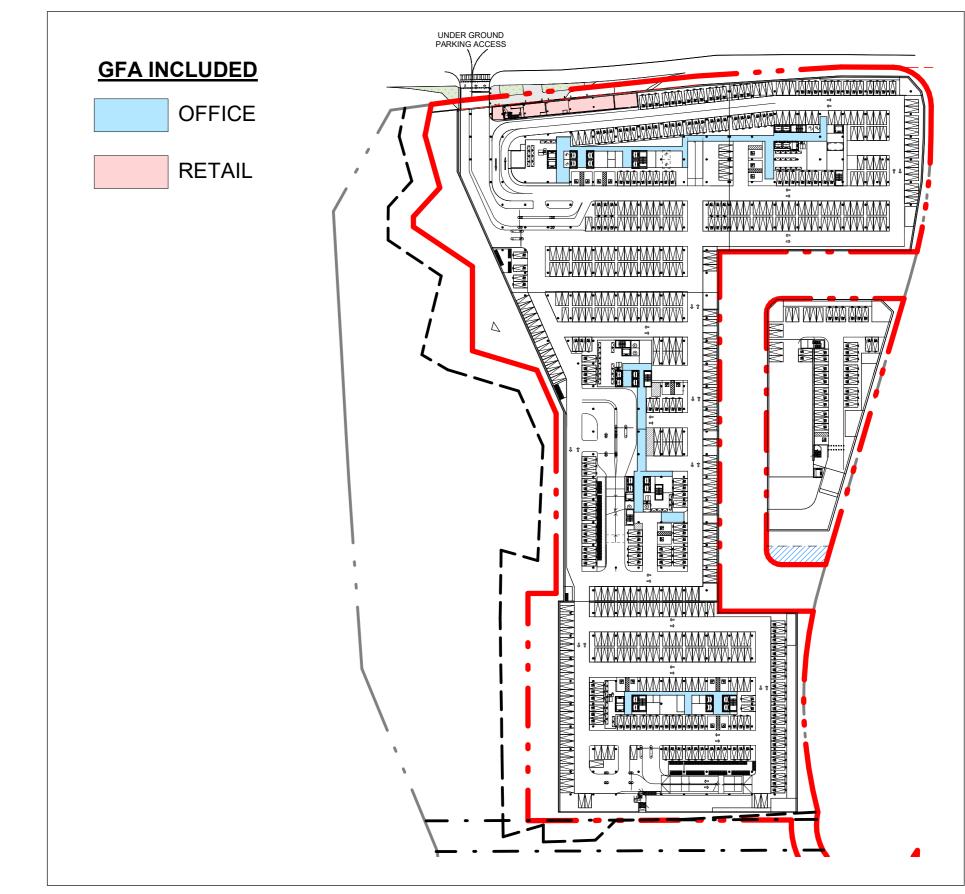
Drawing Title
SITE STATISTICS

ONBL 18-0225 A00-03












A00-04

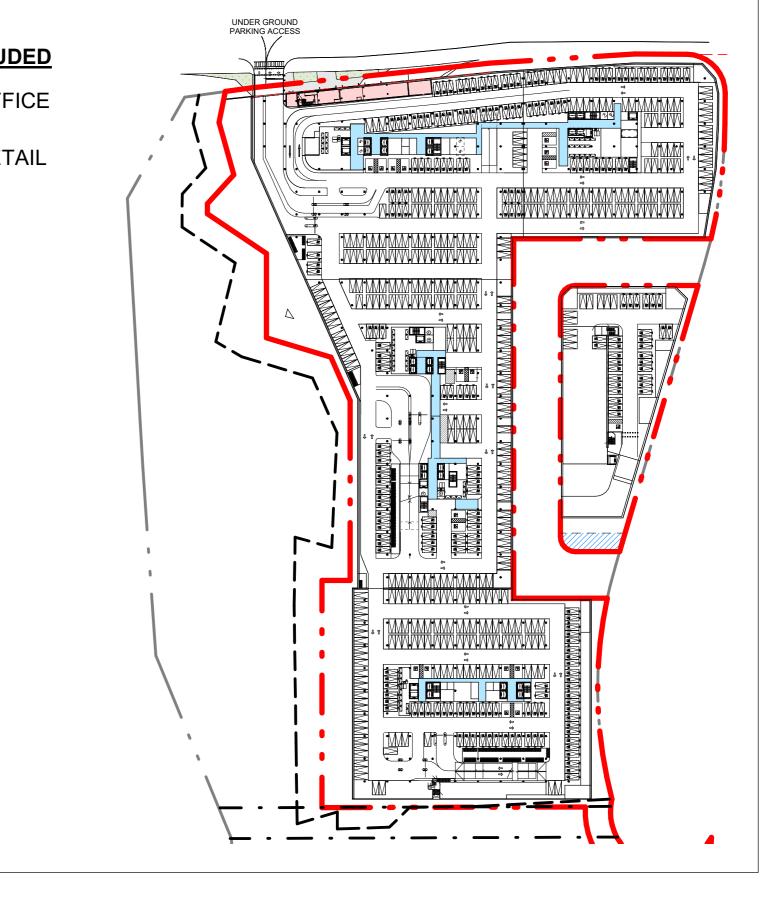

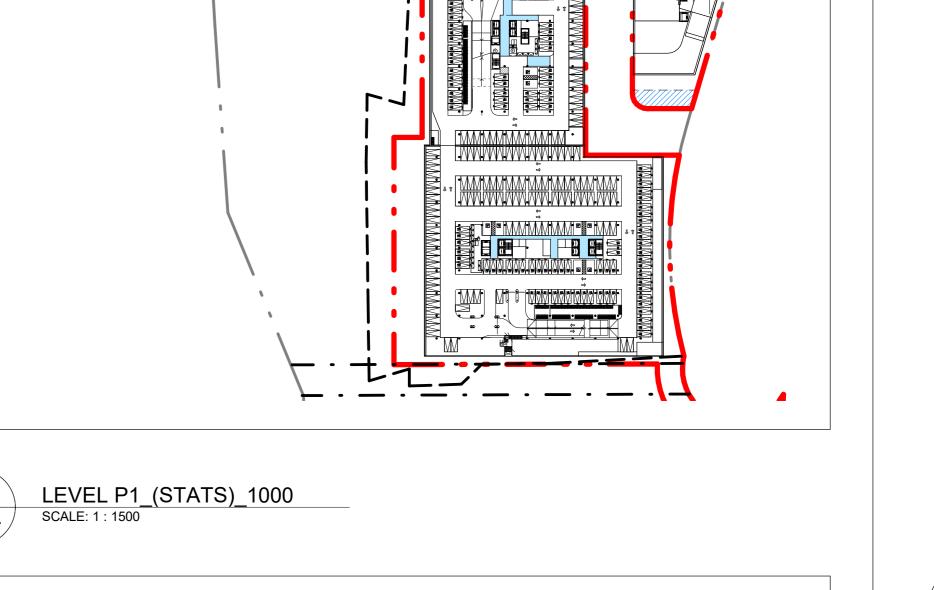




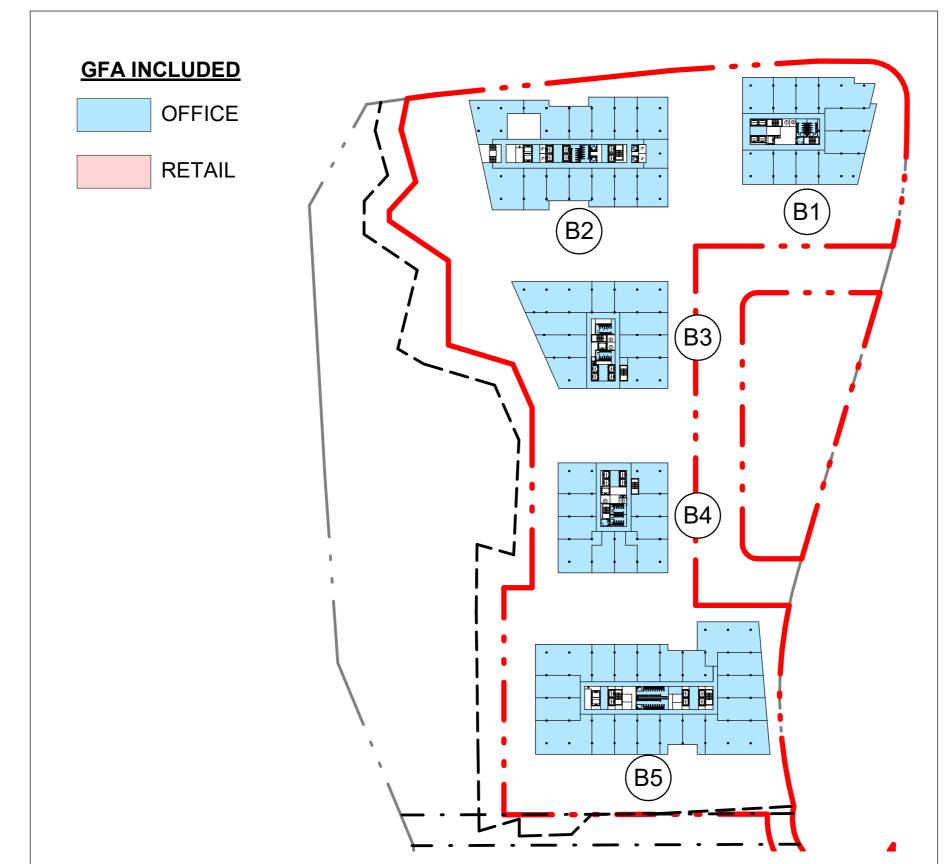


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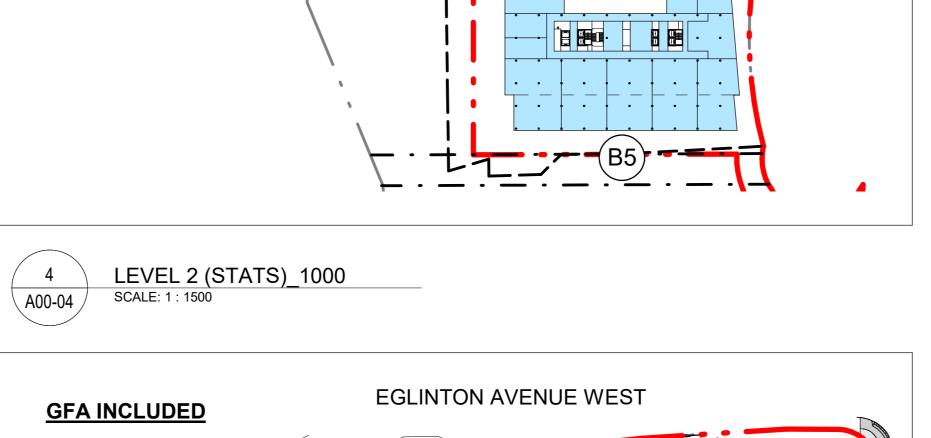
LEVEL 5 (STATS)\_1000 SCALE: 1: 1500


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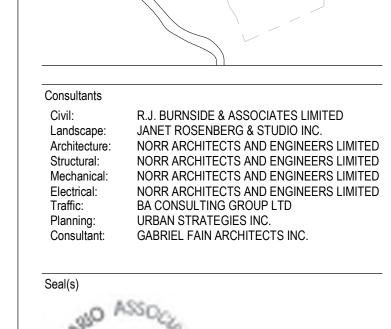


LEVEL 3 (STATS)\_1000 SCALE: 1: 1500

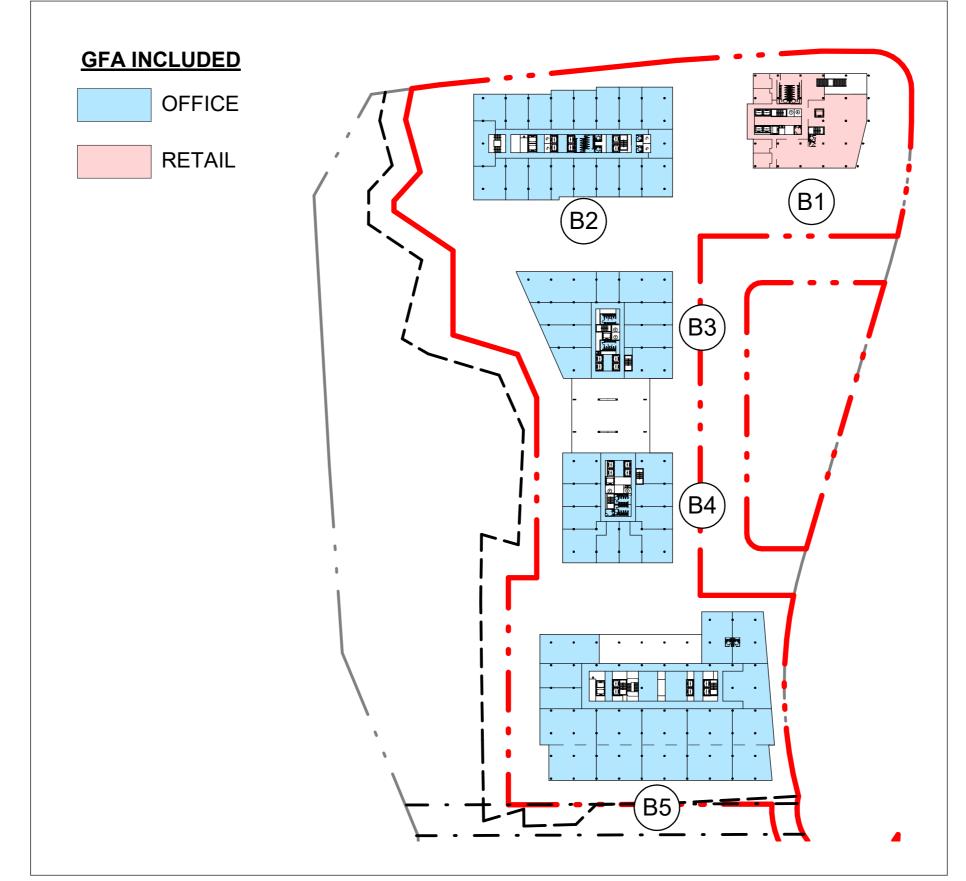



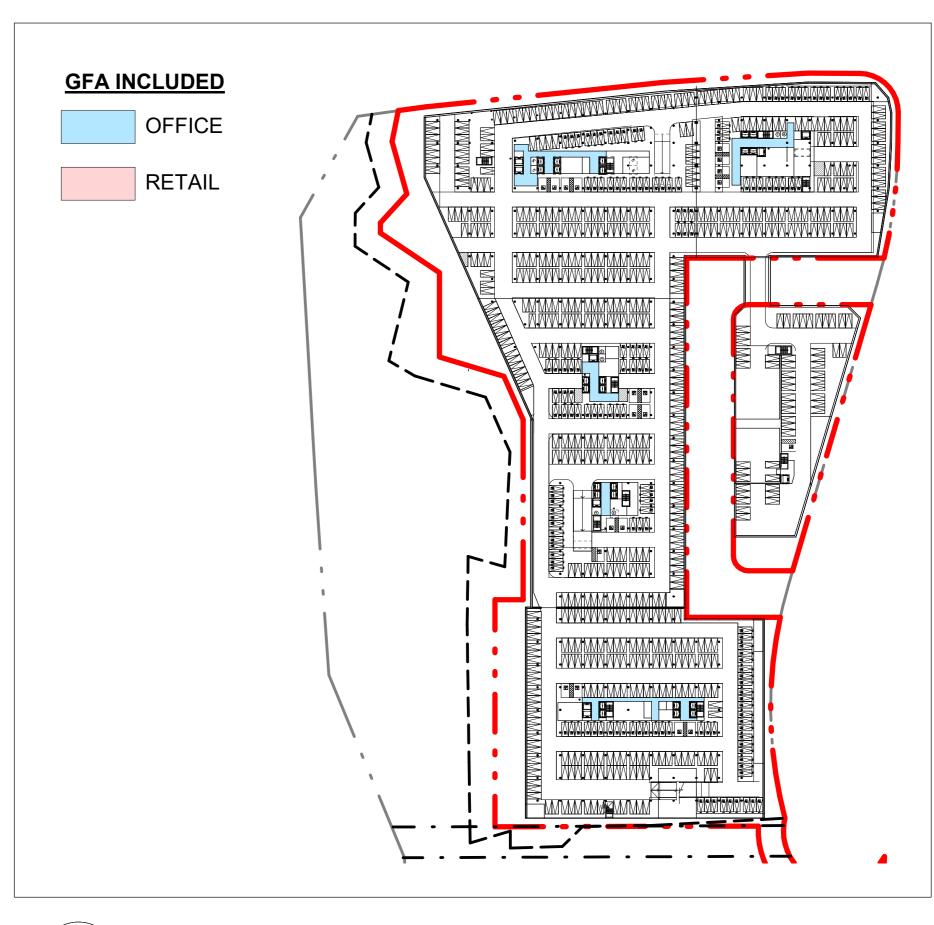

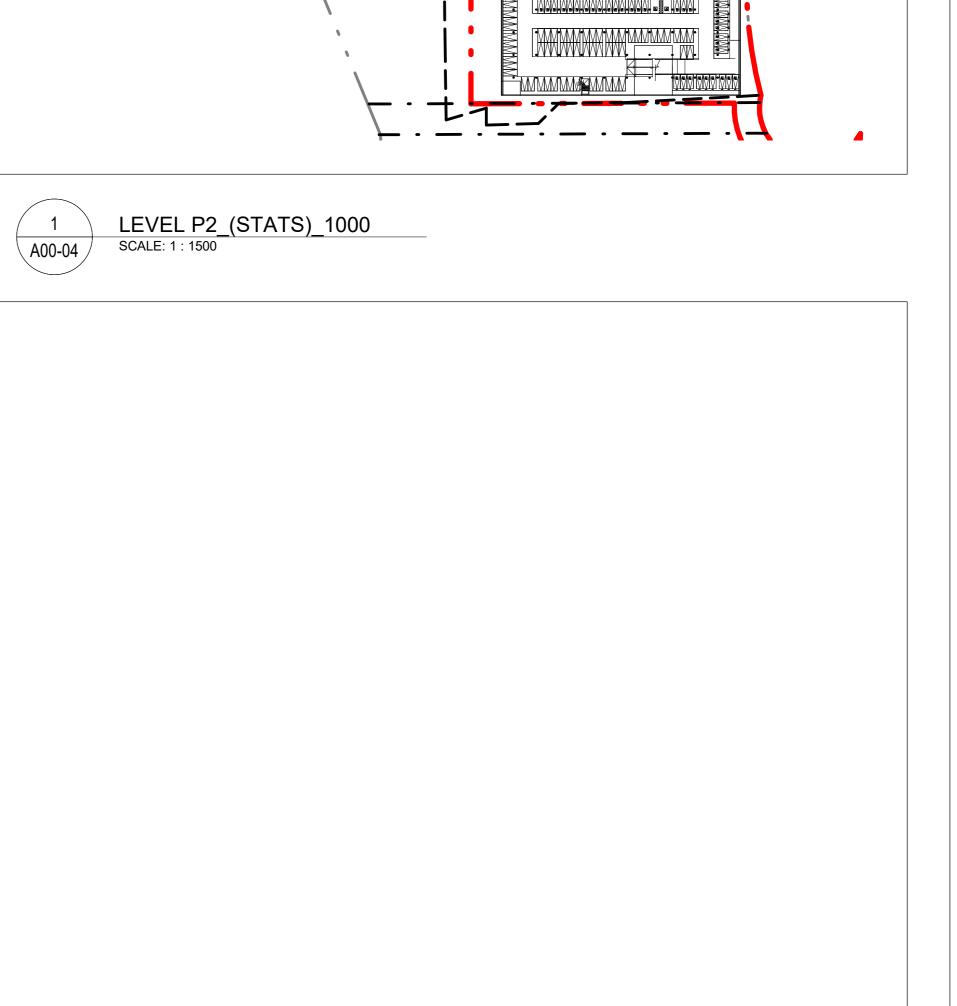

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Key Plan

**ISSUED FOR** 

ZONING BY-LAW AMENDMENT


ZONING BY-LAW AMENDMENT

ZONING BY-LAW AMENDMENT

2018-06-25

2021-01-15

2022-10-03

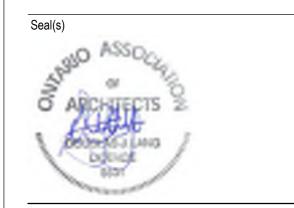



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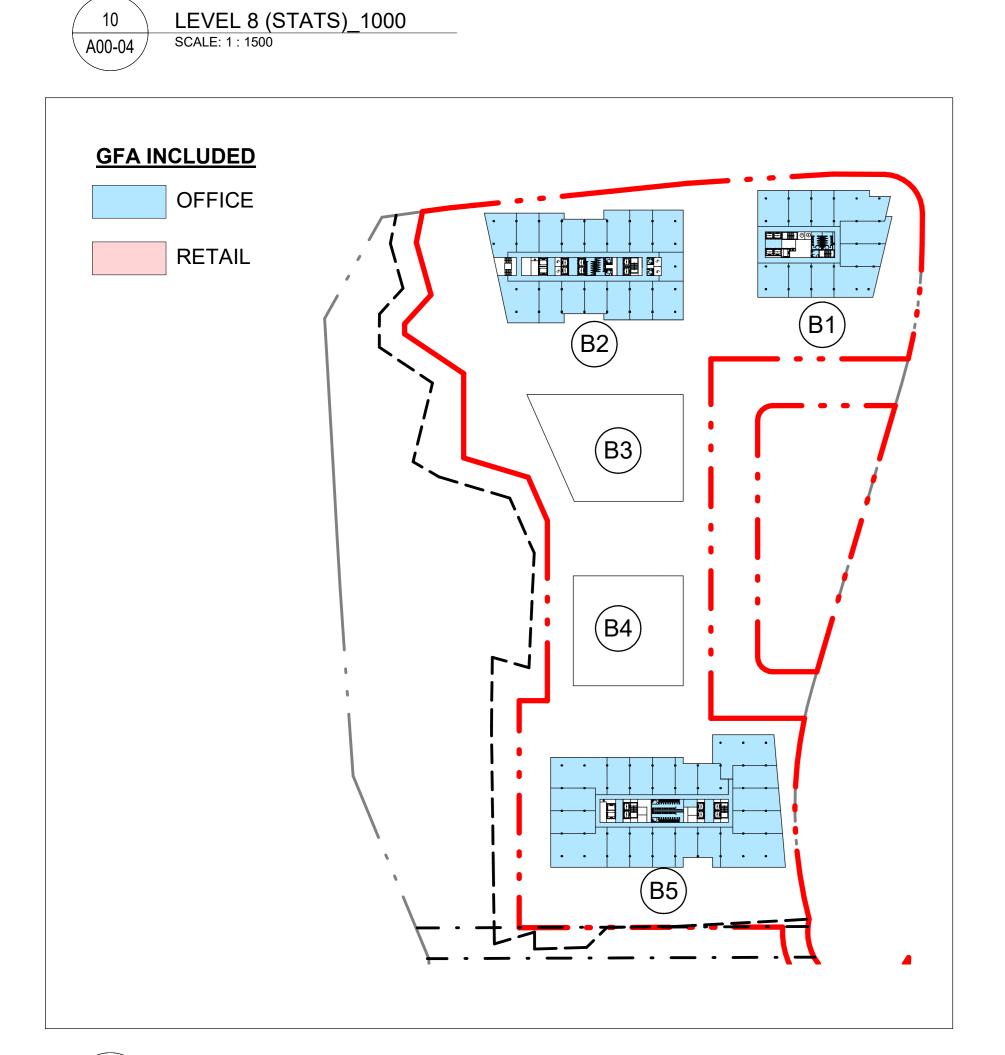
Rakely Eglinton Corporate Centre, Limited Partnership

40 RAKELY COURT, TORONTO, ON, M9C 5A5


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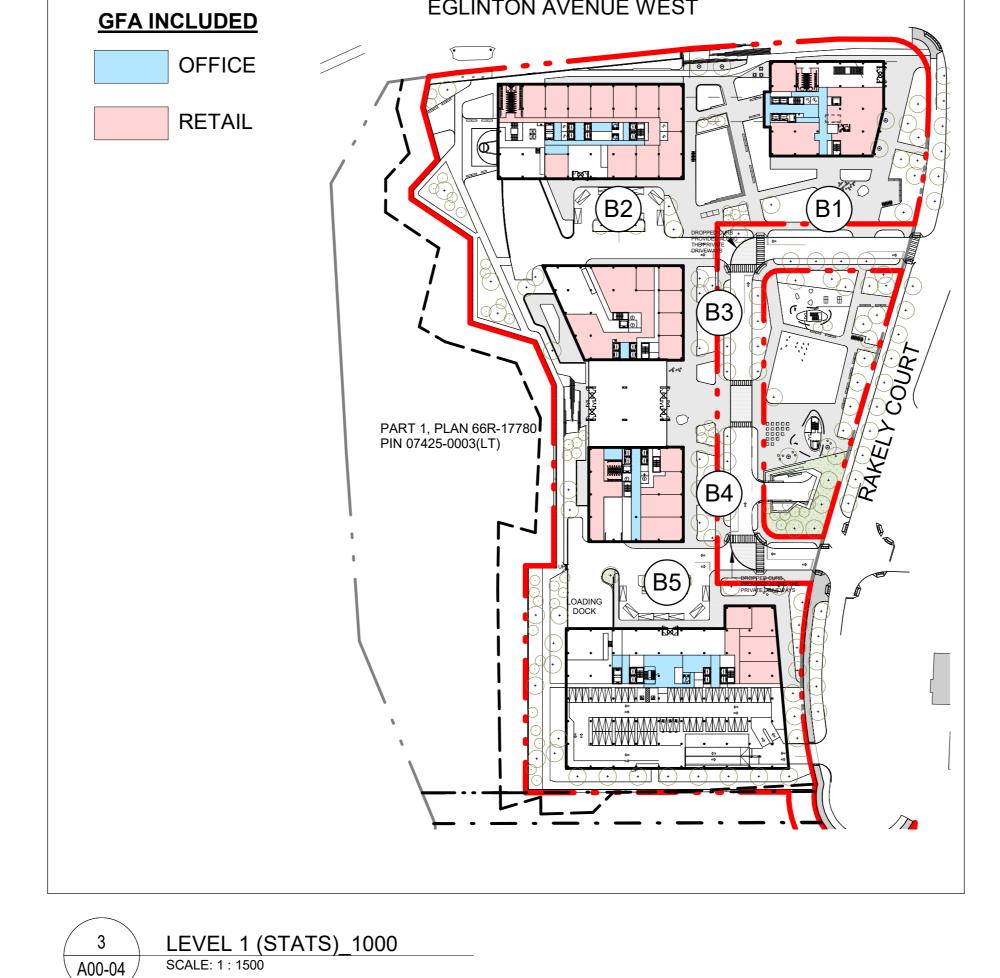
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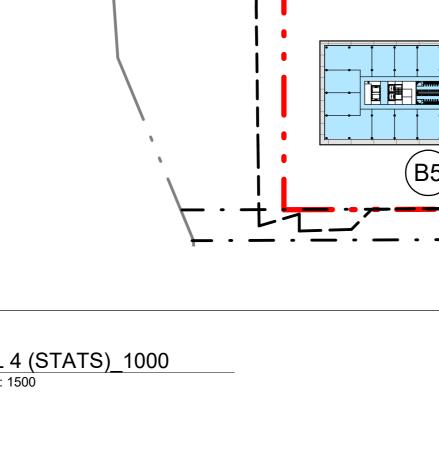
1:1500 Project No. ONBL 18-0225 Drawing No. A00-04




9 LEVEL 7 (STATS)\_1000 A00-04 SCALE: 1: 1500






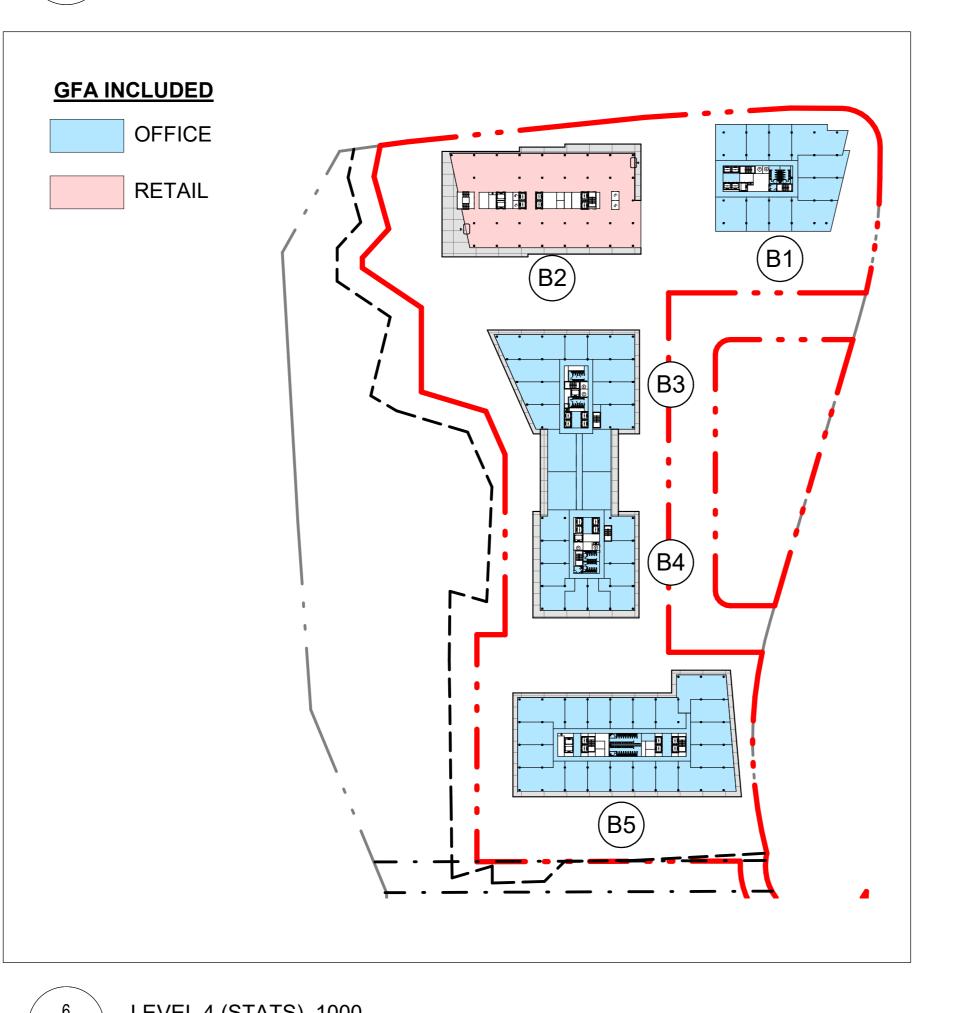


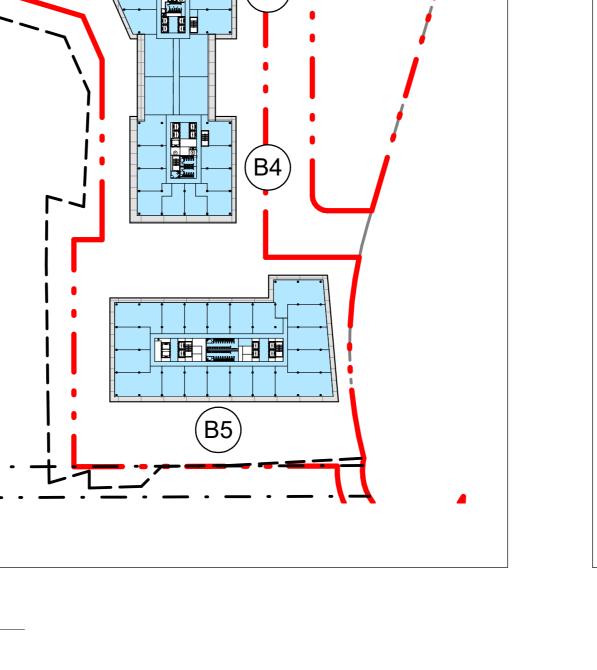



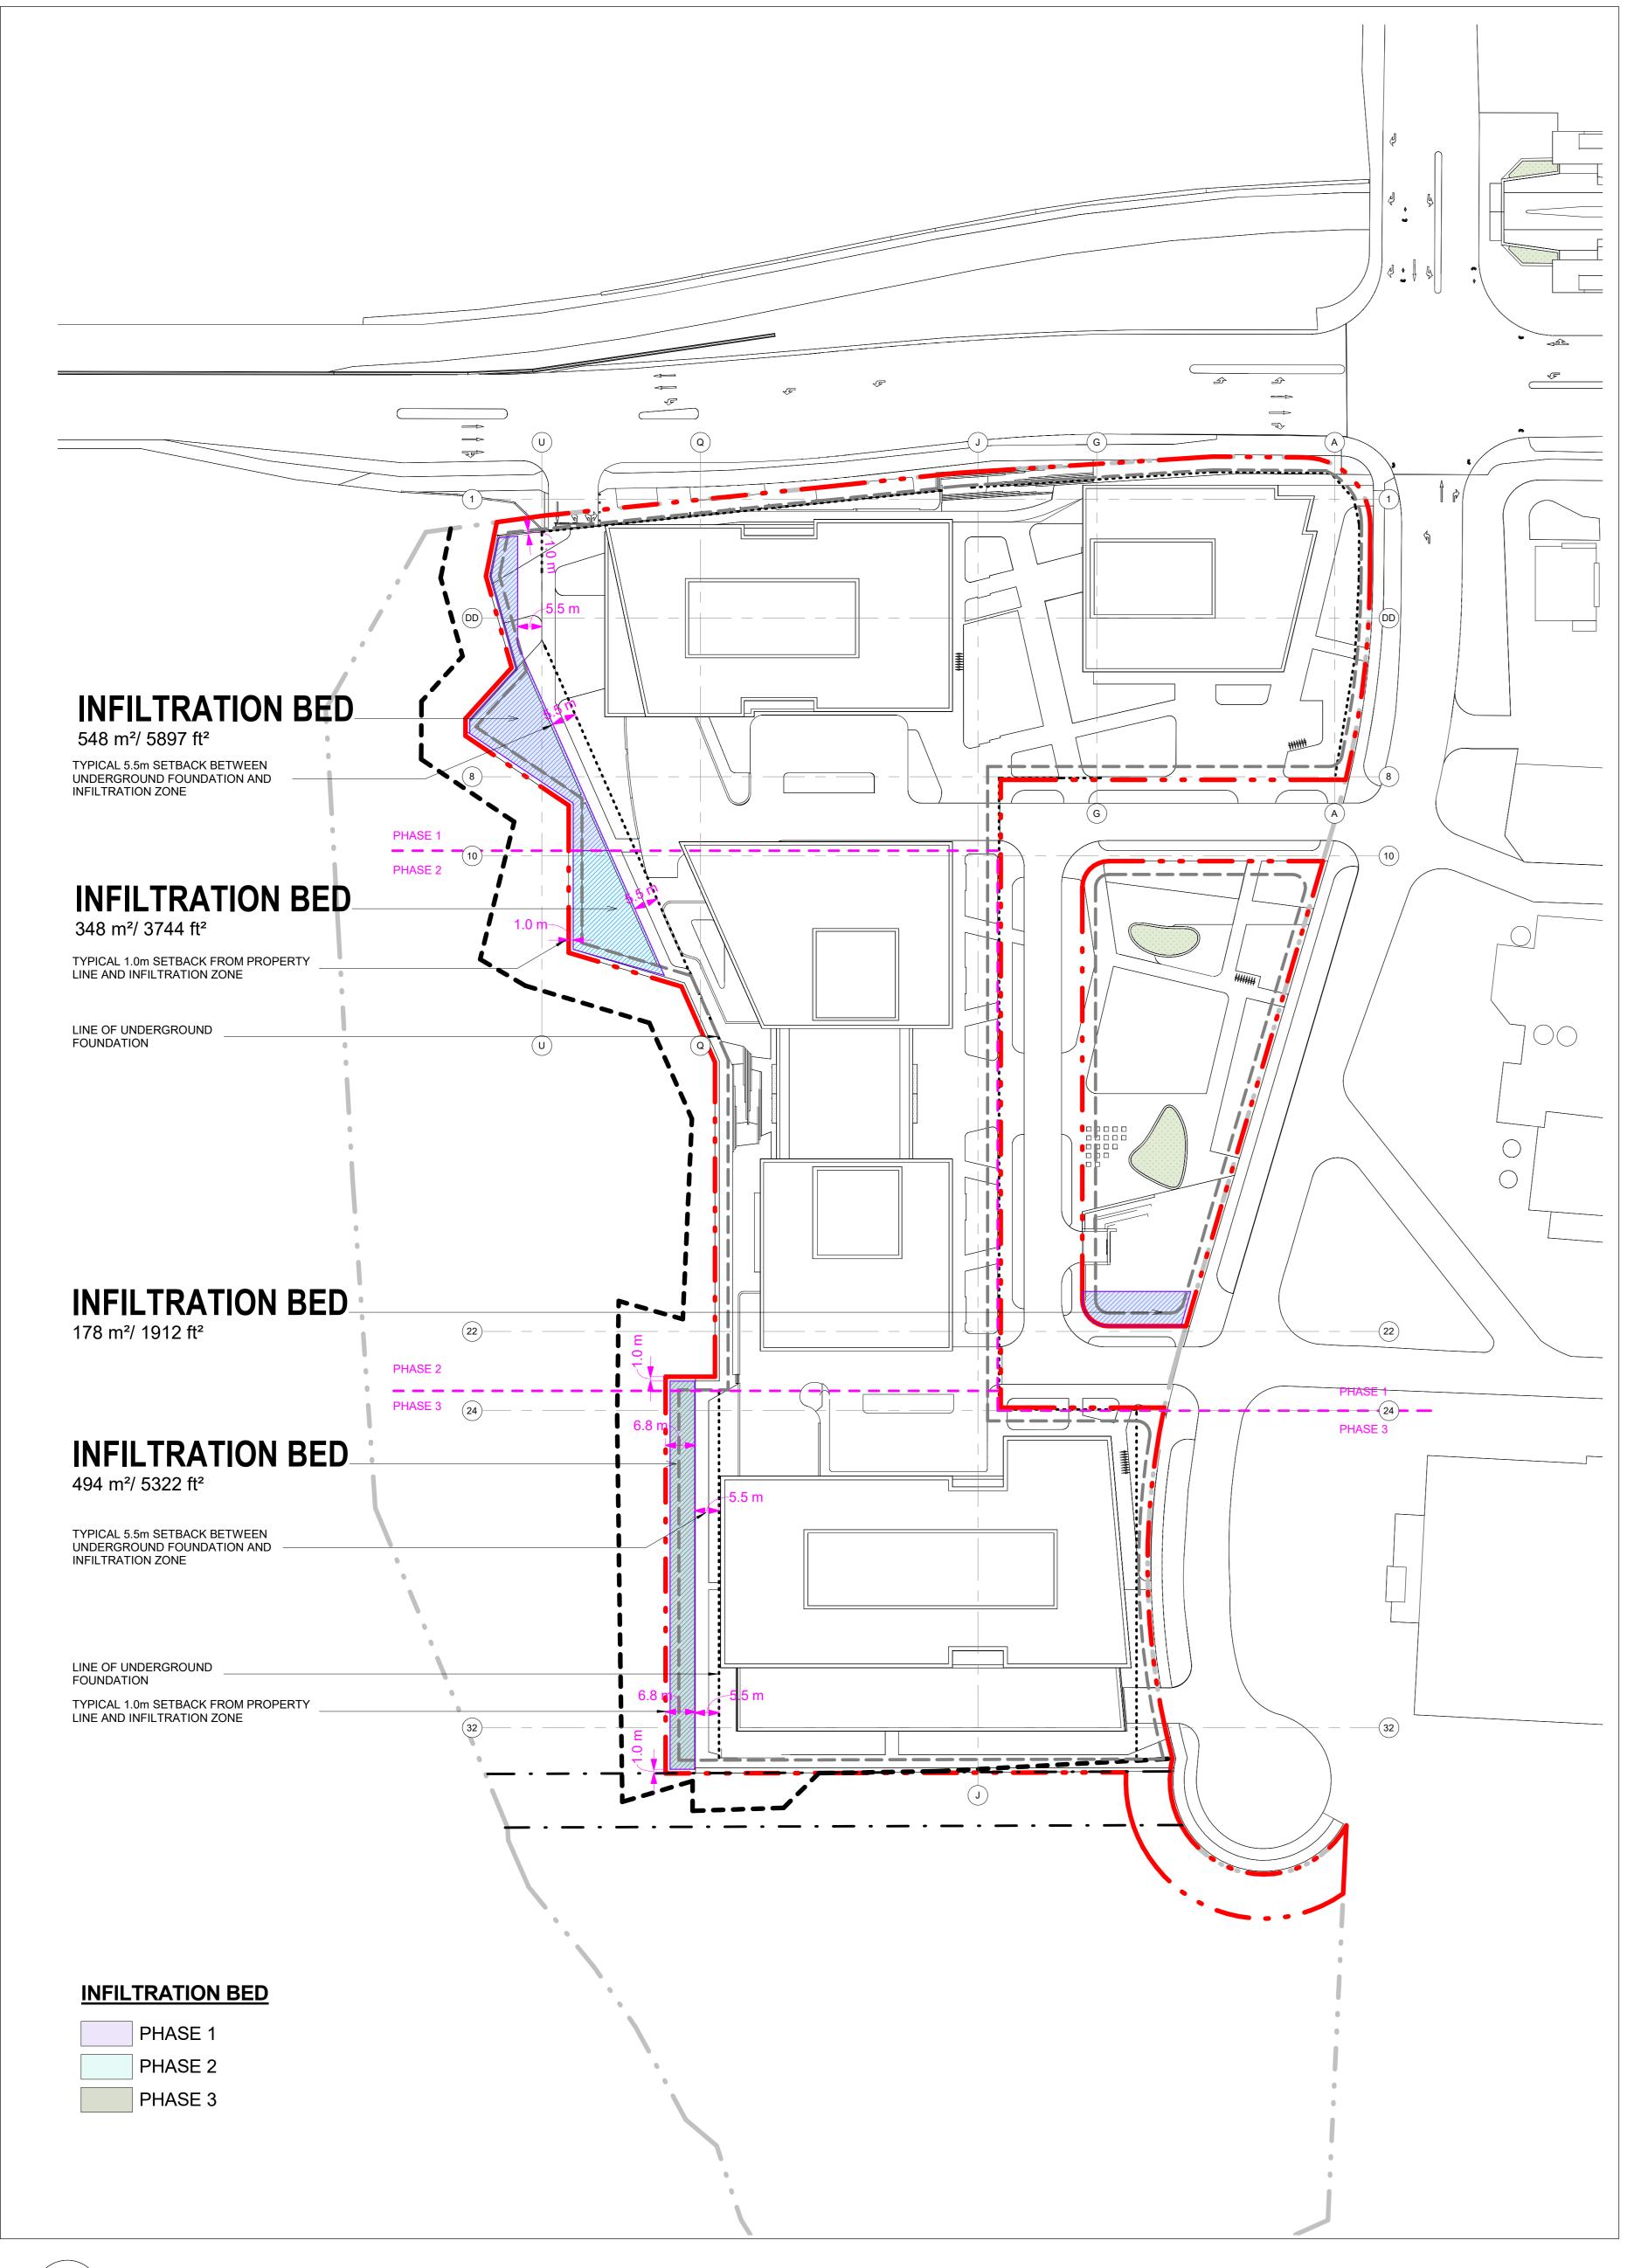




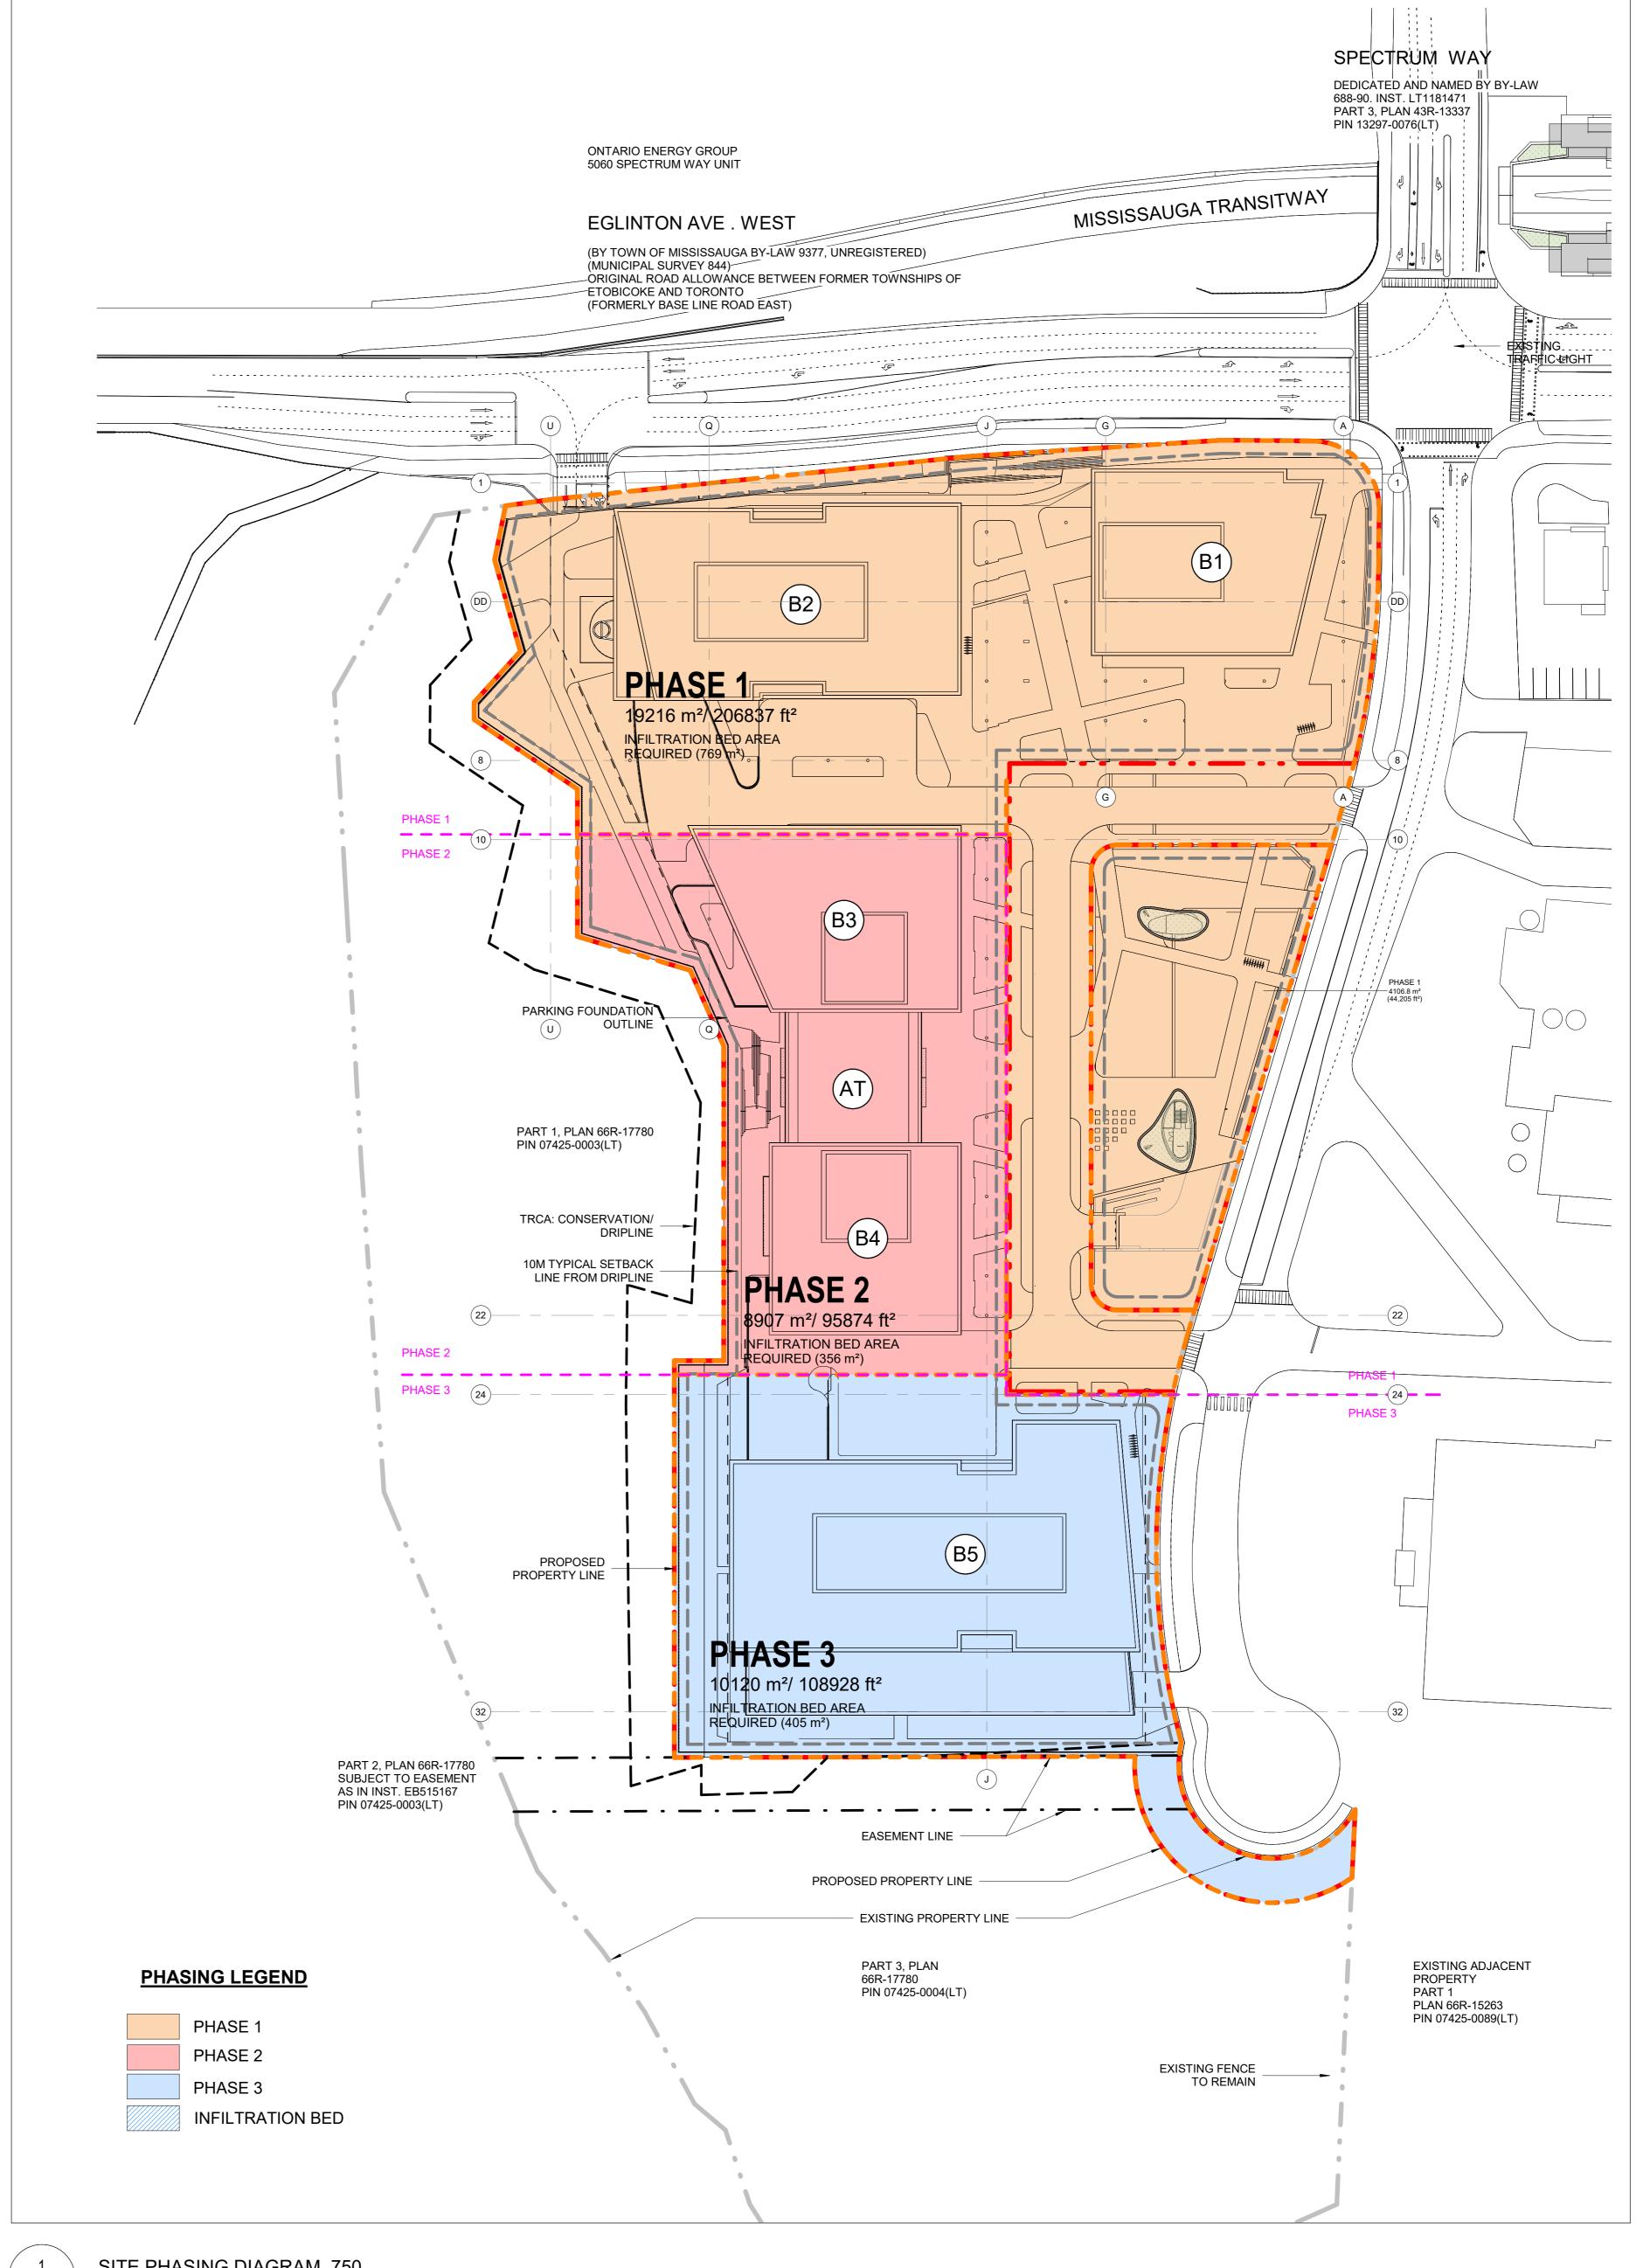




INFILTRATION REQUIREMENTS BY PHASE				
PHASING	SITE AREA (m²)			
PHASE 1	19,216 m²			
PHASE 1	4,107 m <sup>2</sup>			
PHASE 2	8,907 m <sup>2</sup>			
PHASE 3	10,120 m <sup>2</sup>			
TOTAL SITE AREA	42,349 m <sup>2</sup>			


NFILTRATION ZONES INFILTRATION PROVIDED BY PHASE				
HASING	AREA (m²)			
PHASE 1	725 m²			
PHASE 2	348 m²			
PHASE 3	494 m²			
OTAL INFILTRATION AREA/SWALE	1,568 m²			

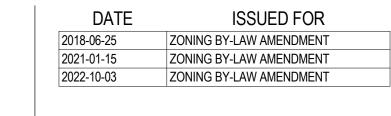

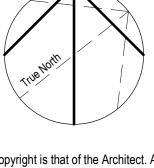


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Landscape: JANET ROSENBERG & STUDIO INC.
Architecture: NORR ARCHITECTS AND ENGINEERS LIMITED
Structural: NORR ARCHITECTS AND ENGINEERS LIMITED
Mechanical: NORR ARCHITECTS AND ENGINEERS LIMITED
Electrical: NORR ARCHITECTS AND ENGINEERS LIMITED
Traffic: BA CONSULTING GROUP LTD
Planning: URBAN STRATEGIES INC.
Consultant: GABRIEL FAIN ARCHITECTS INC.

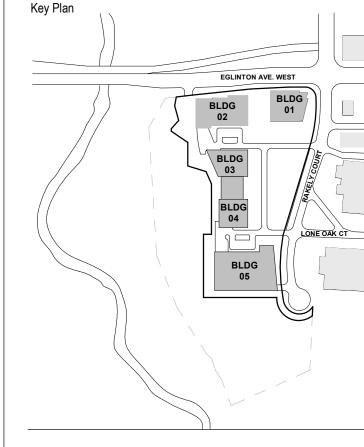

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Toronto, ON Canada M4W 3R8

Rakely Eglinton Corporate
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40 RAKELY COURT, TORONTO, ON, M9C 5A5

Drawing Title
PHASING DIAGRAM

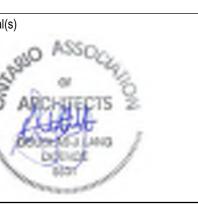1 : 750


Project No.

ONBL 18-0225

Drawing No.

A00-05



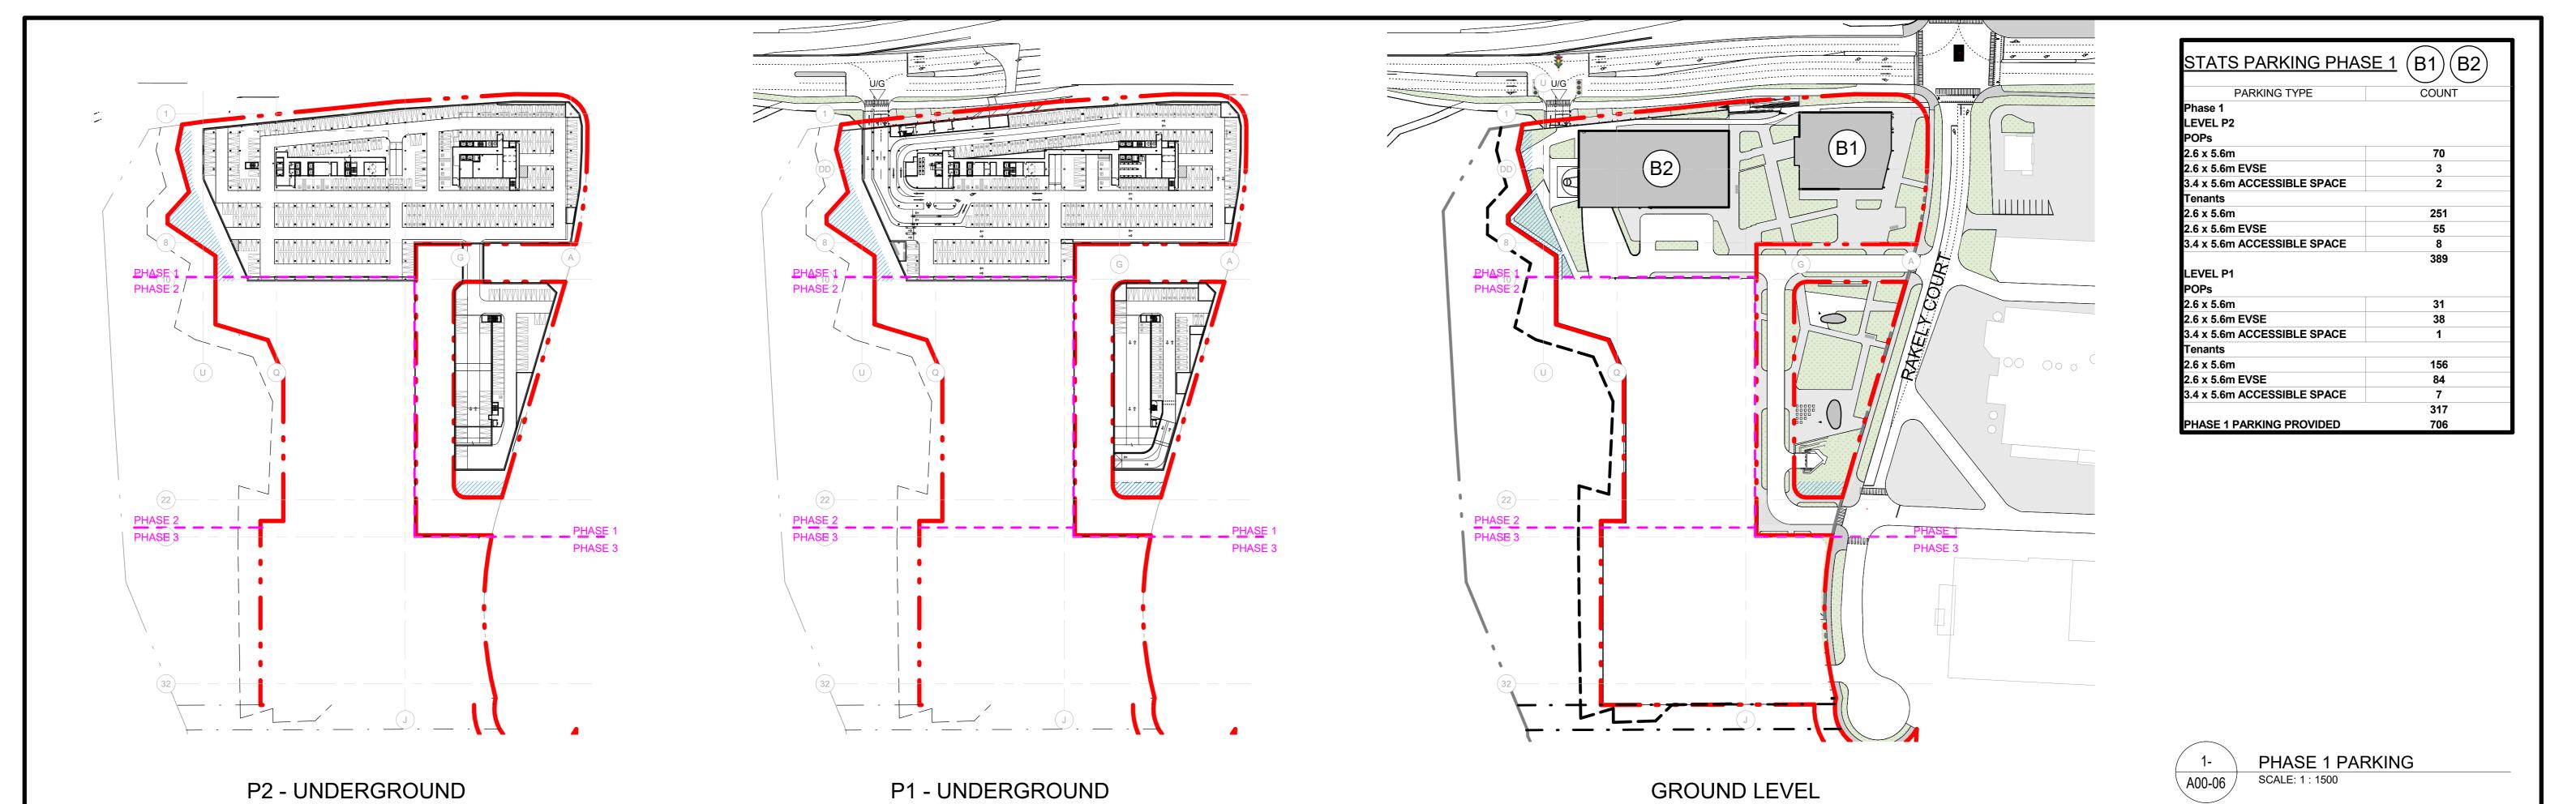


DATE ISSUED FOR

2018-06-25 ZONING BY-LAW AMENDMENT
2021-01-15 ZONING BY-LAW AMENDMENT
2022-10-03 ZONING BY-LAW AMENDMENT

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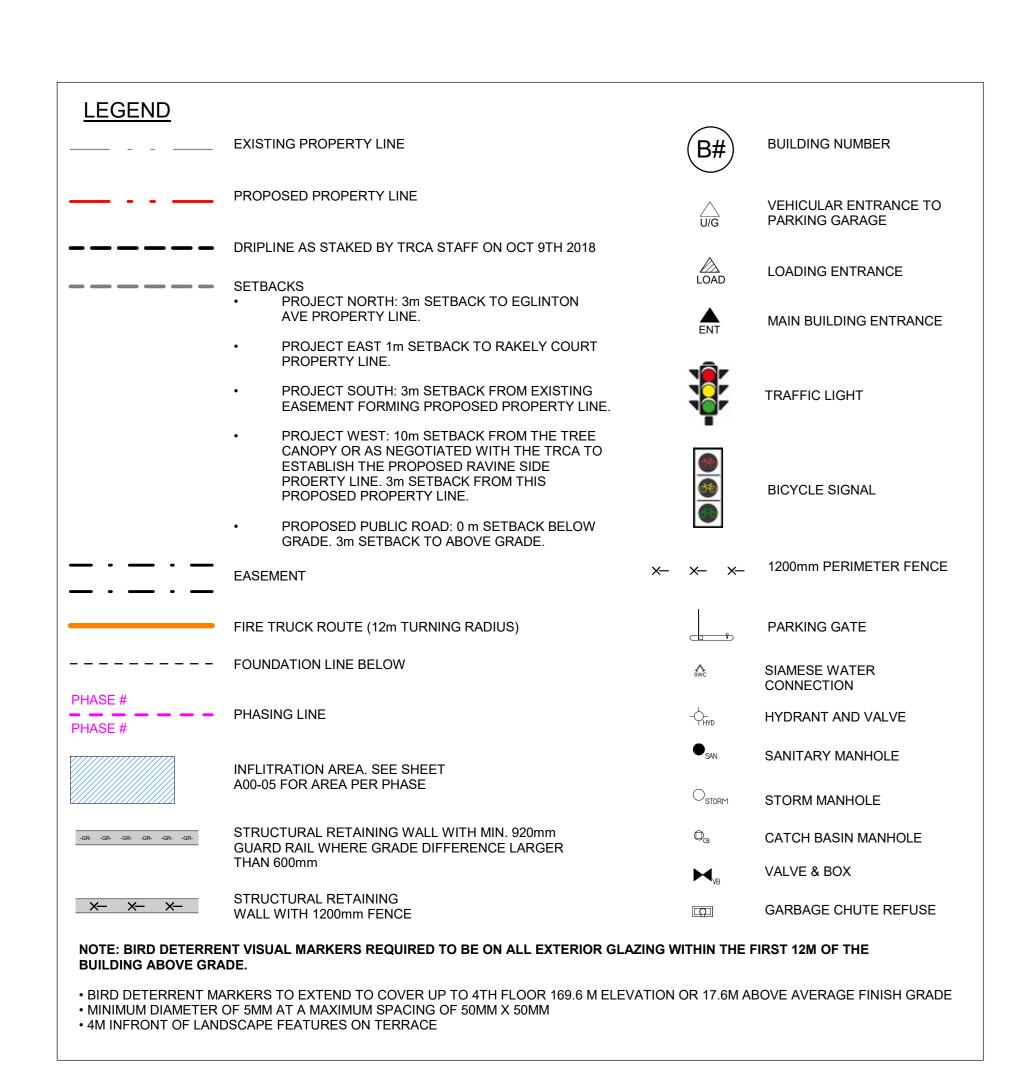
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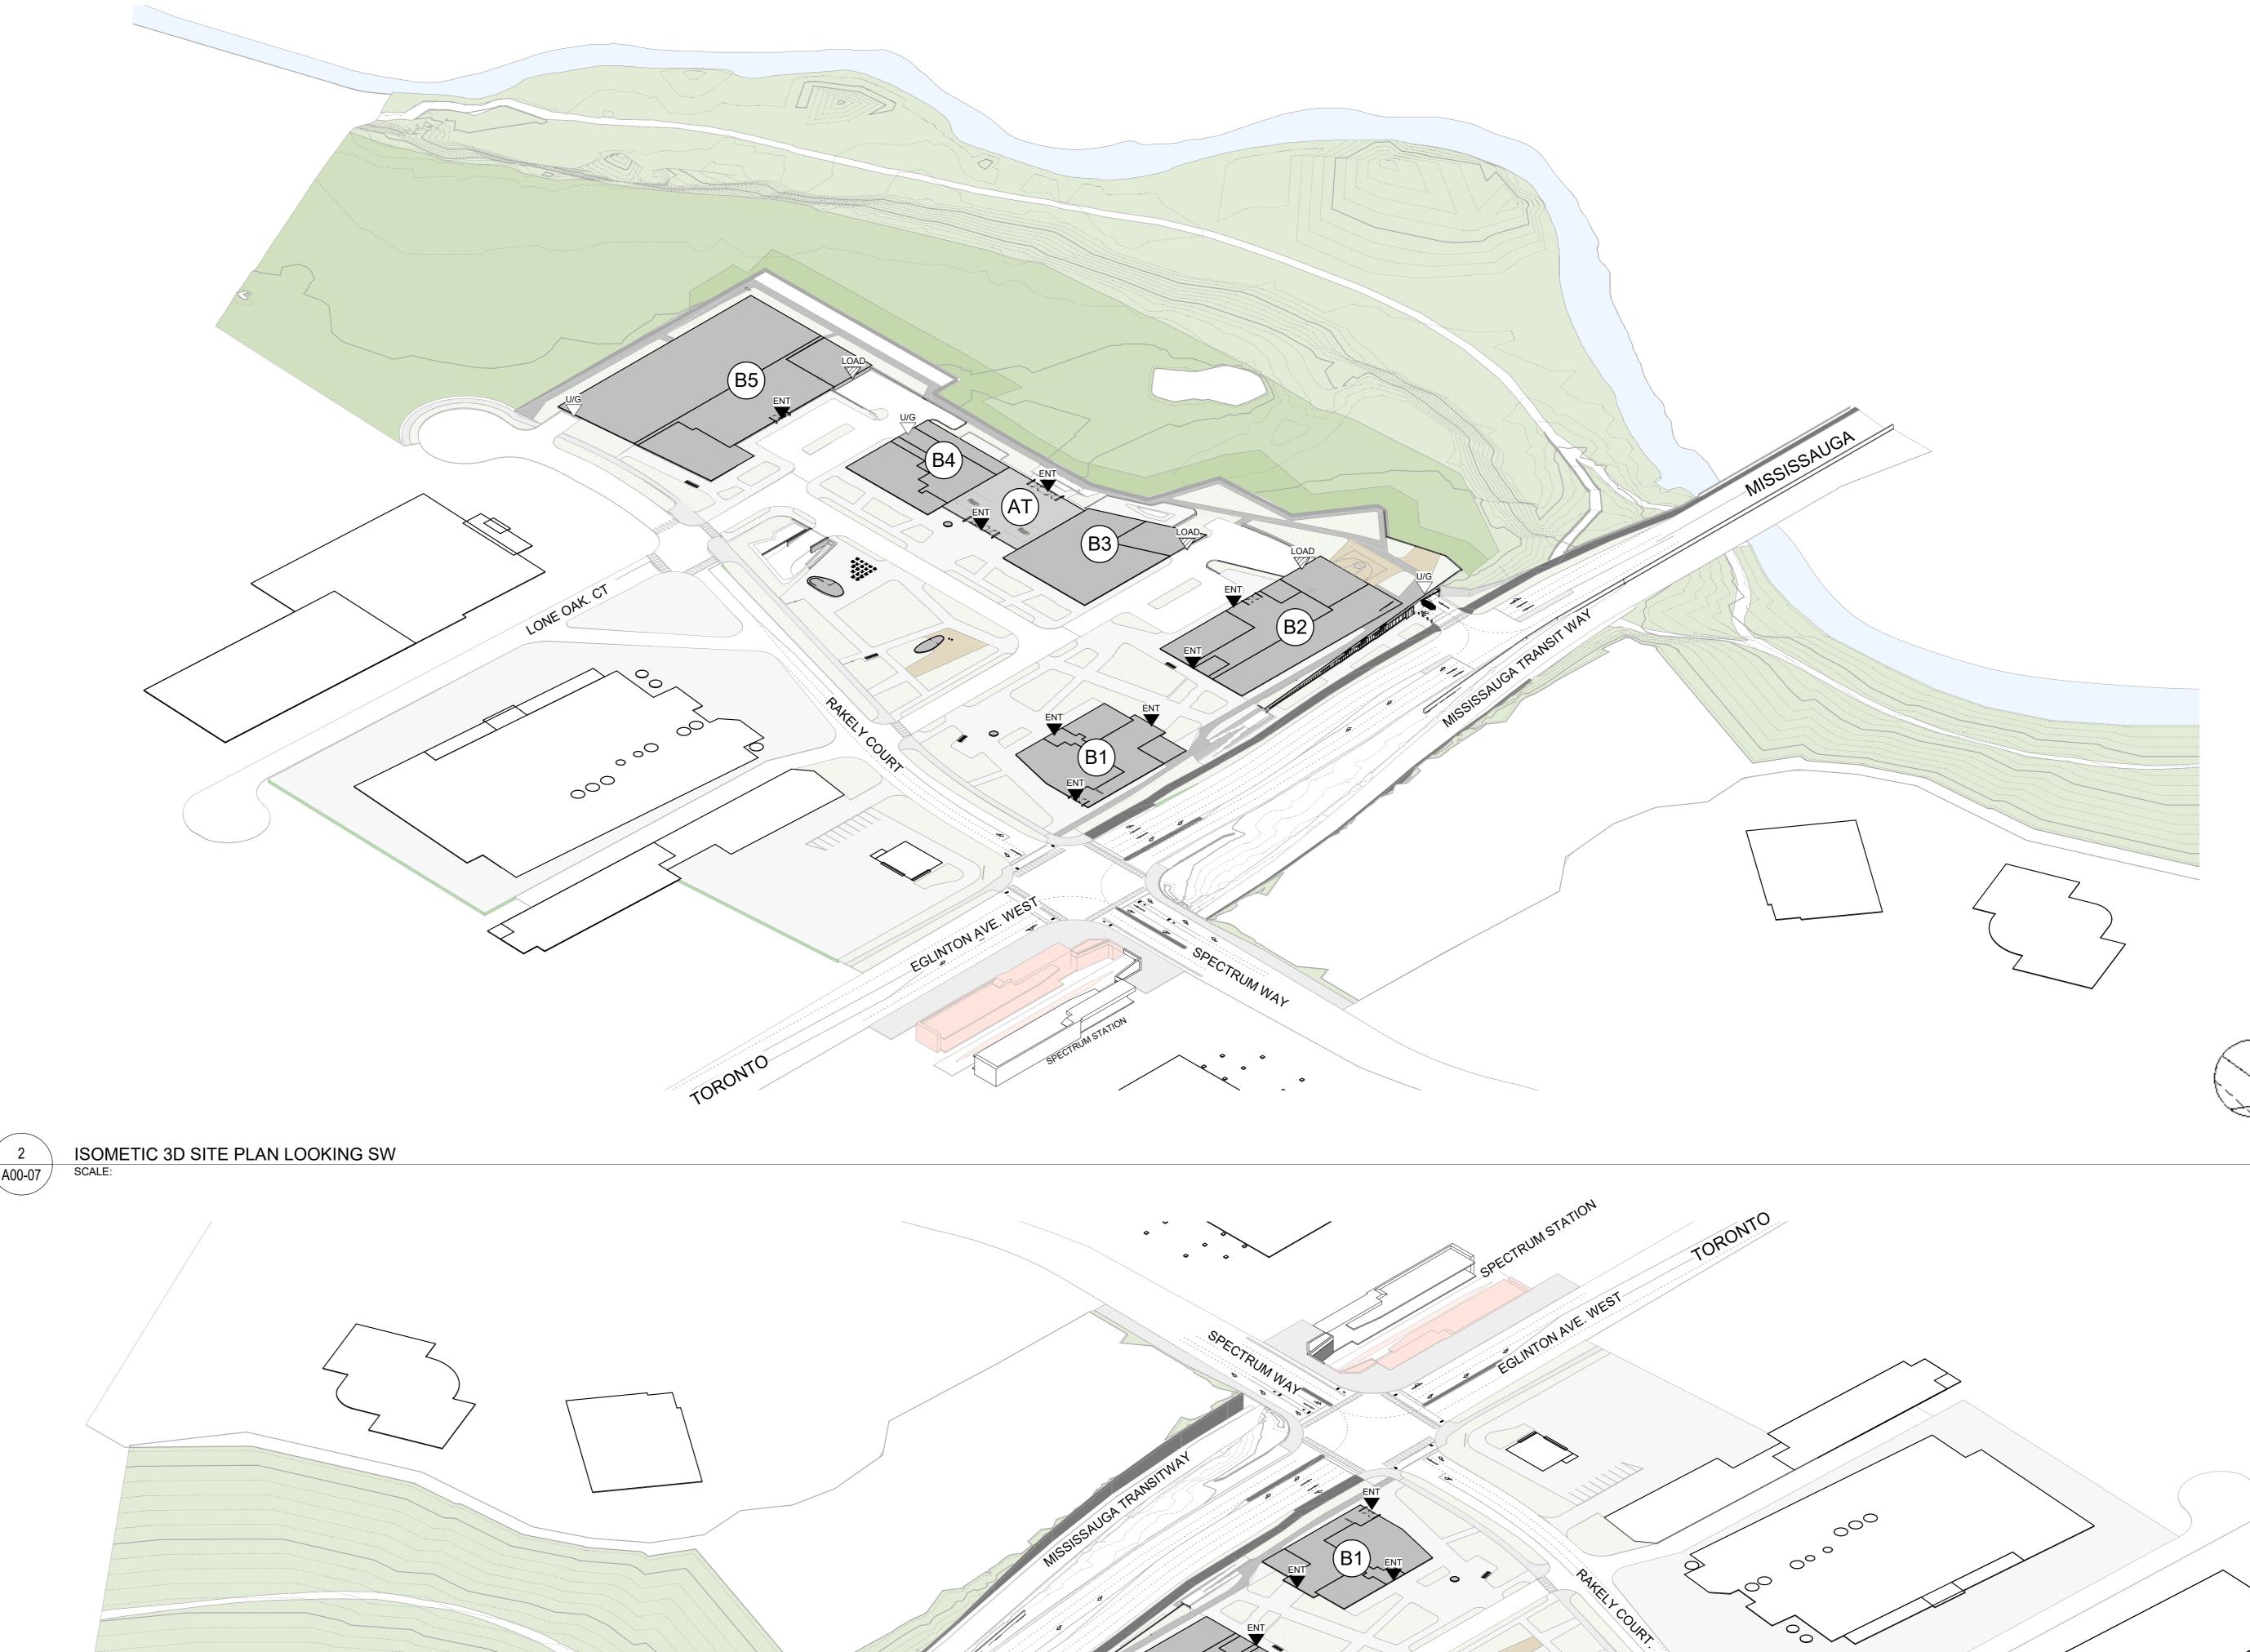
Rakely Eglinton Corporate Centre, Limited Partnership


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Drawing Title
PARKING PHASING

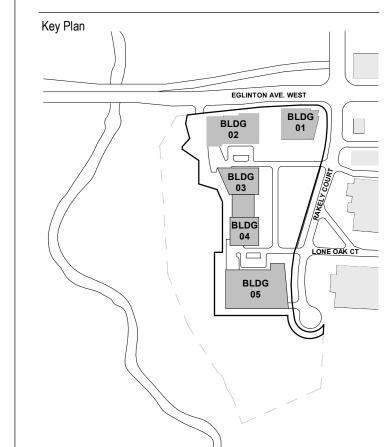Scale	
	1 : 1500
Project No.	
	ONBL 18-0225
Drawing No.	100.00
	A00-06






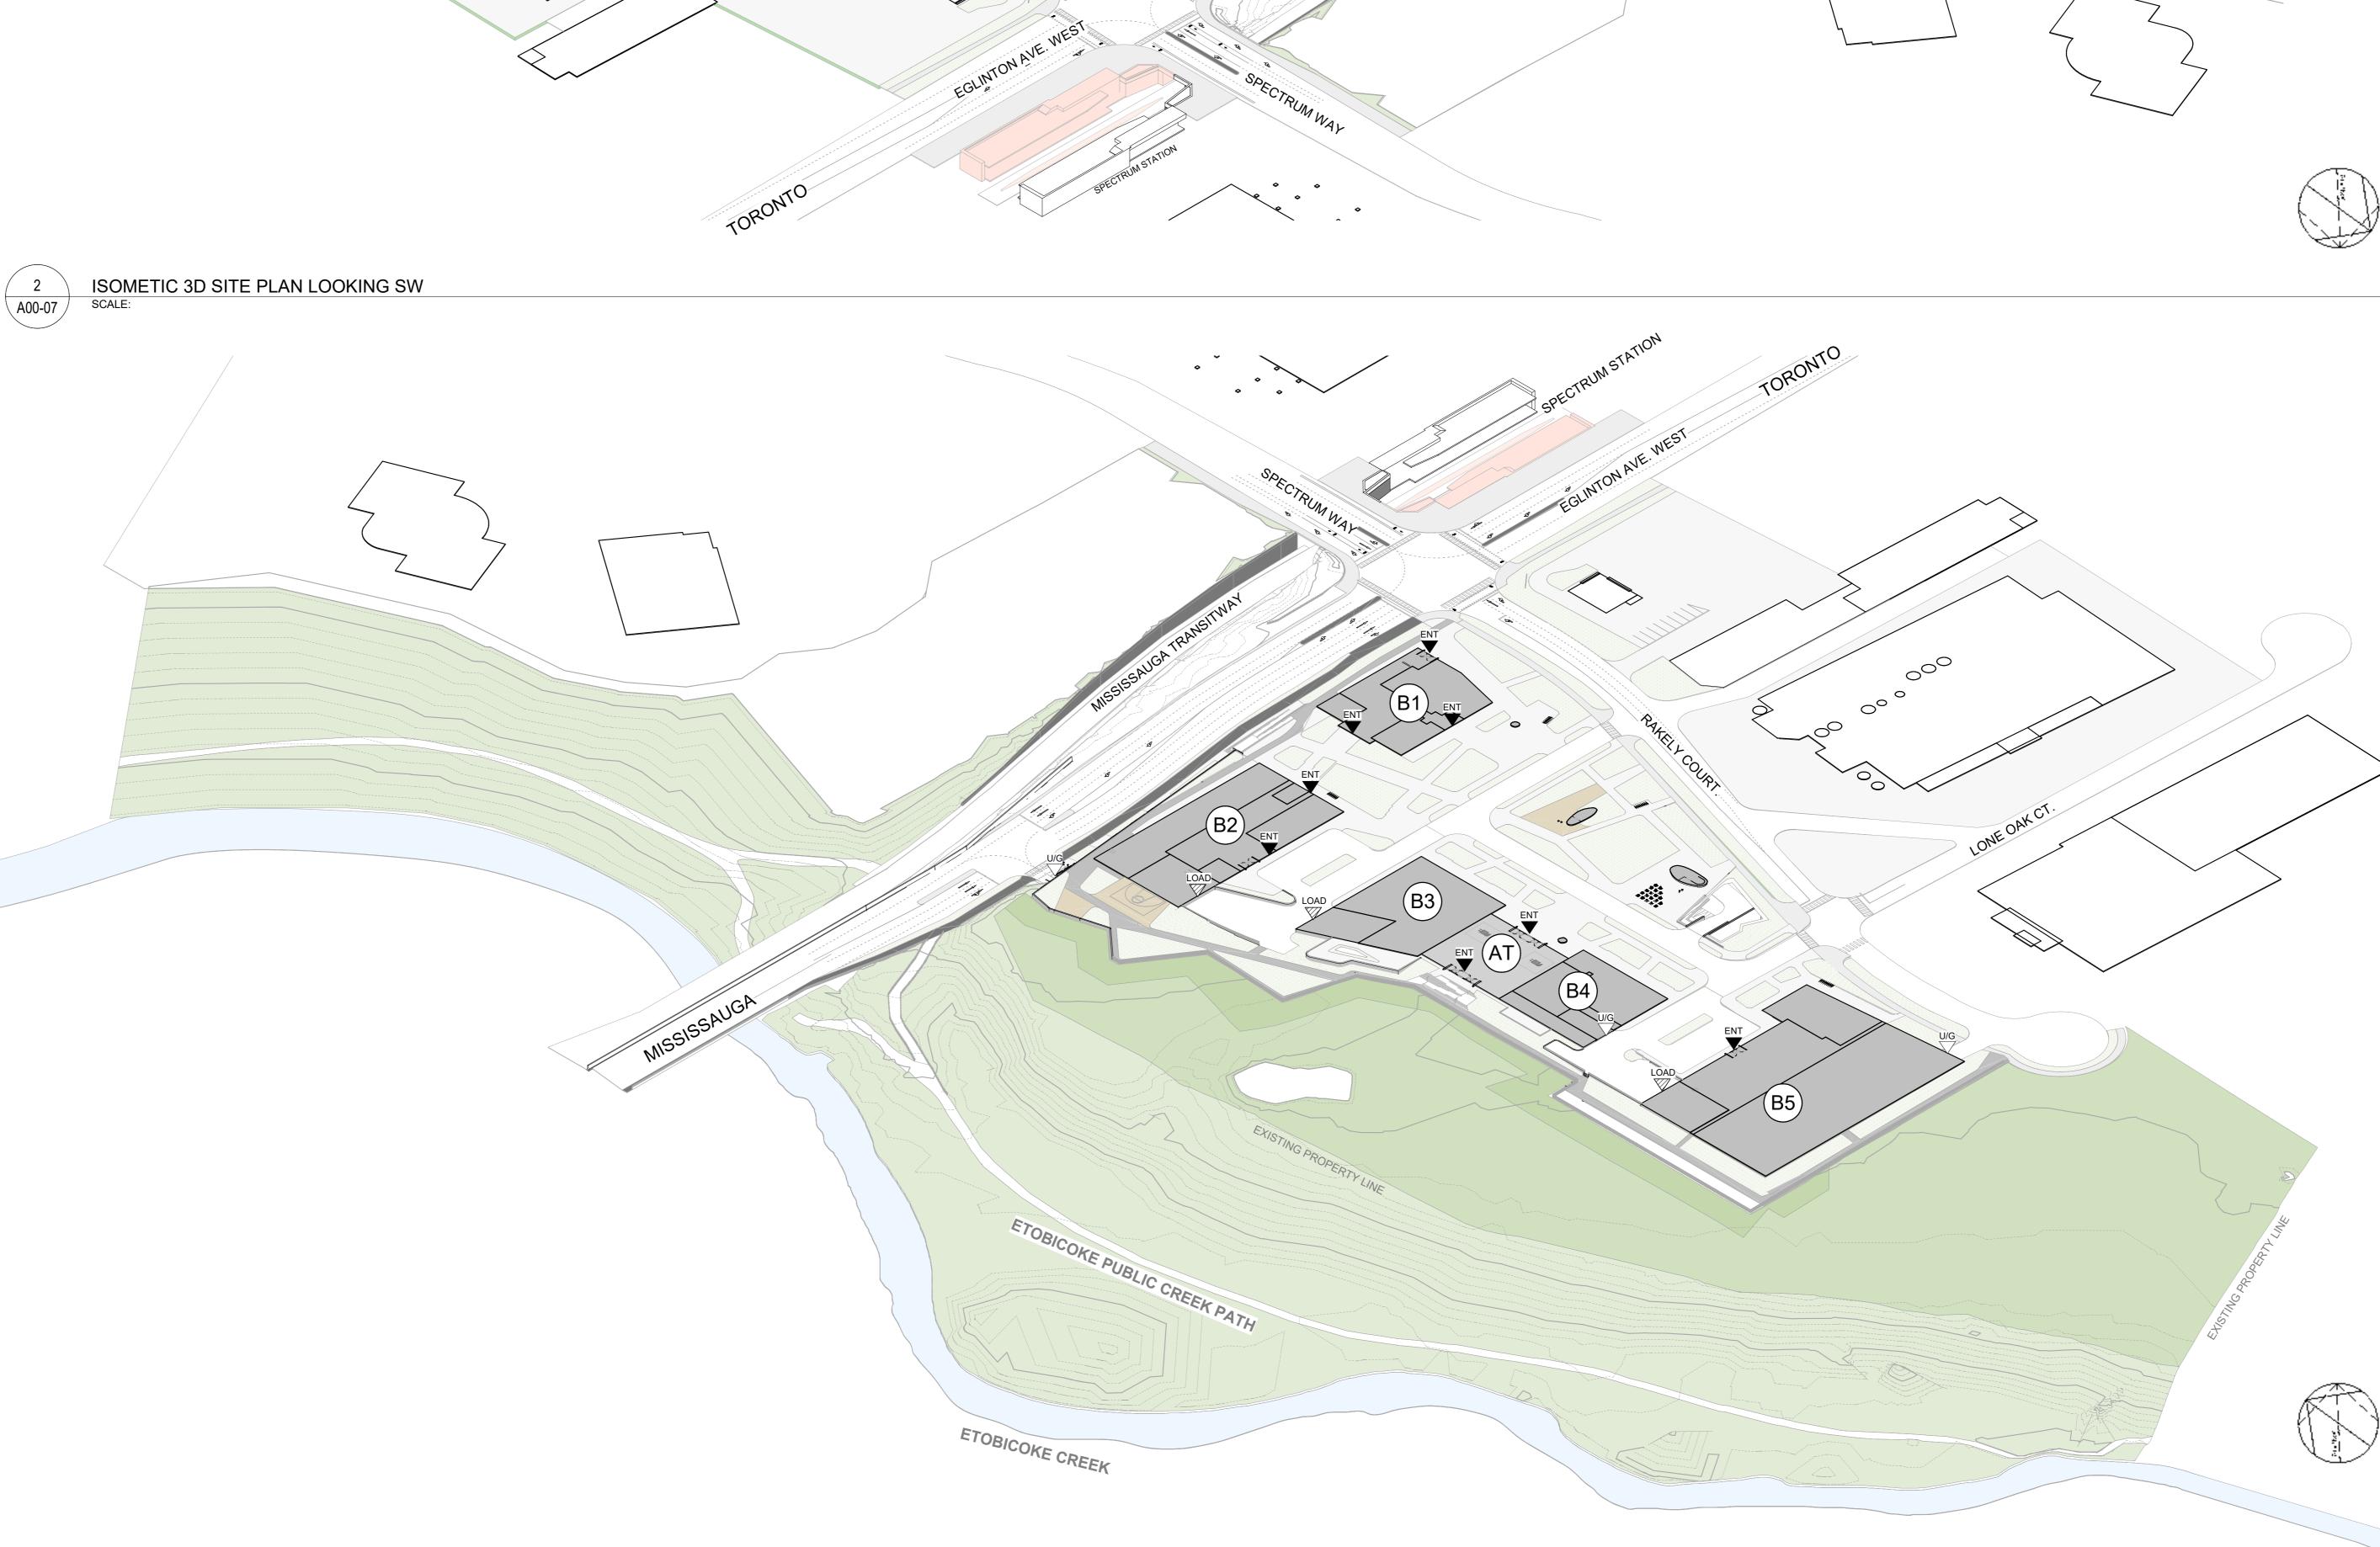

ZONING BY-LAW AMENDMENT CONSULTANT REVIEW 2022-02-04 2022-10-03 ZONING BY-LAW AMENDMENT

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BA CONSULTING GROUP LTD
URBAN STRATEGIES INC. Architecture: Structural: Mechanical: Electrical: Traffic: Planning: Consultant: GABRIEL FAIN ARCHITECTS INC.

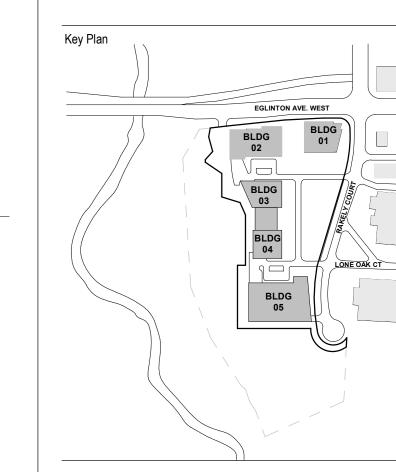

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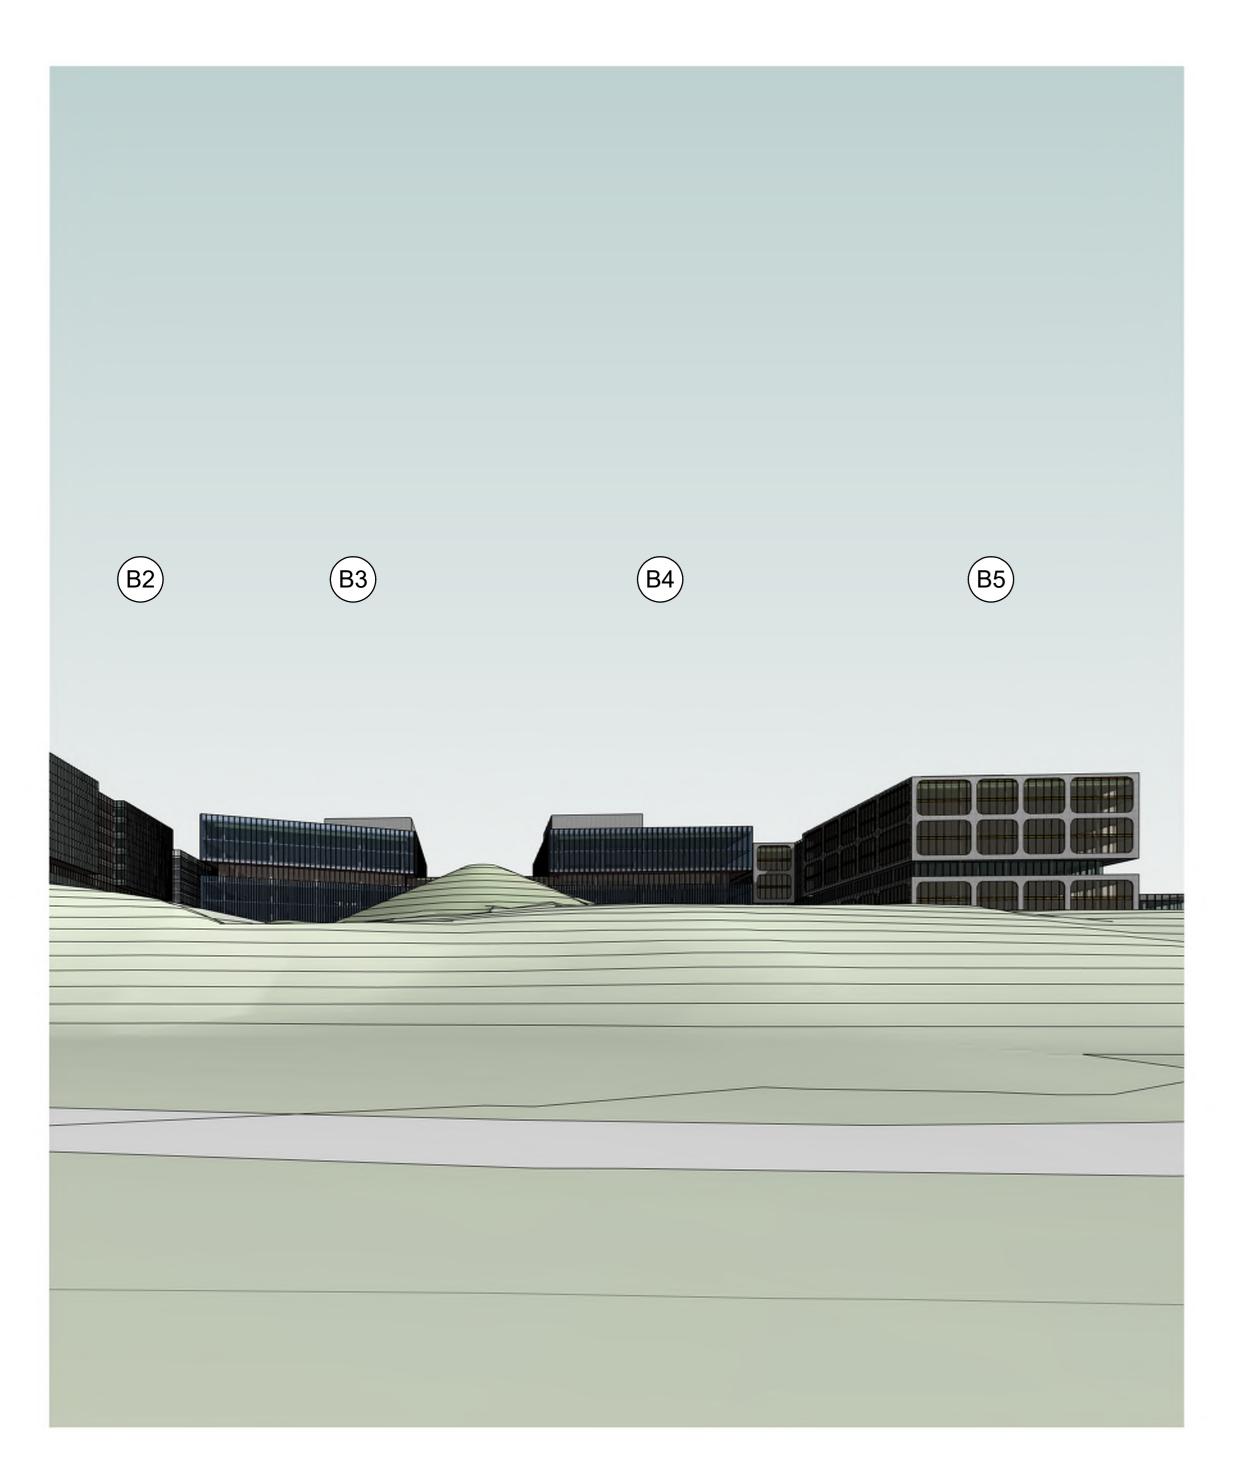
Project 40 RAKELY COURT, TORONTO, ON, M9C 5A5

ISOMETRIC SITE PLAN
DIAGRAMS


A00-07

1:400 ONBL 18-0225

ISOMETIC 3D SITE PLAN LOOKING NE SCALE:






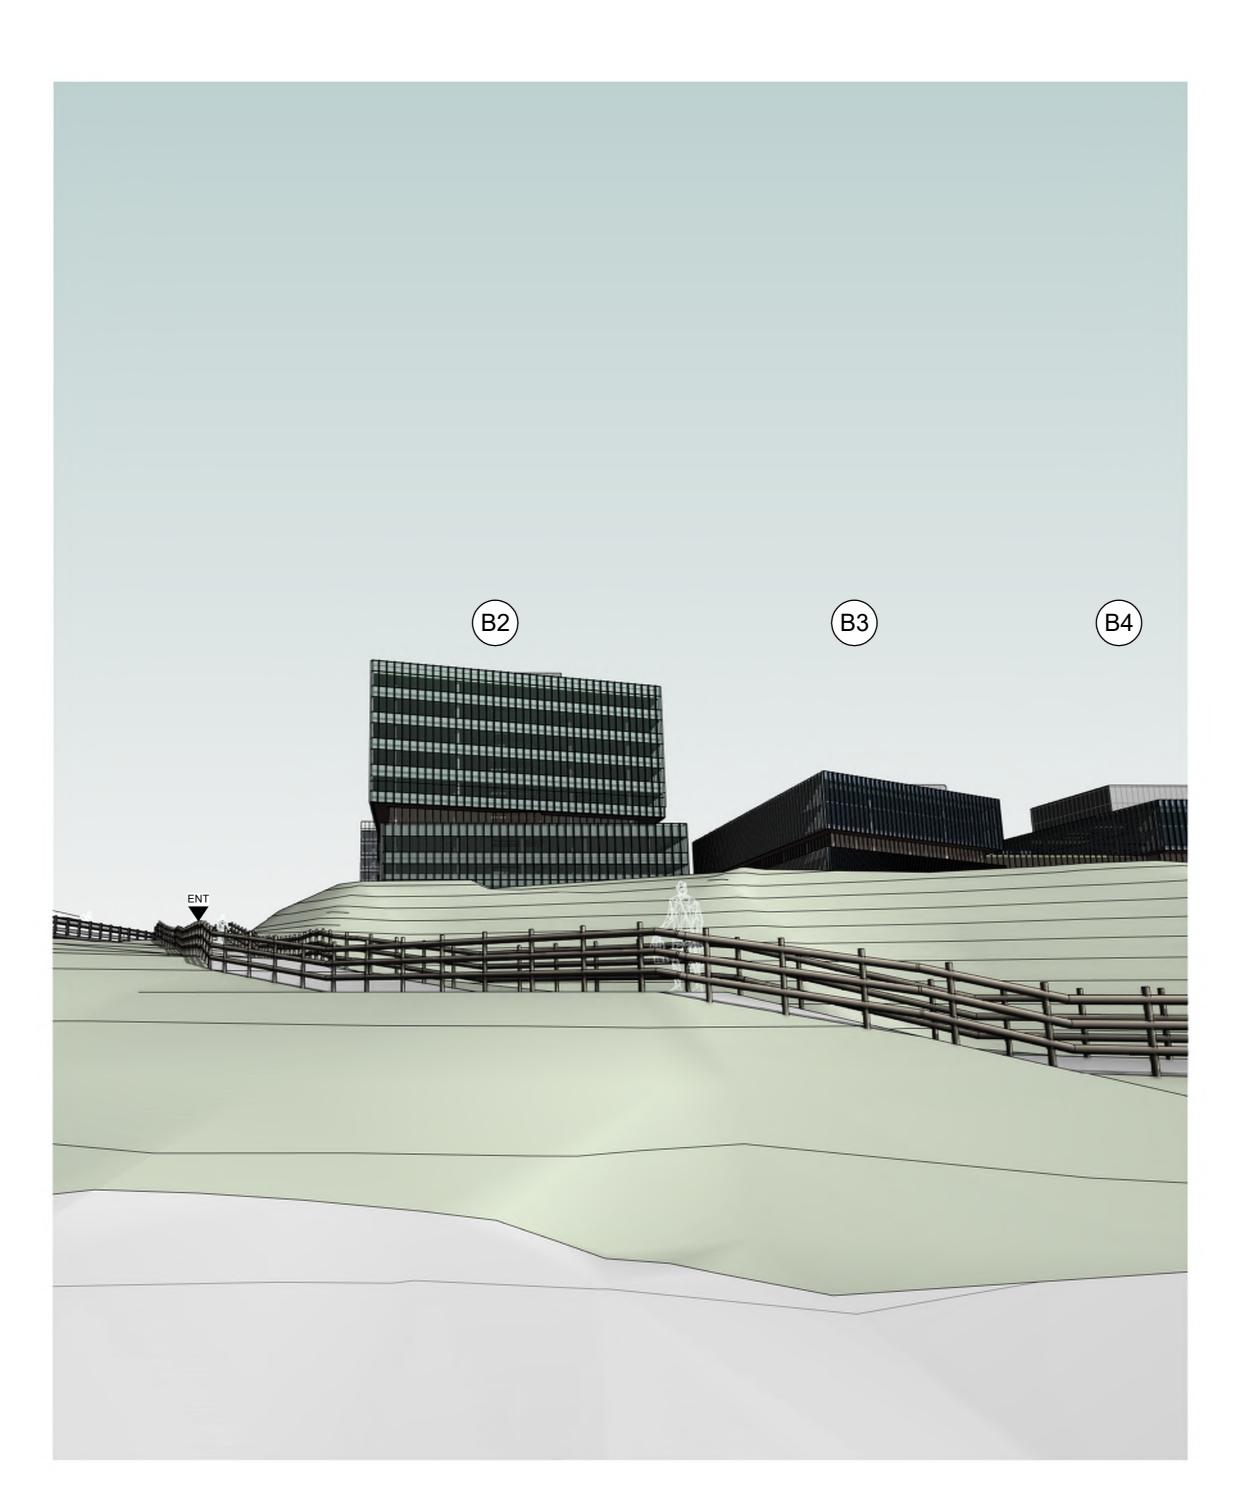

PERSPECTIVE VIEW 2.

A00-08 SCALE:

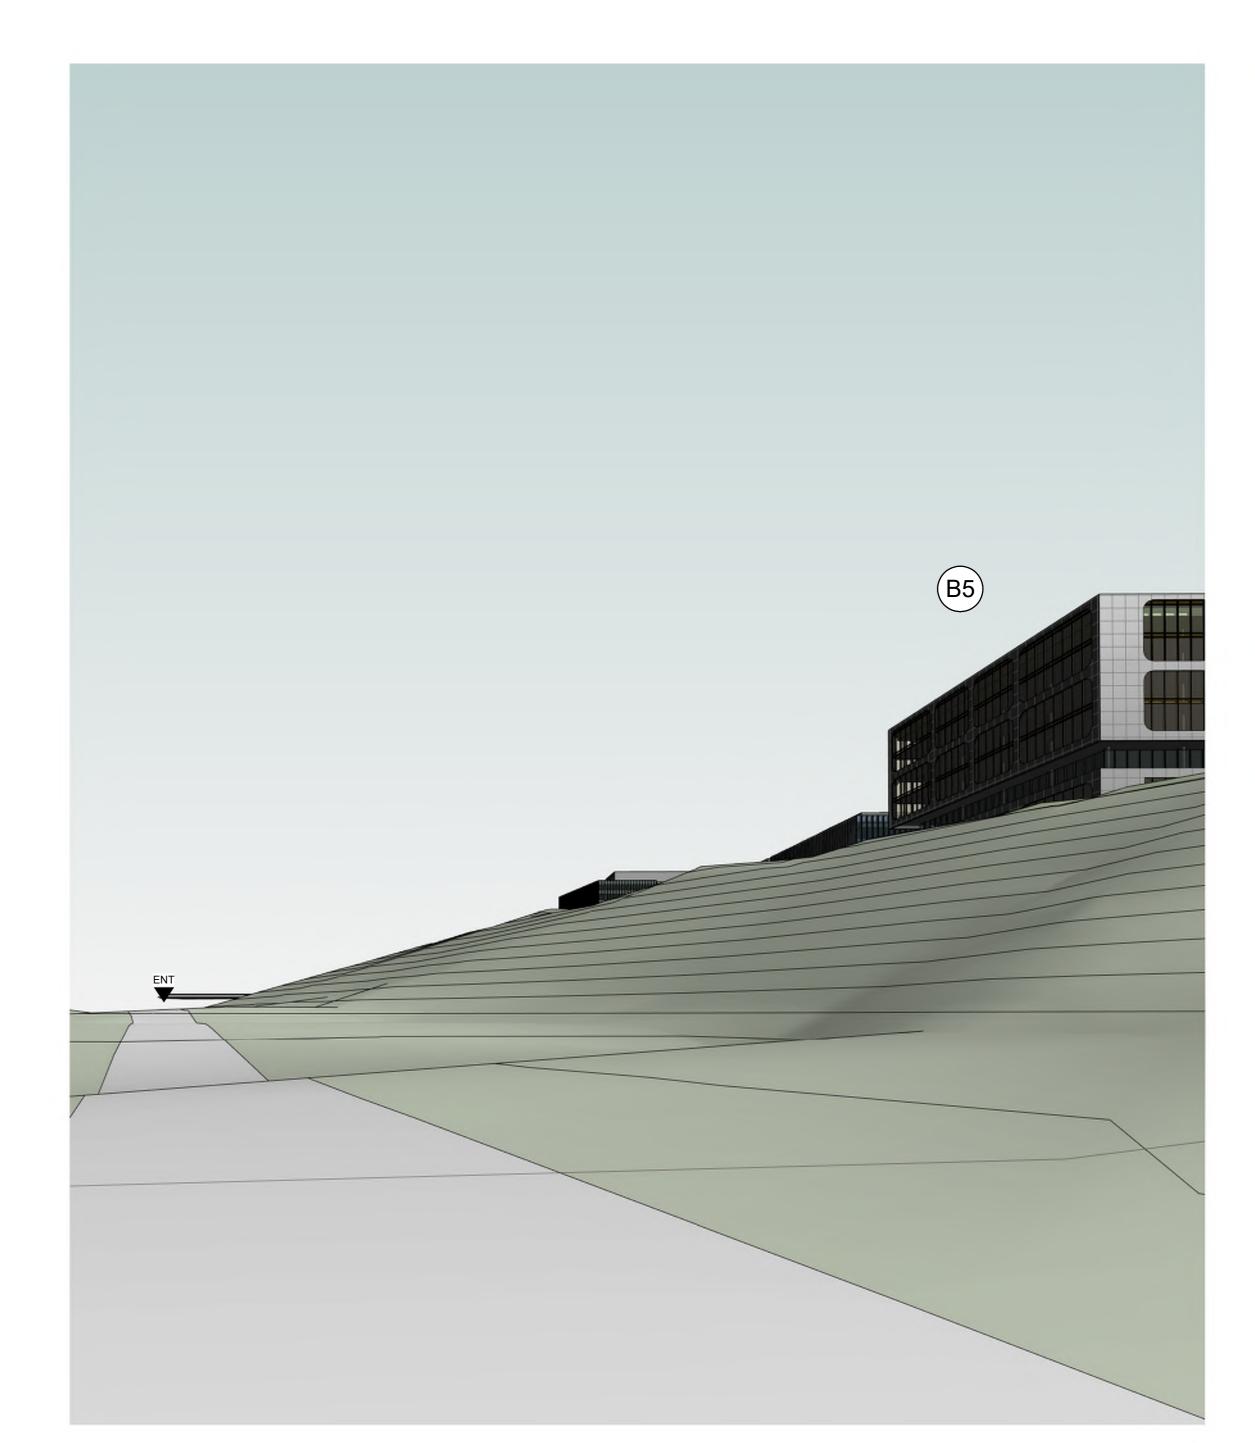

1 PERSPECTIVE VIEW 1. A00-08 SCALE:


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ZONING BY-LAW AMENDMENT

 2021-01-15
 ZONING BY-LAW AMENDMENT

 2022-10-03
 ZONING BY-LAW AMENDMENT



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Structural: NORR ARCHITECTS AND ENGINEERS LIMITED
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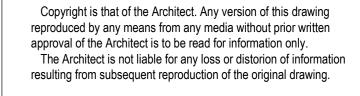
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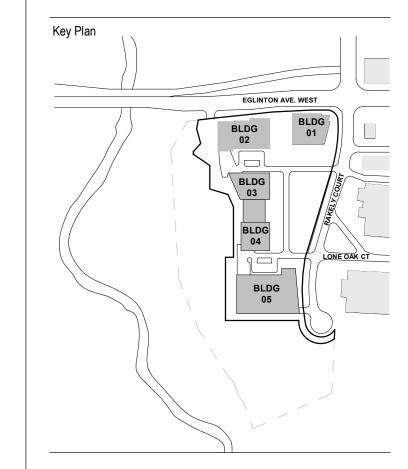
Rakely Eglinton Corporate Centre, Limited Partnership

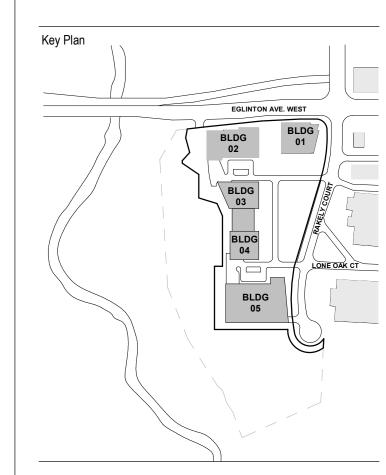Project 40 RAKELY COURT, TORONTO, ON, M9C 5A5

Drawing Title
PERSPECTIVE VIEWS

Project No. ONBL 18-0225 Drawing No. A00-08





Consultants

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Project 40 RAKELY COURT, TORONTO, ON, M9C 5A5

Drawing Title
PERSPECTIVE VIEWS

ONBL 18-0225 A00-09





6. PERSPECTIVE SHOT 6.
A00-09 SCALE: 1:2













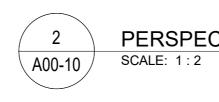



PERSPECTIVE SHOT 2



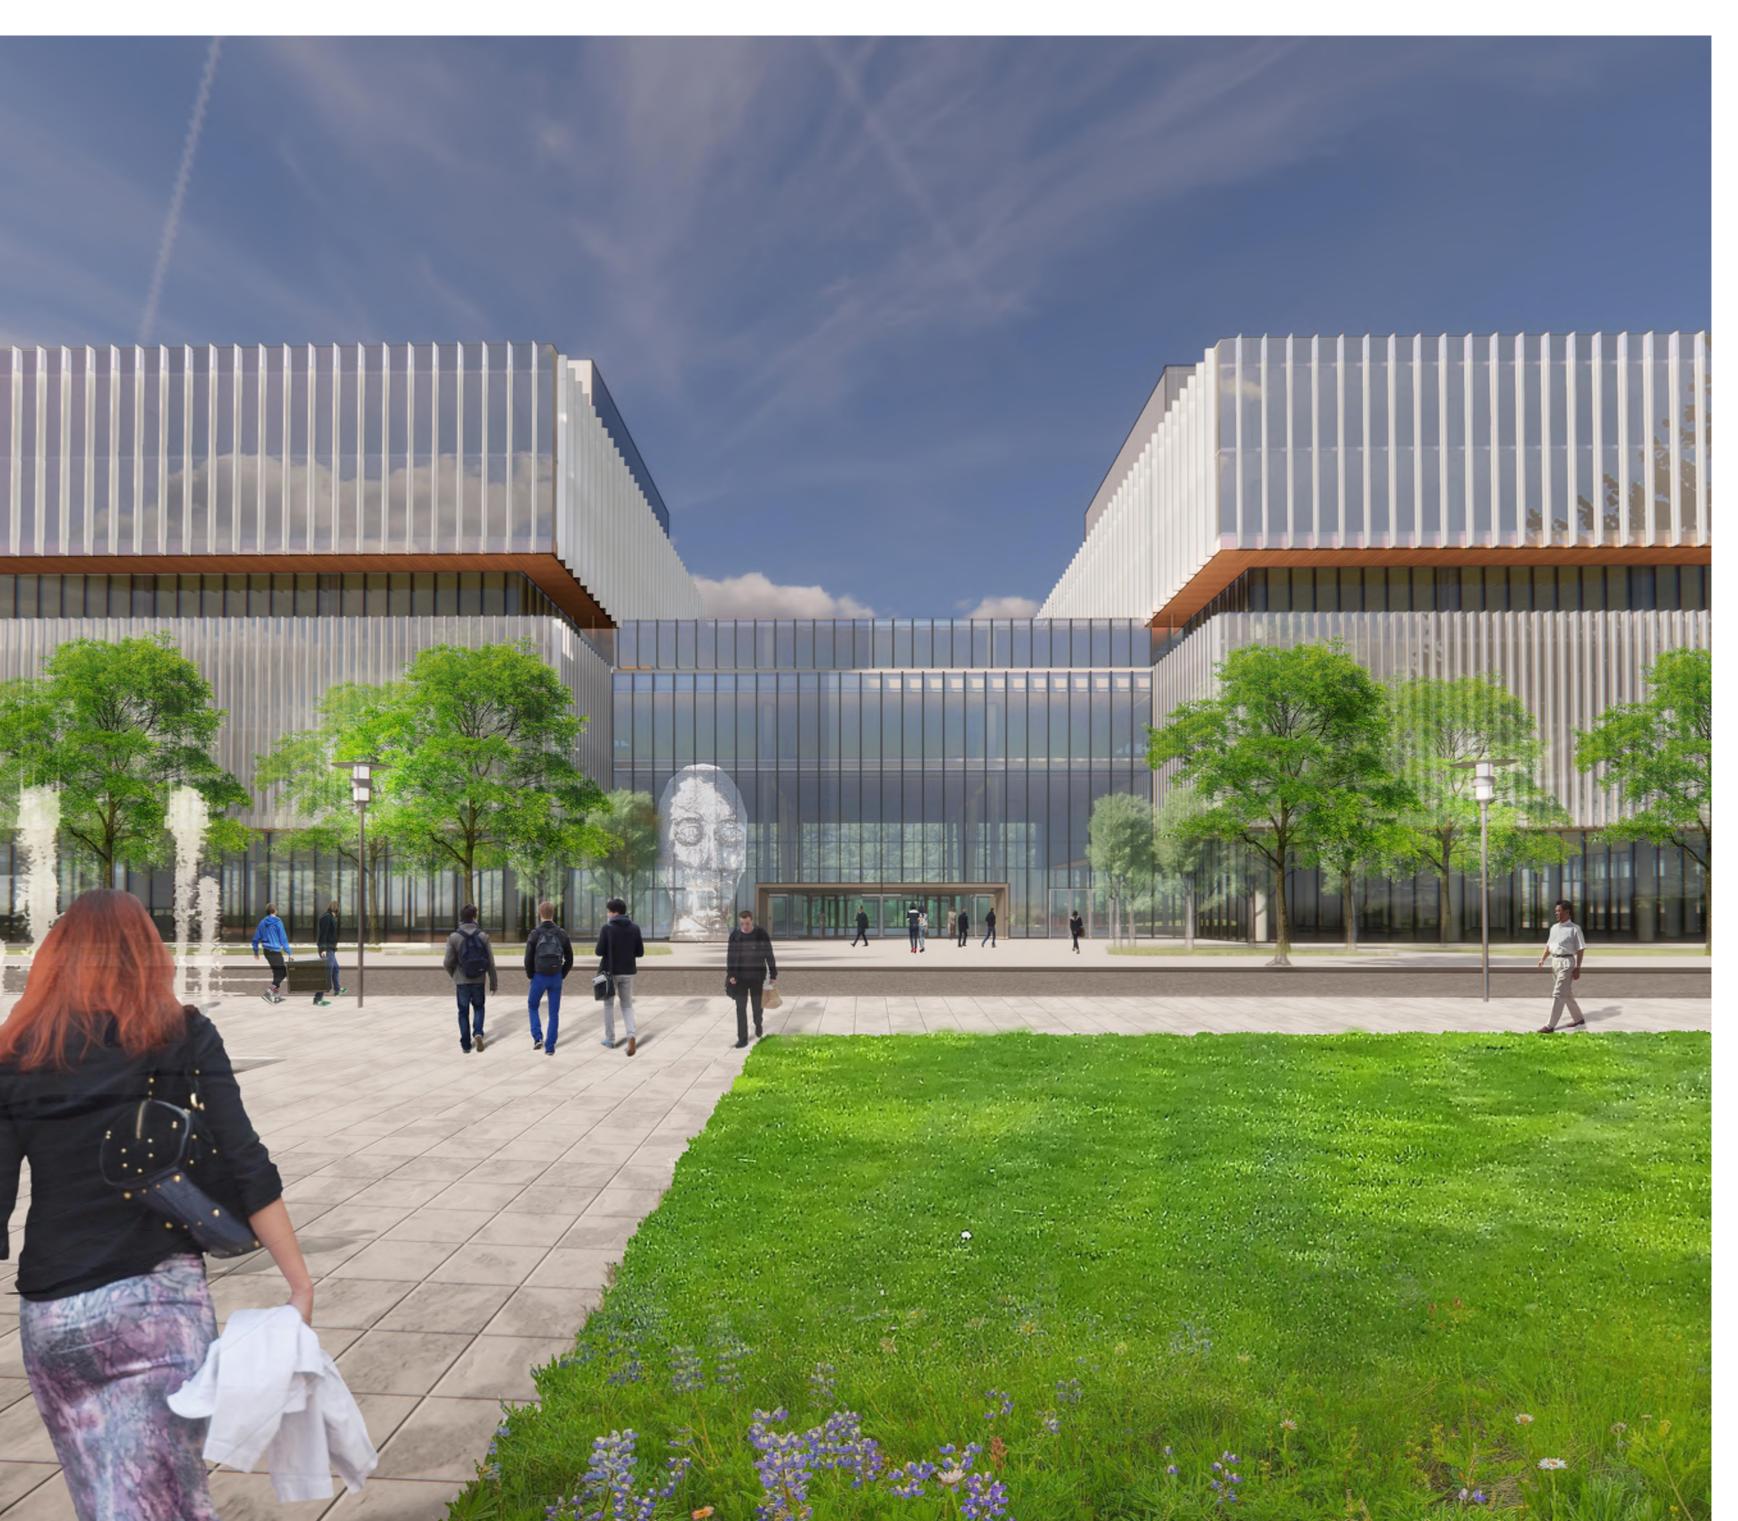



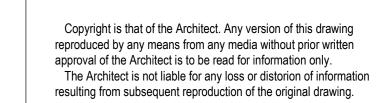

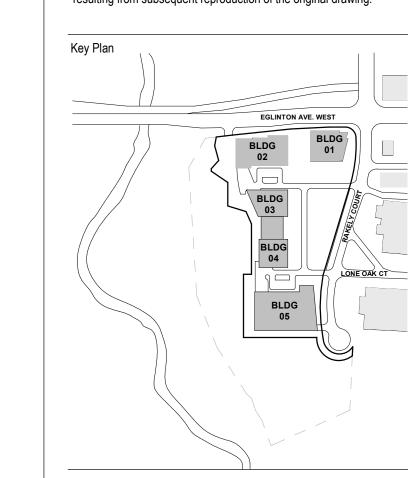

R.J. BURNSIDE & ASSOCIATES LIMITED Landscape: JANET ROSENBERG & STUDIO INC.

Architecture: NORR ARCHITECTS AND ENGINEERS LIMITED
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Mechanical: NORR ARCHITECTS AND ENGINEERS LIMITED
Electrical: NORR ARCHITECTS AND ENGINEERS LIMITED
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Drawing Title
PERSPECTIVE VIEWS

ONBL 18-0225 A00-10



A00-10 SCALE: 1:2










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Project 40 RAKELY COURT, TORONTO, ON, M9C 5A5

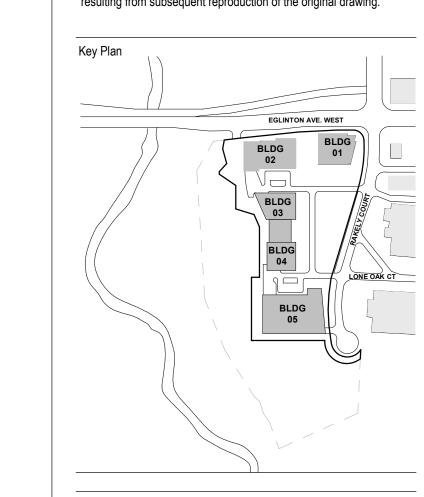Drawing Title
AERIAL PERSPECTIVE VIEW

ONBL 18-0225 Drawing No.

A00-11

TORONTO

— PROPOSED PROPERTY LINE

**EXISTING PROPERTY LINE** 

ETOBICOKE PUBLIC TRAIL


LAKE ONTARIO

- ETOBICOKE CREEK

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Drawing Title
CONTEXT PLAN


As indicated ONBL 18-0225


SITE IS LOCATED IN ETOBICOKE CENTRE (WARD 2) A10-01

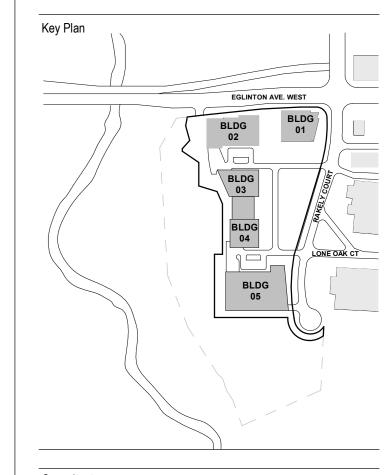SITE CONTEXT LOOKING NORTH
SCALE: 1:1



SITE CONTEXT LOOKING SOUTH SCALE: 1:1

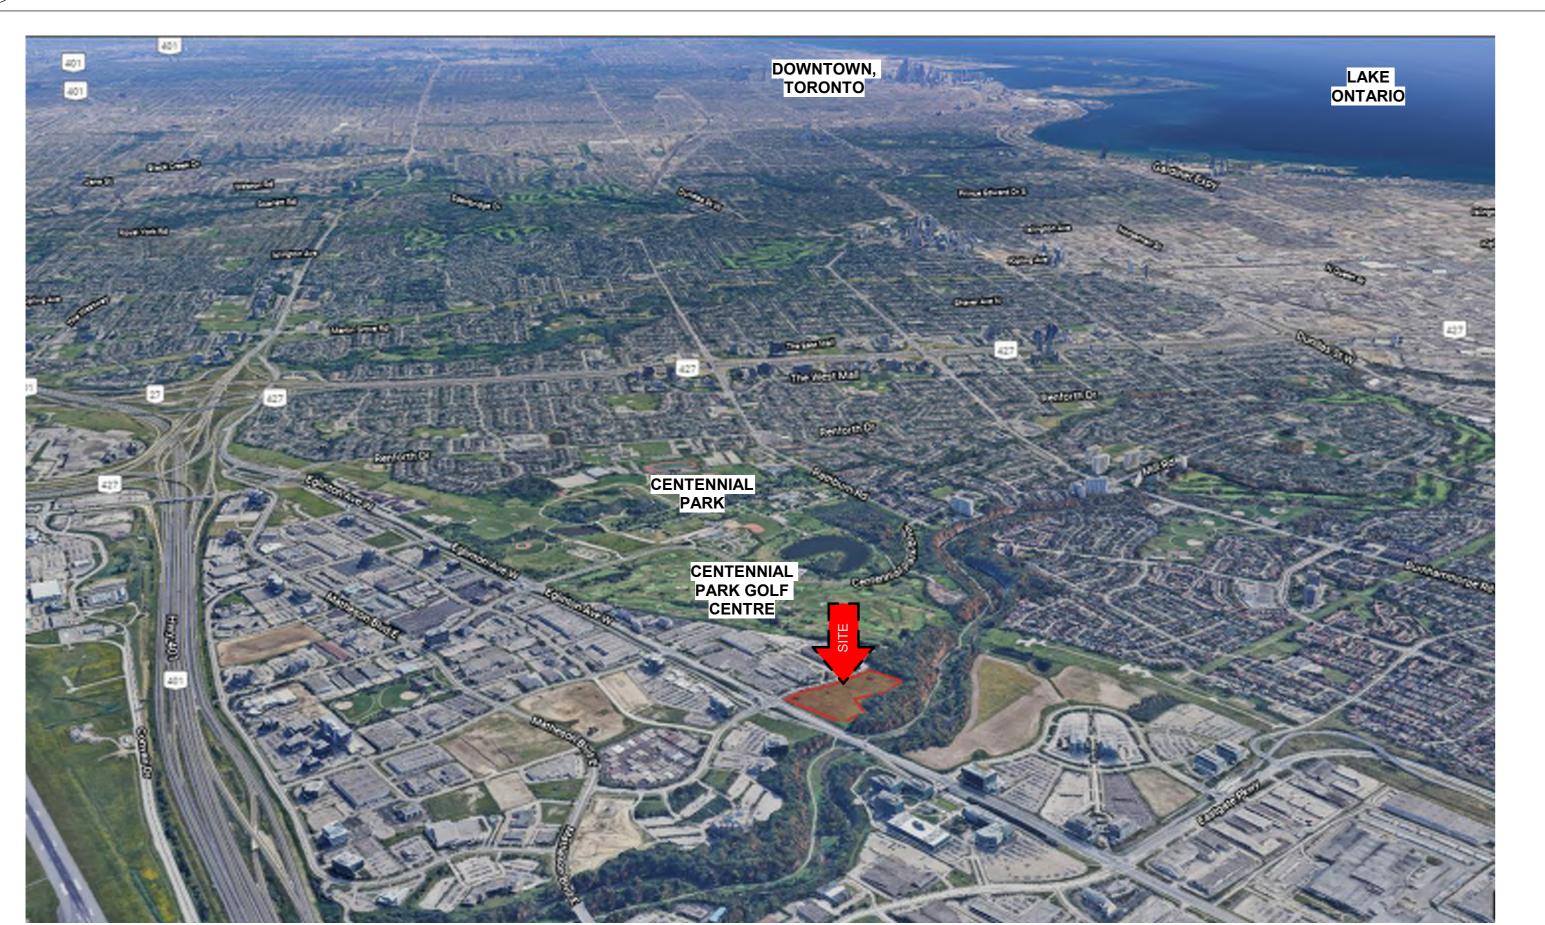


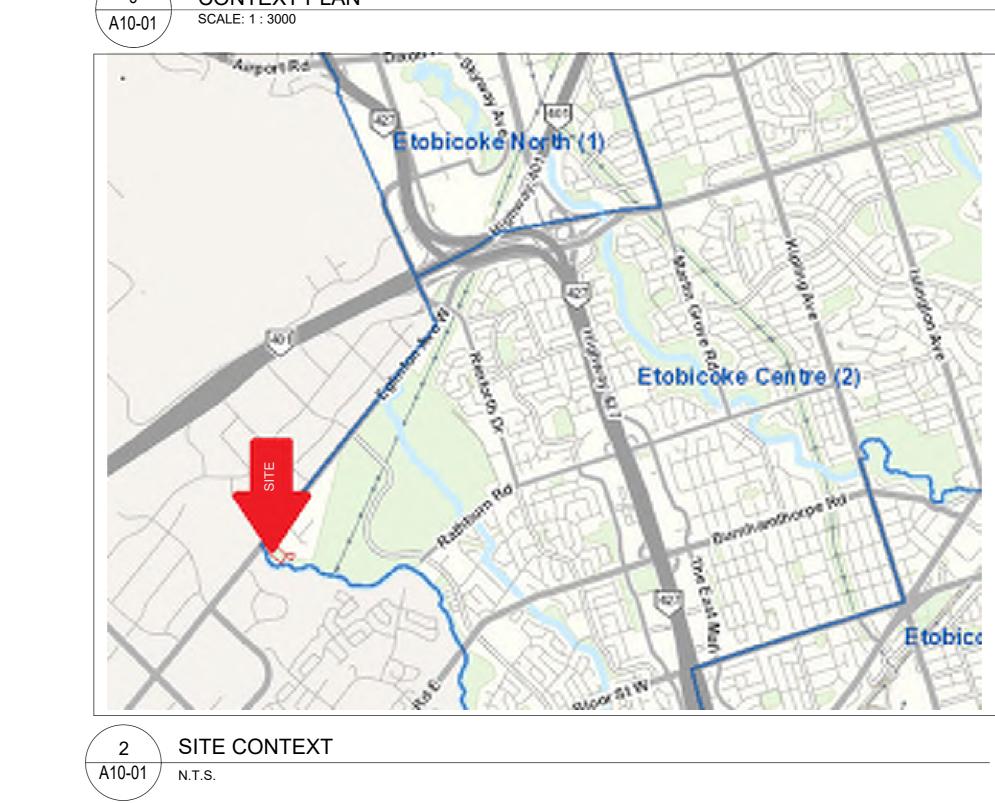









4 SITE CONTEXT LOOKING EAST
A10-01 SCALE: 1:1

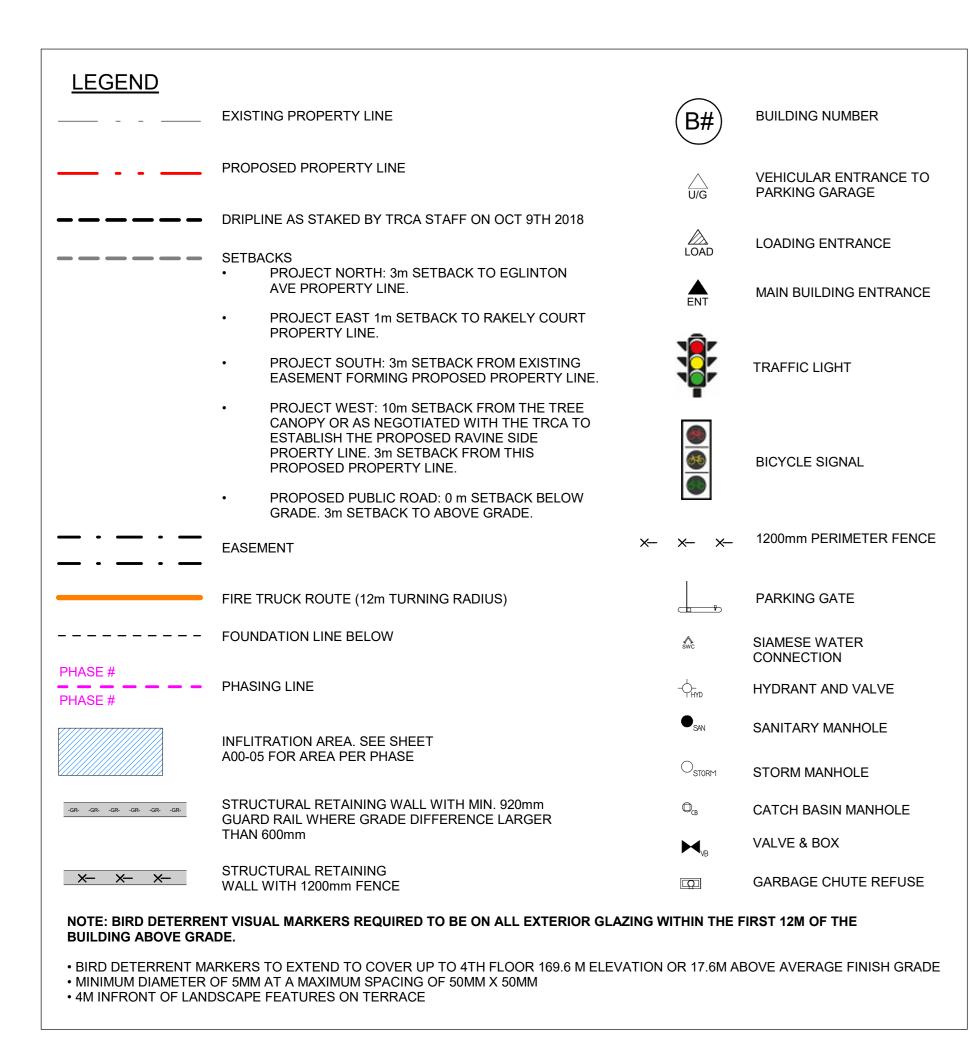


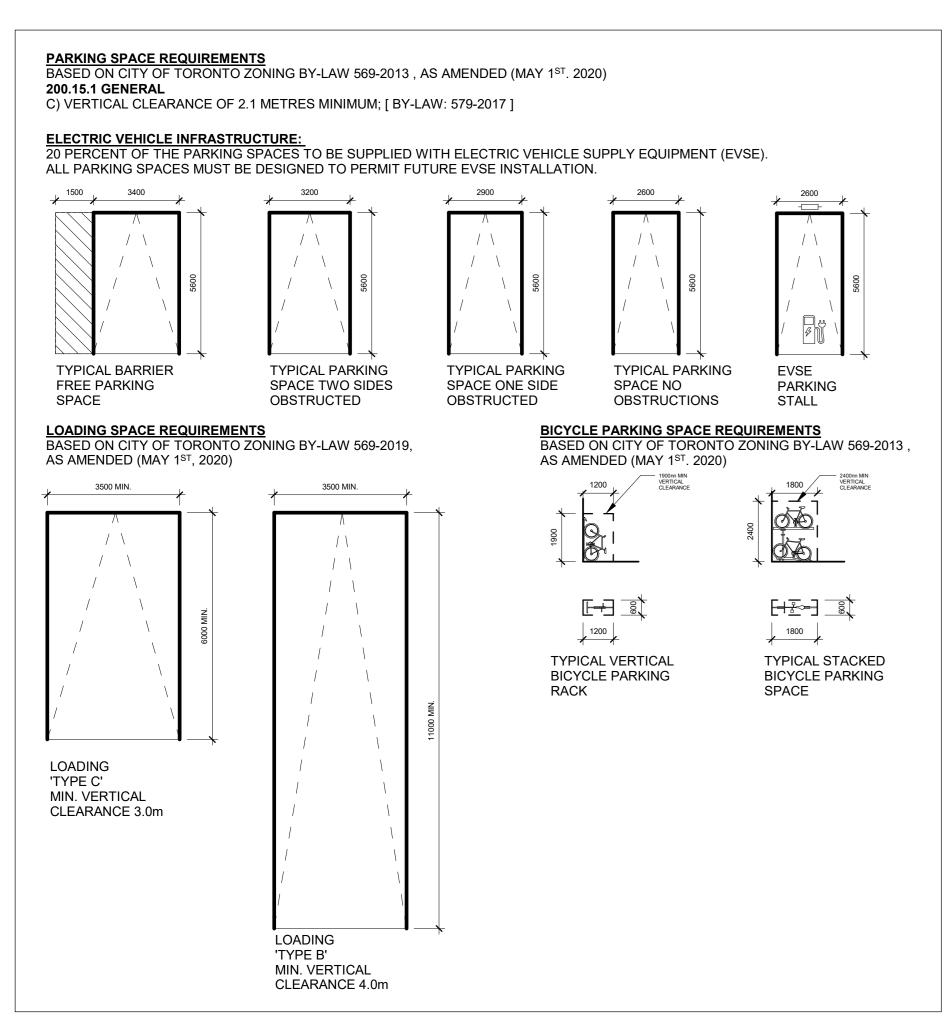

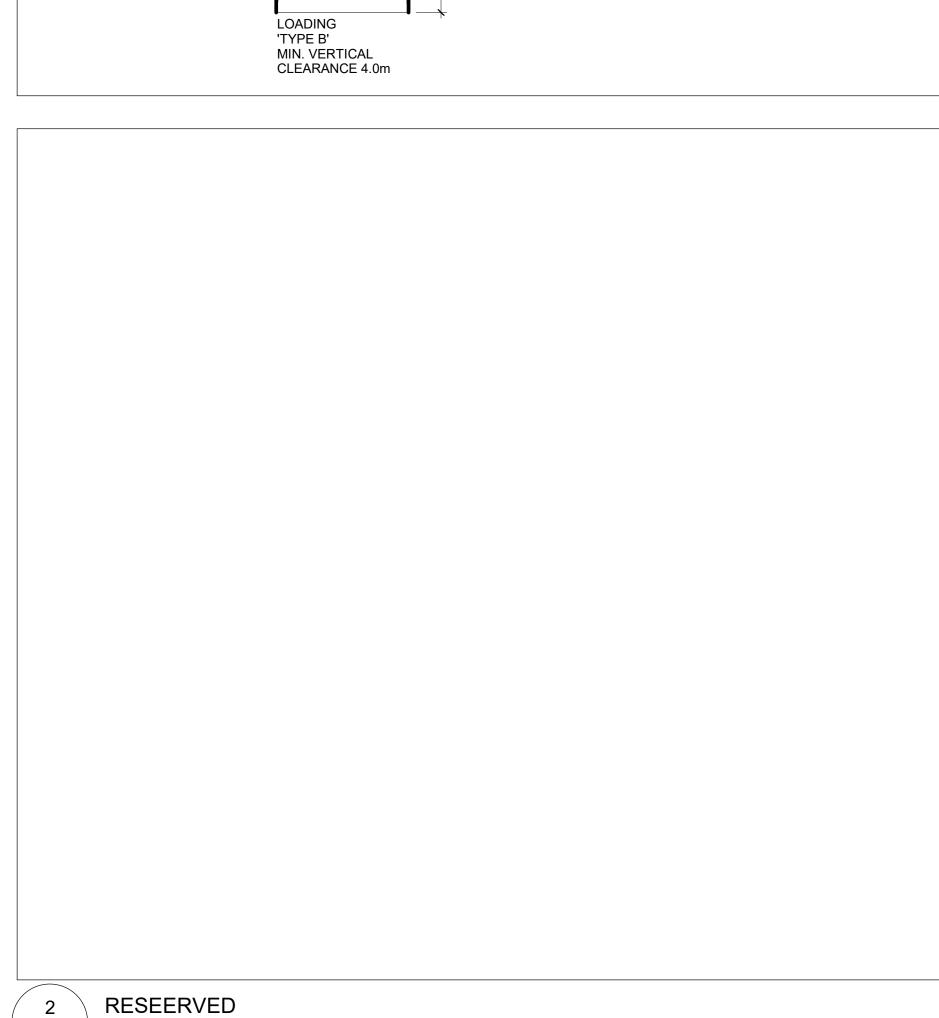


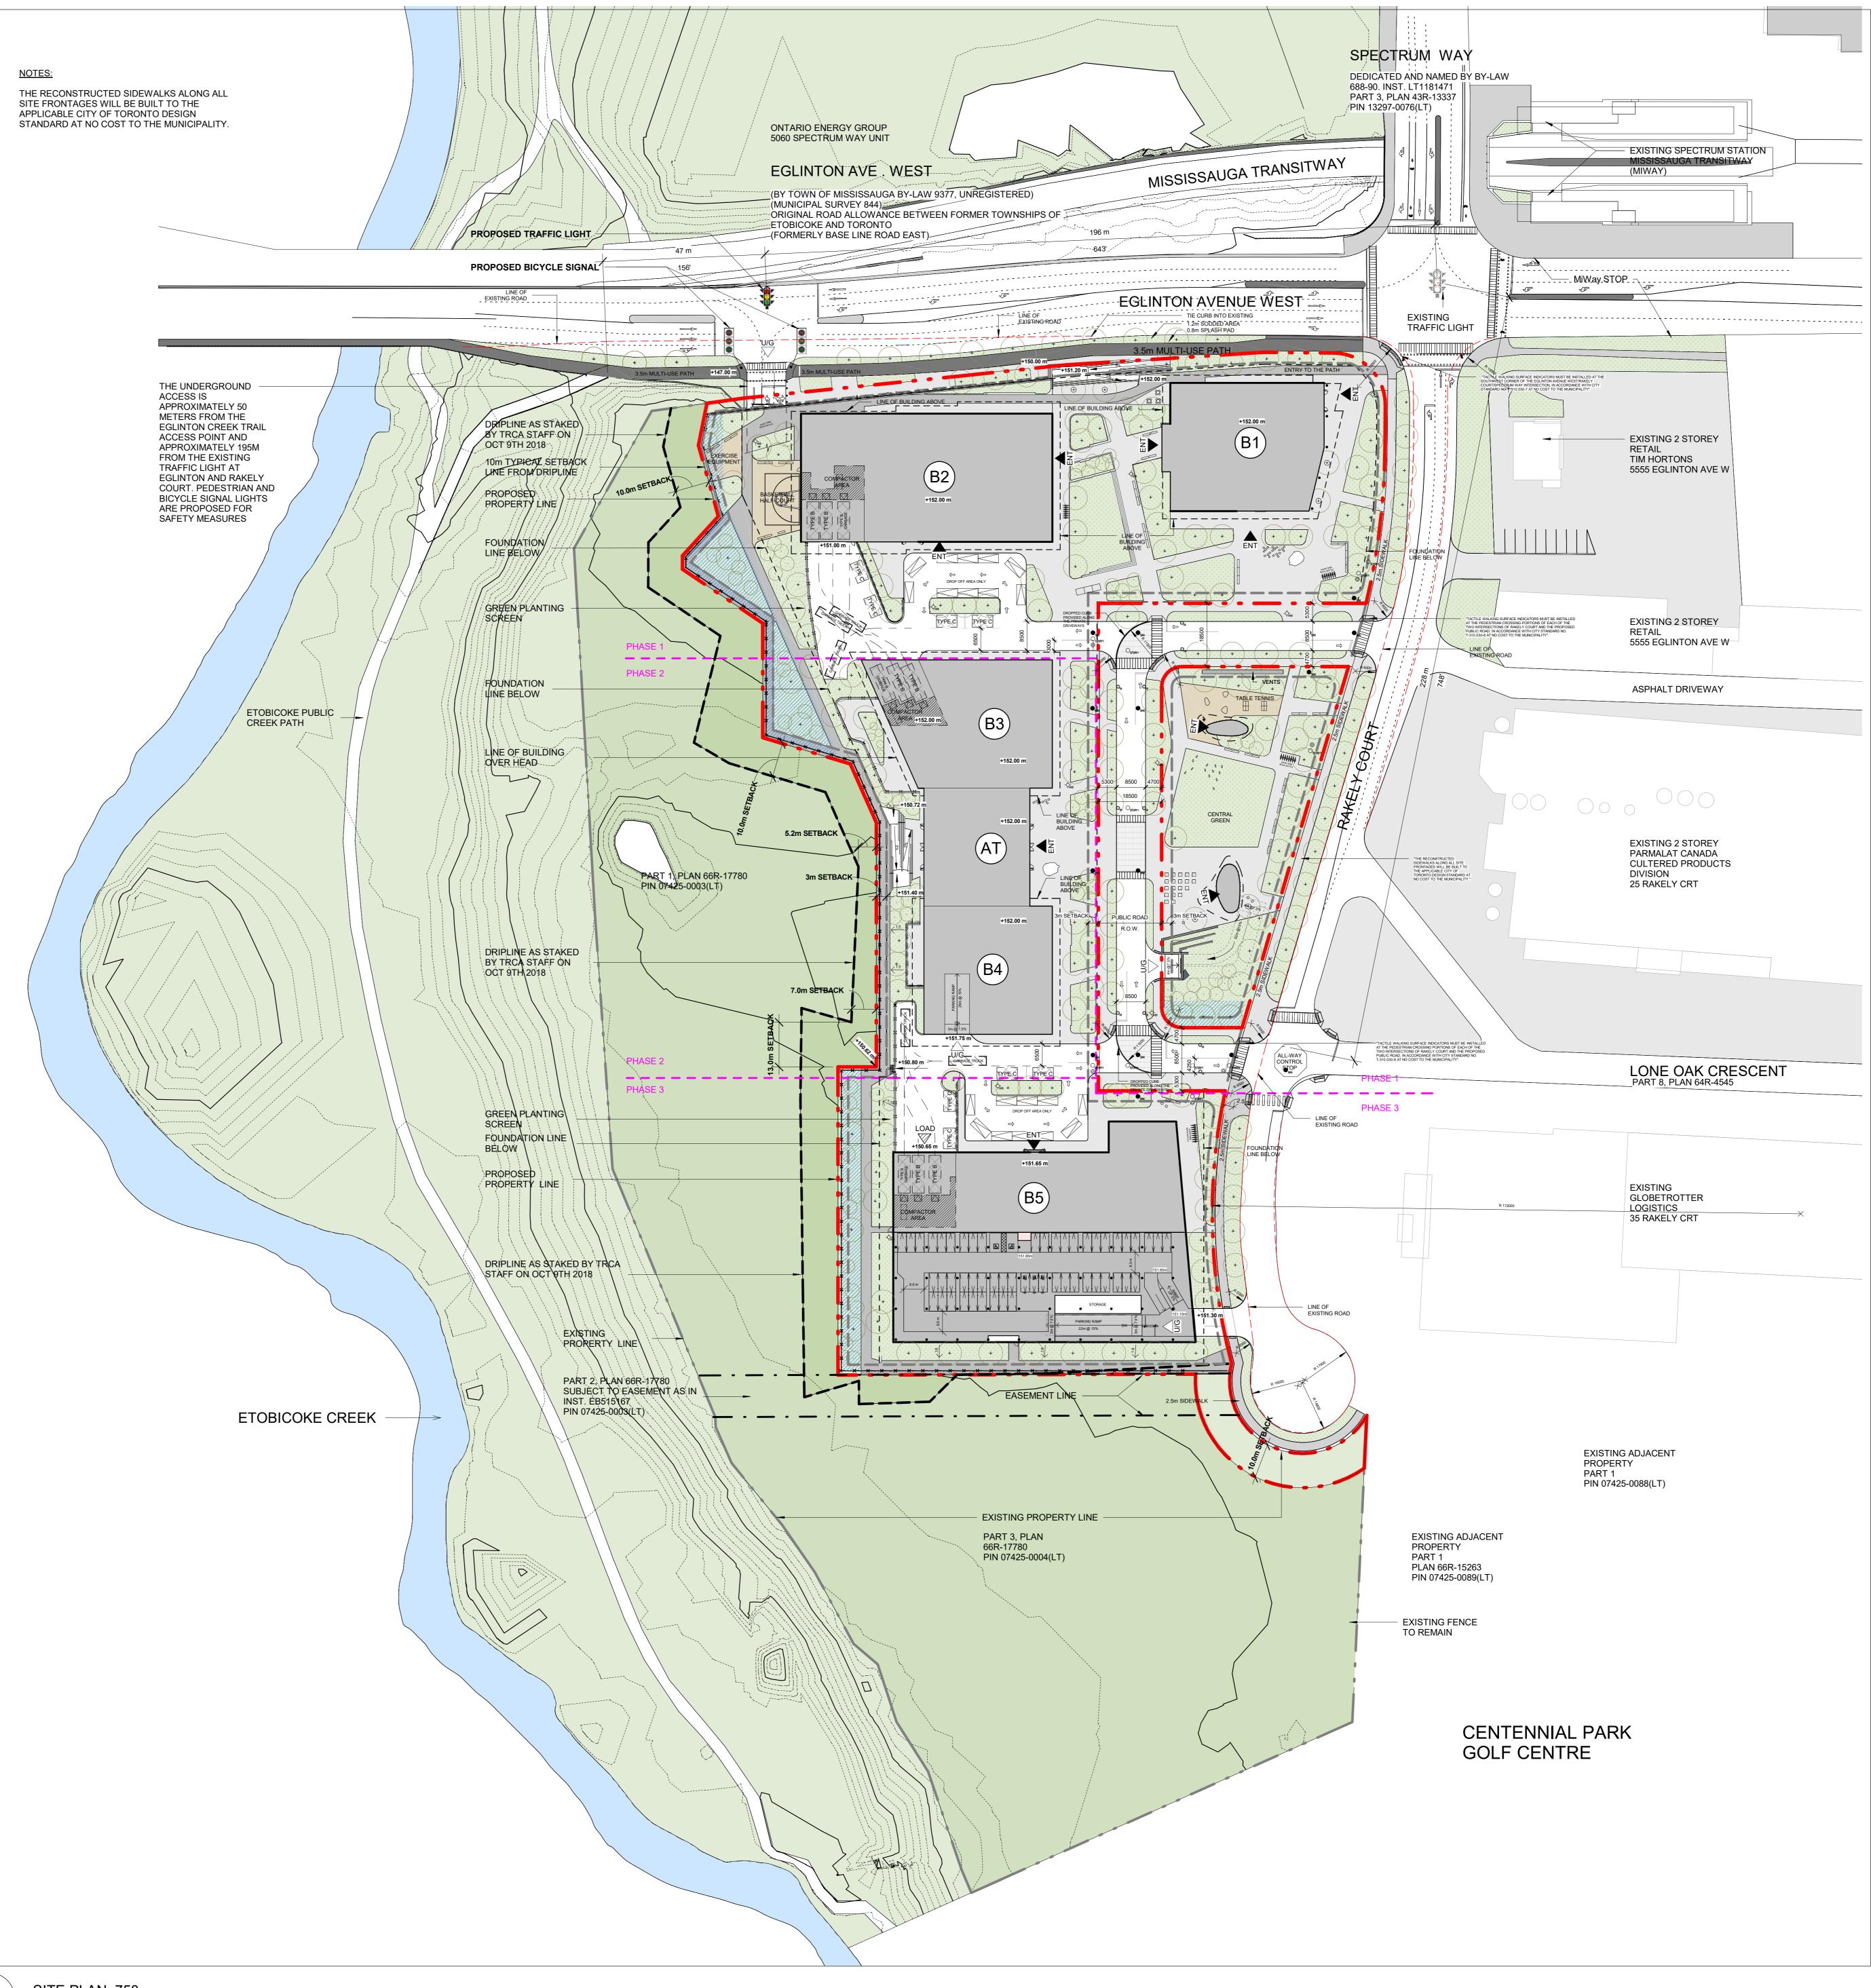

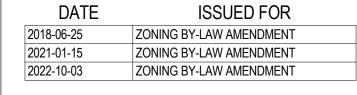

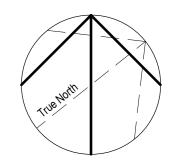

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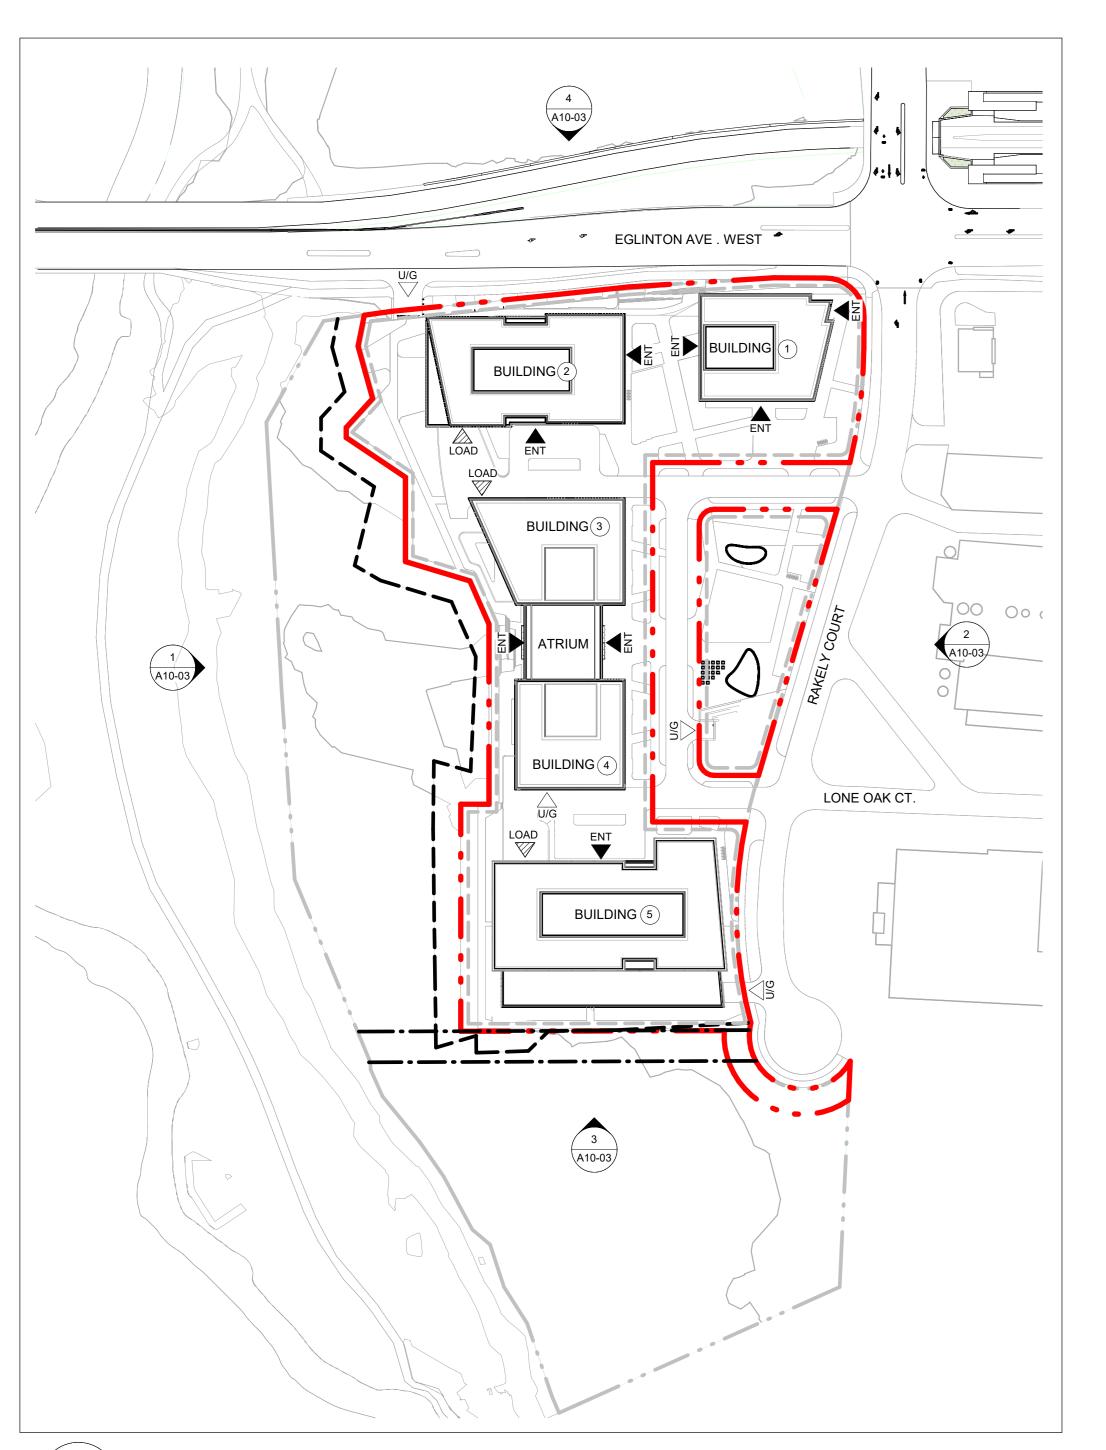
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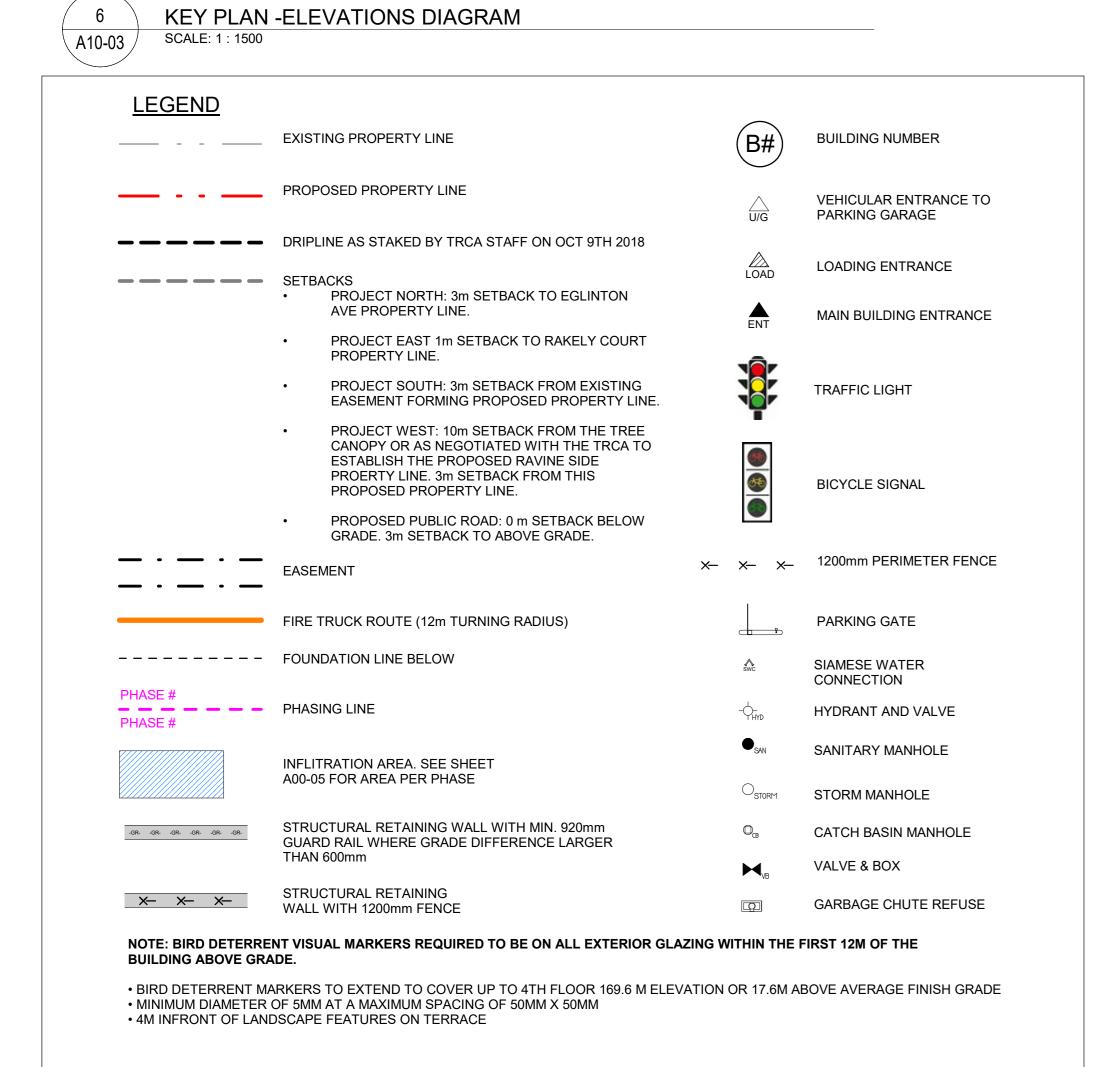
40 RAKELY COURT, TORONTO, ON, M9C 5A5

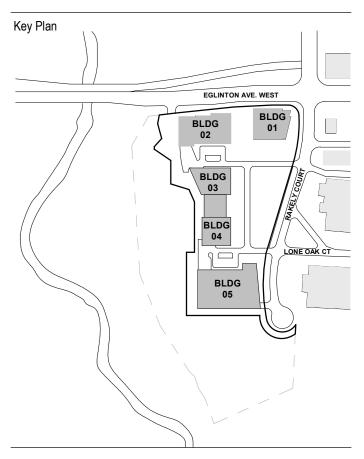Drawing Title
SITE PLAN


As indicated


Project No. ONBL 18-0225 Drawing No. A10-02








SOUTH ELEVATION SCALE: 1:750

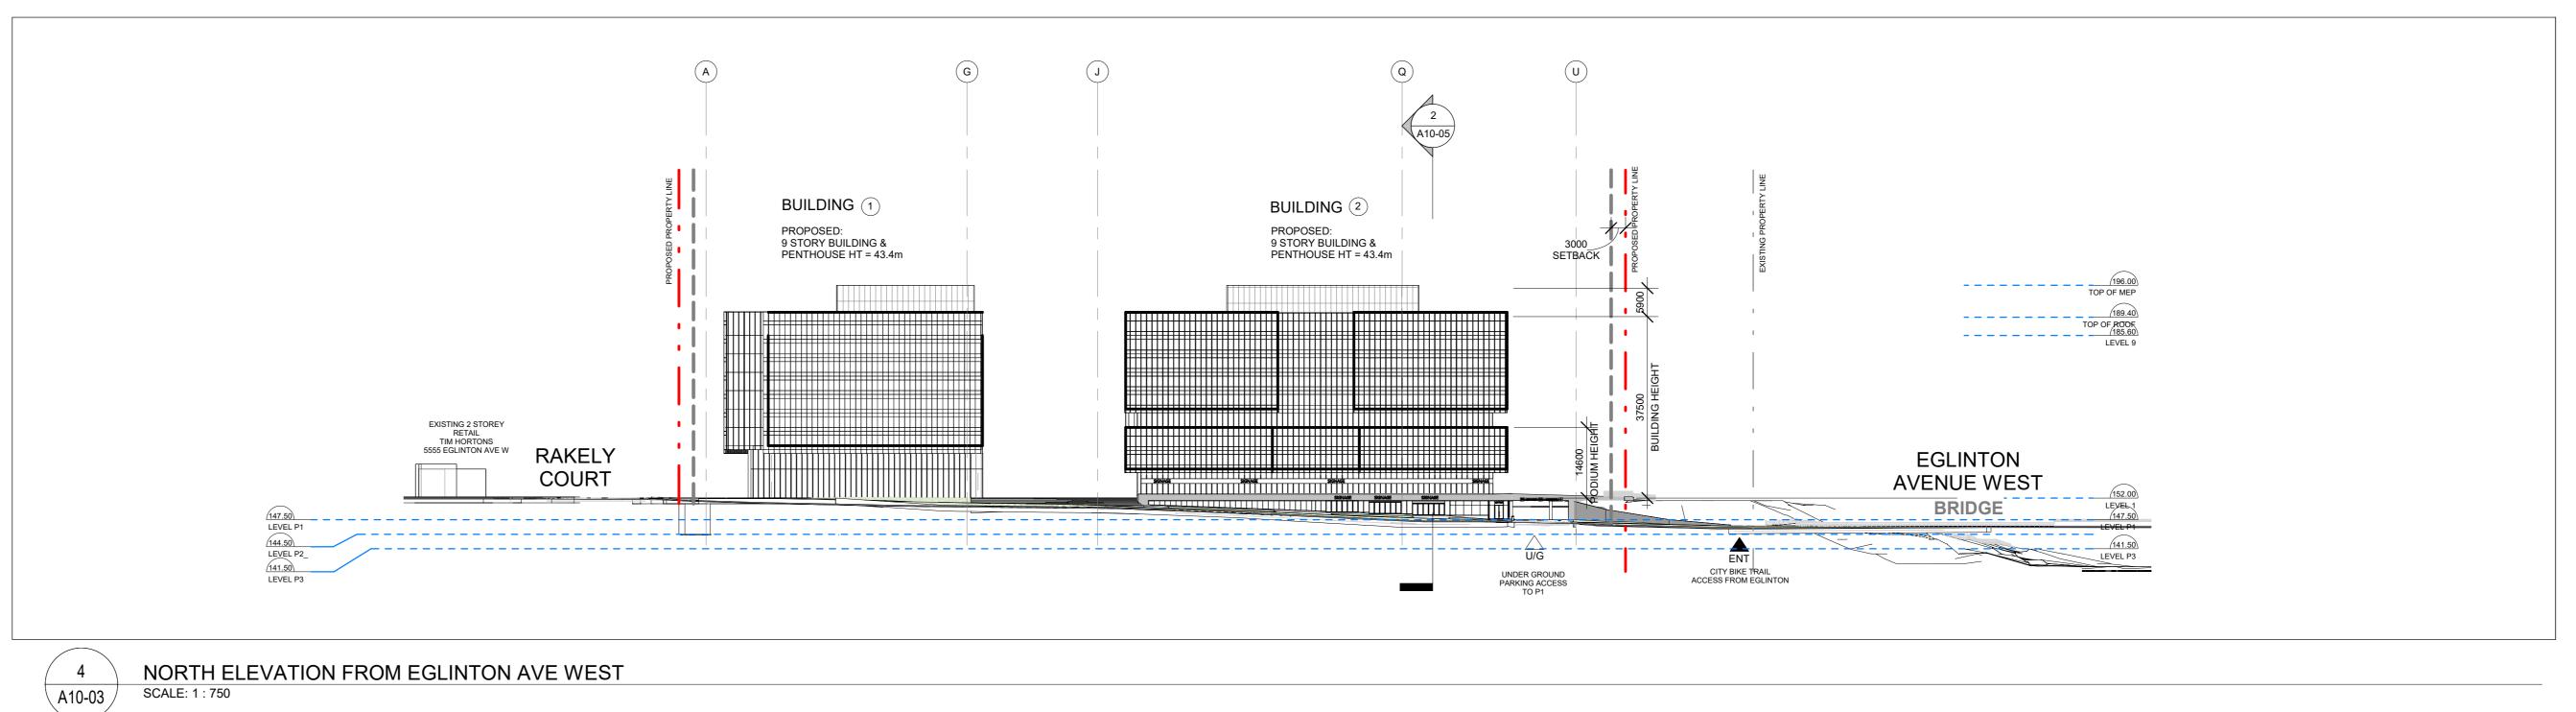

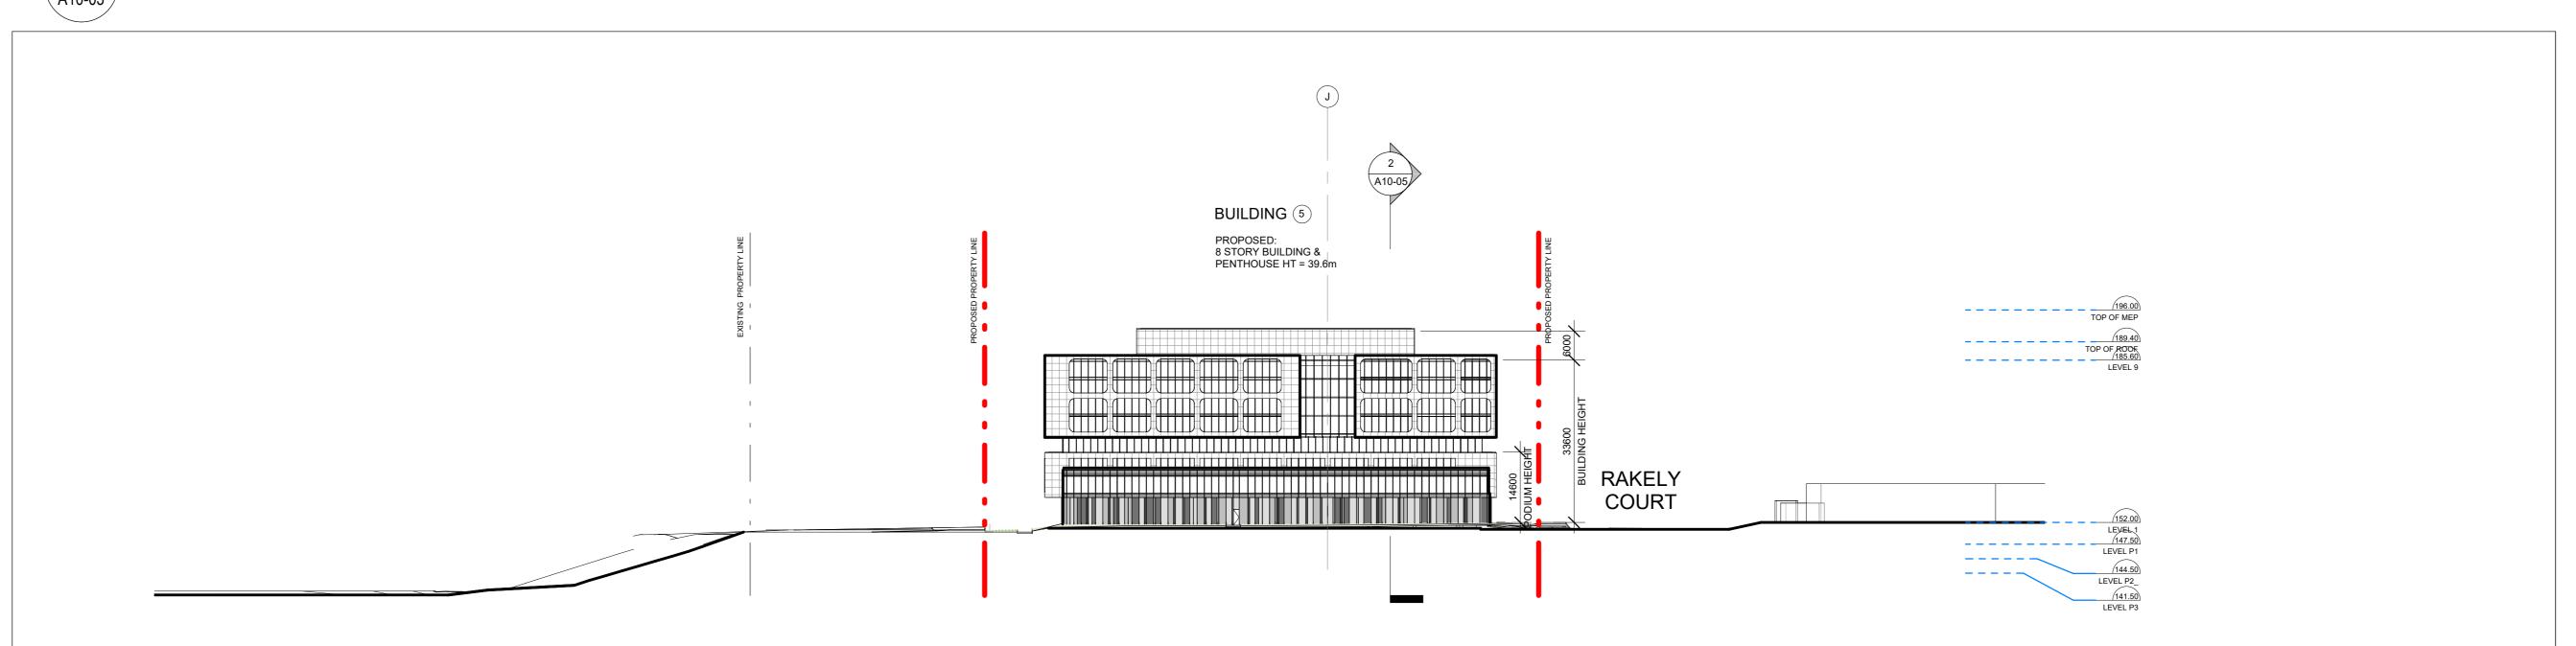

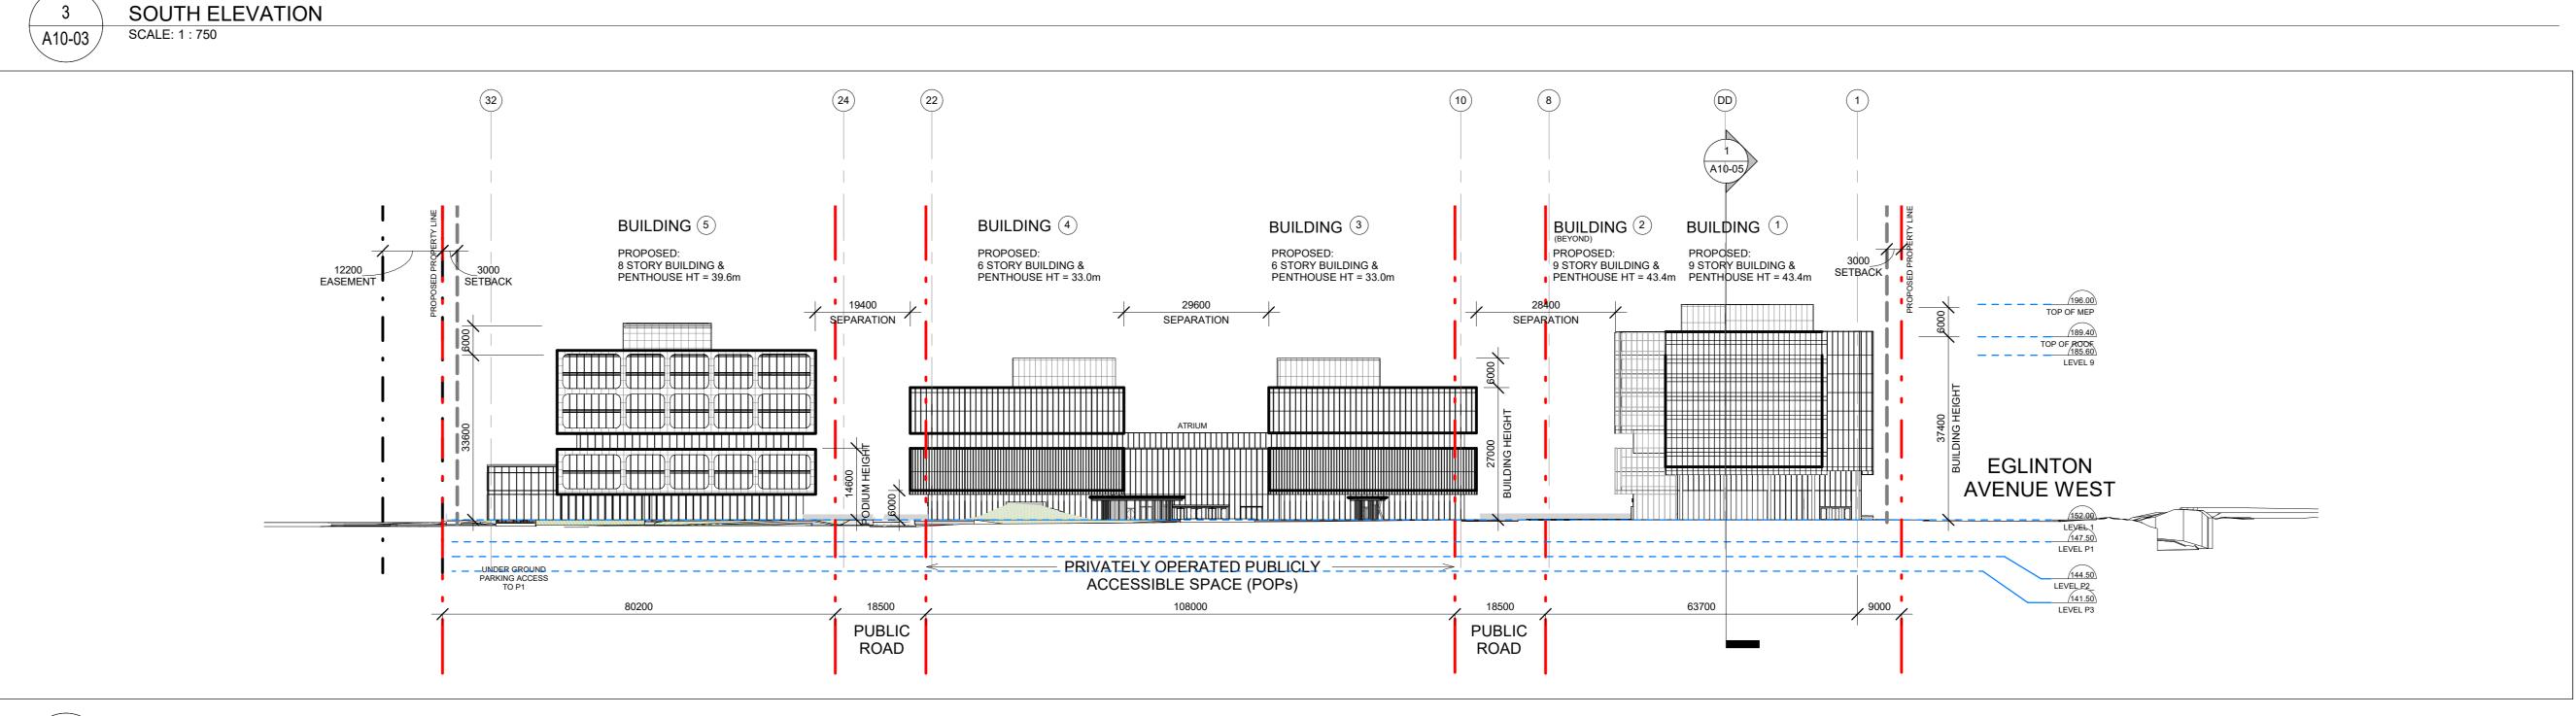


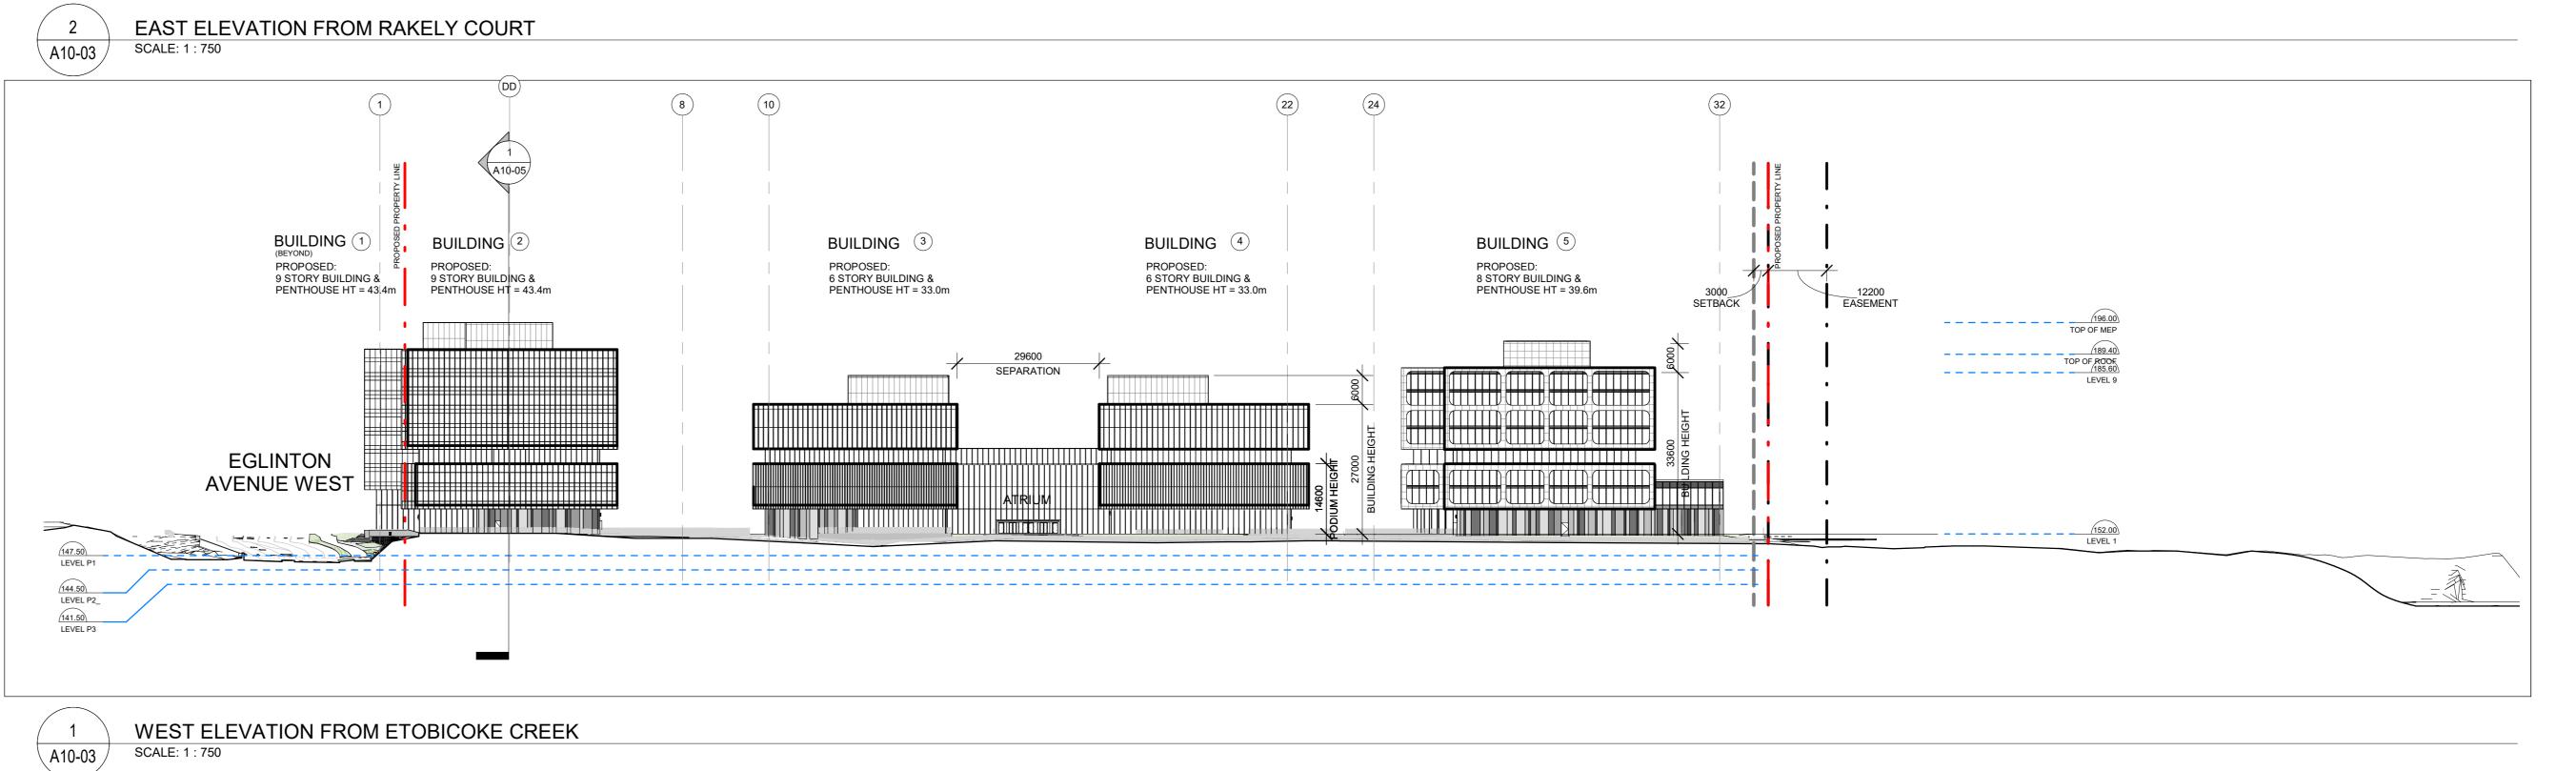

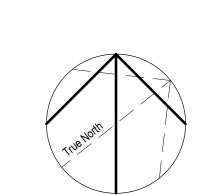

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ZONING BY-LAW AMENDMENT ZONING BY-LAW AMENDMENT

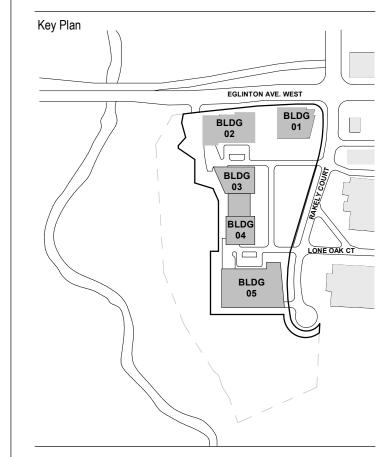

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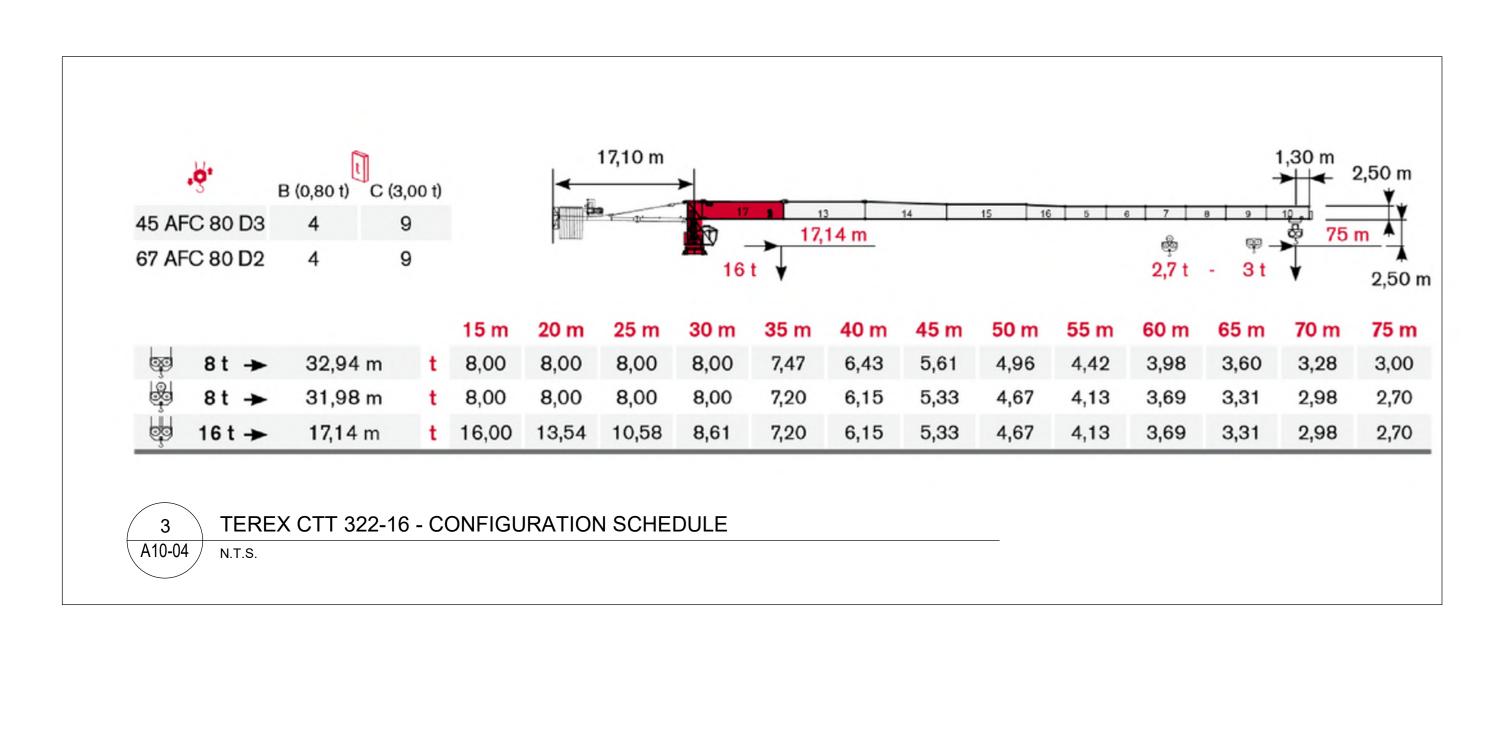
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SITE ELEVATIONS

As indicated Project No. ONBL 18-0225 Drawing No.



(PHASE 1) BUILDINGS (B1+ B2)

REQUEST:

REQUEST OF TEMPORARY PERMIT

CURRENT GTAA HEIGHT RESTRICTION F

EGLINTON AVENUE WEST

TEMPORARY PERMIT / ALLOWANCE

TO EXCEED EXISTING GTAA 200.52

TEMPORARY PERMIT OF ADDITIONAL

3.48M = TOTAL HEIGHT OF 204.00

FOR DURATION OF CONSTRUCTION

HEIGHT RESTRICTION

TO EXCEED EXISTING GTAA 199.52 HEIGHT RESTRICTION

TEMPORARY PERMIT OF ADDITIONAL 4.48M = TOTAL HEIGHT OF 204.00 FOR DURATION OF CONSTRUCTION

**GTAA LEGEND** 

---- REQUEST FOR TEMPORARY

---- GTAA HEIGHT LIMIT

---- BOTTOM OF CRANE

- PROPERTY LINE


— · — EASEMENT

SCALE: 1:500


HEIGHT LIMIT PERMIT

**BUILDING NUMBER** 

NORTH-SOUTH SECTION HEIGHT GTAA

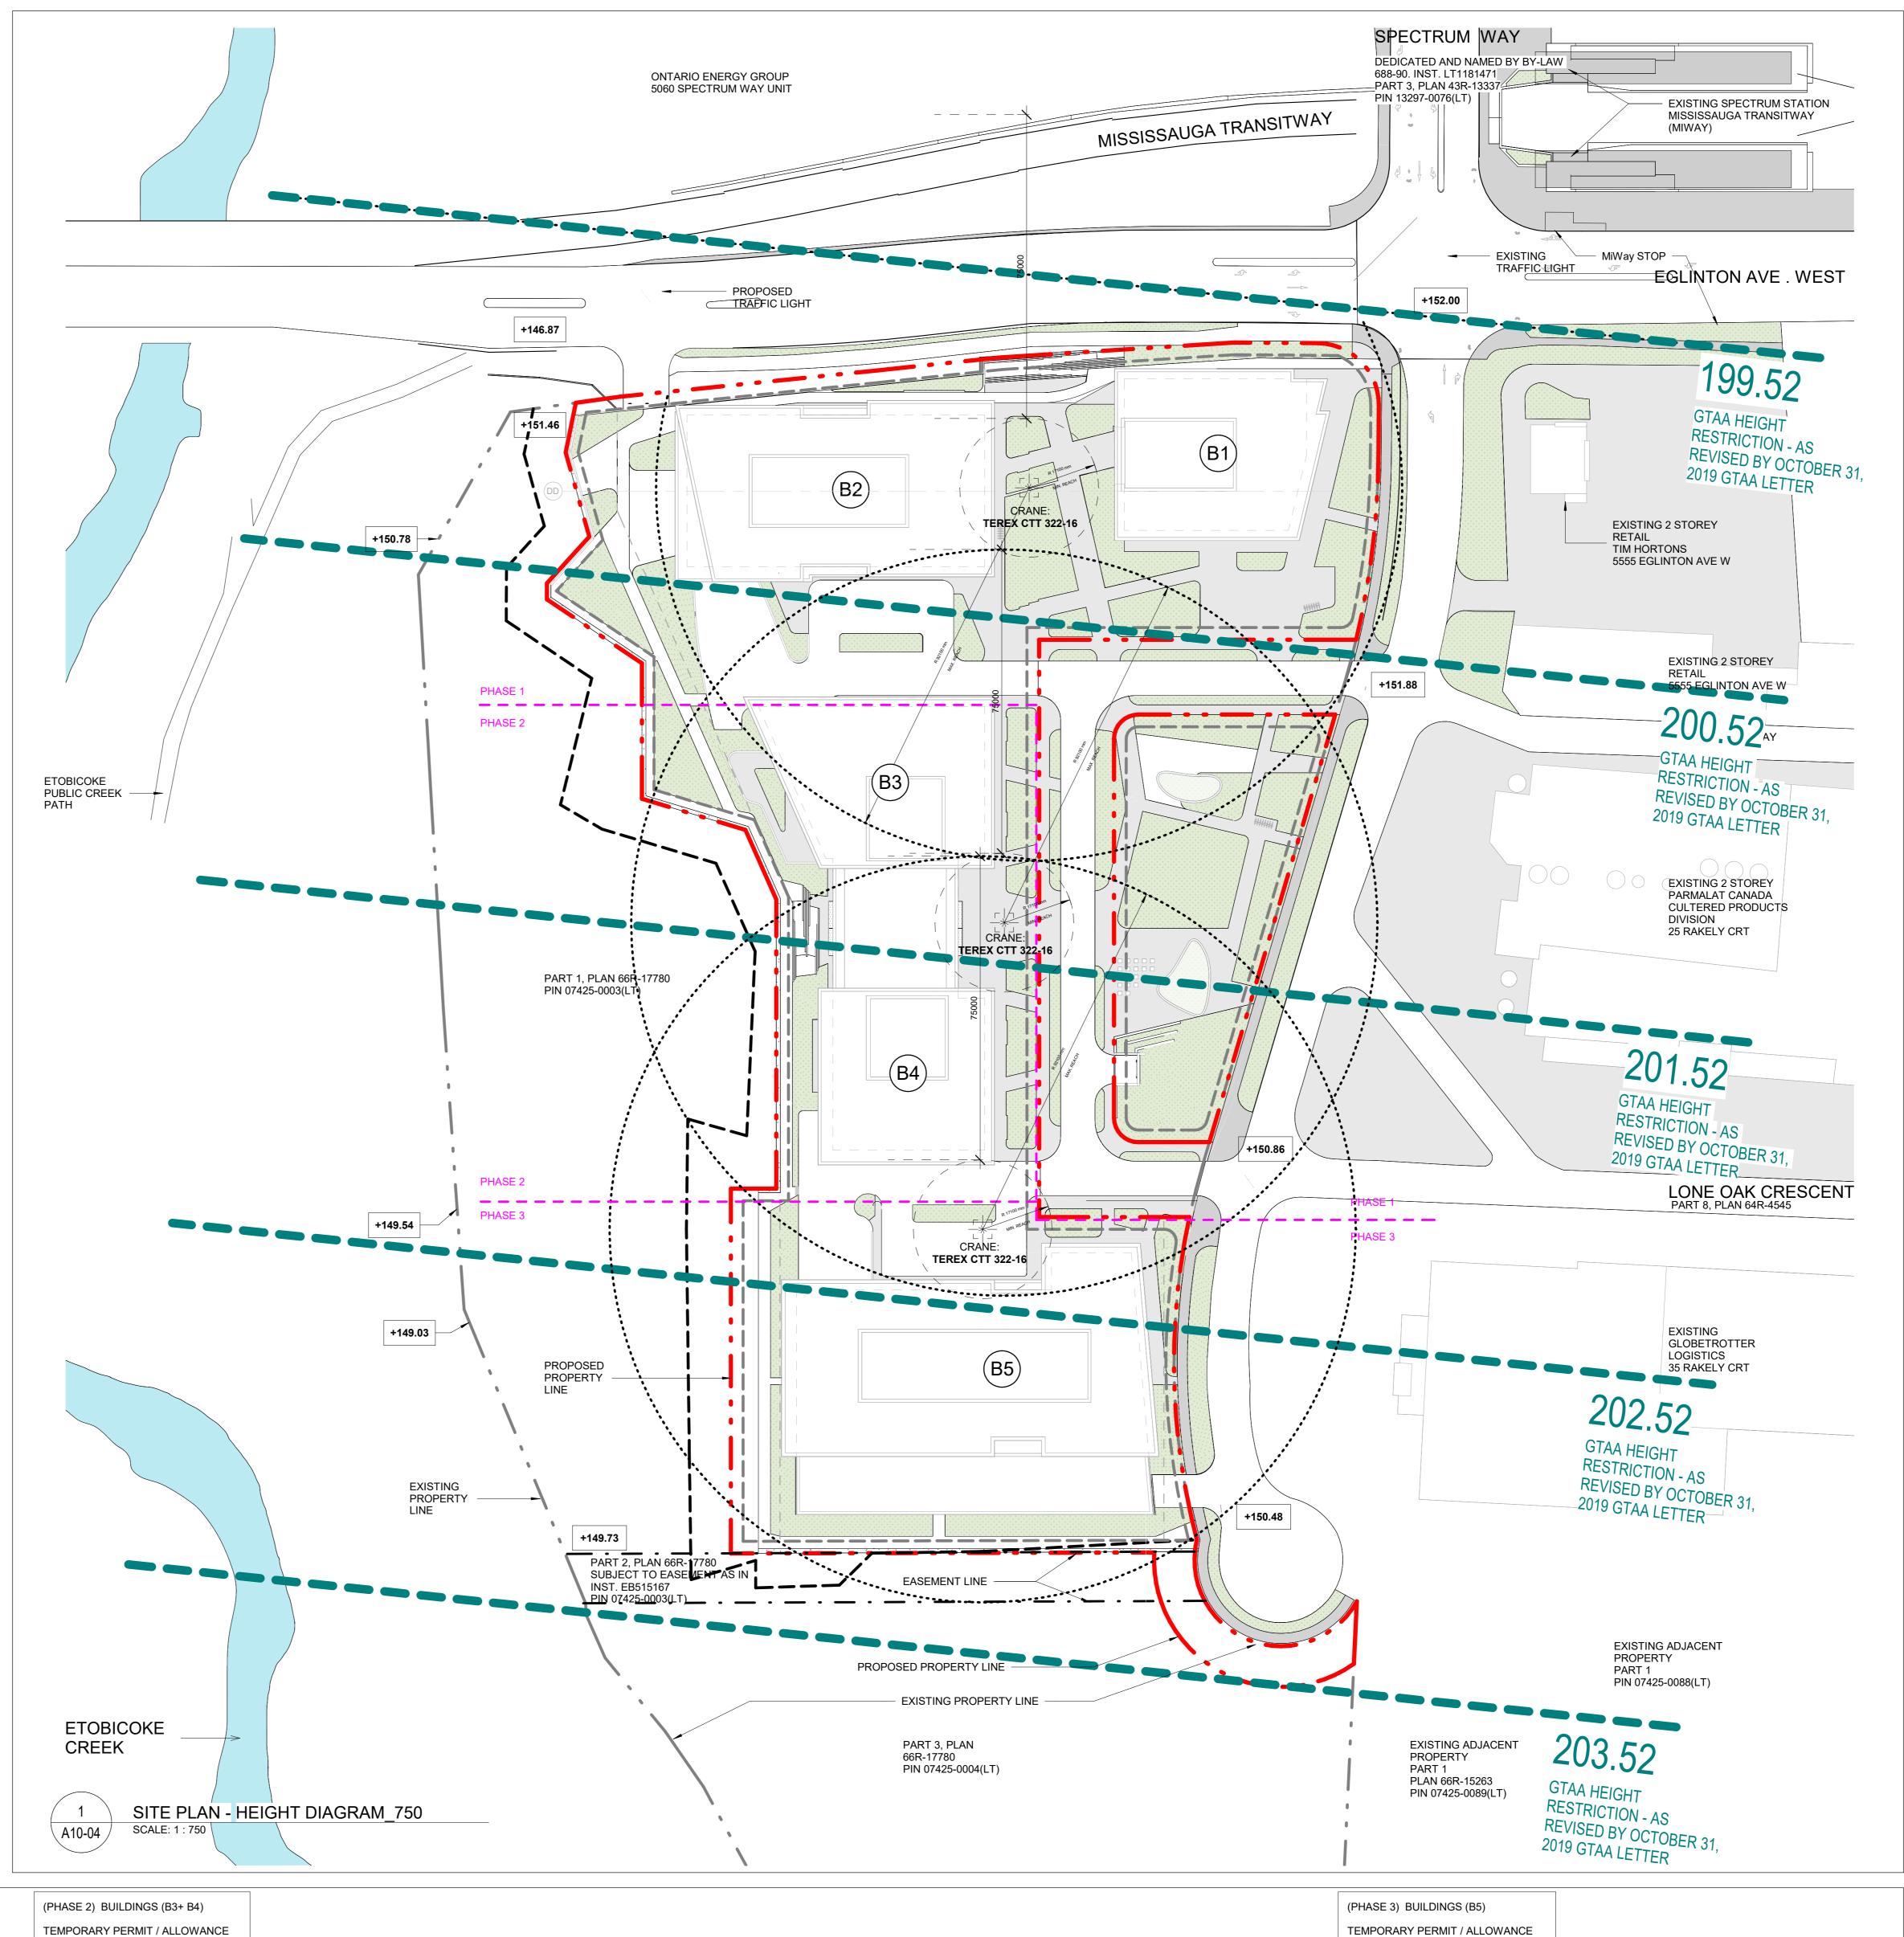

204.00

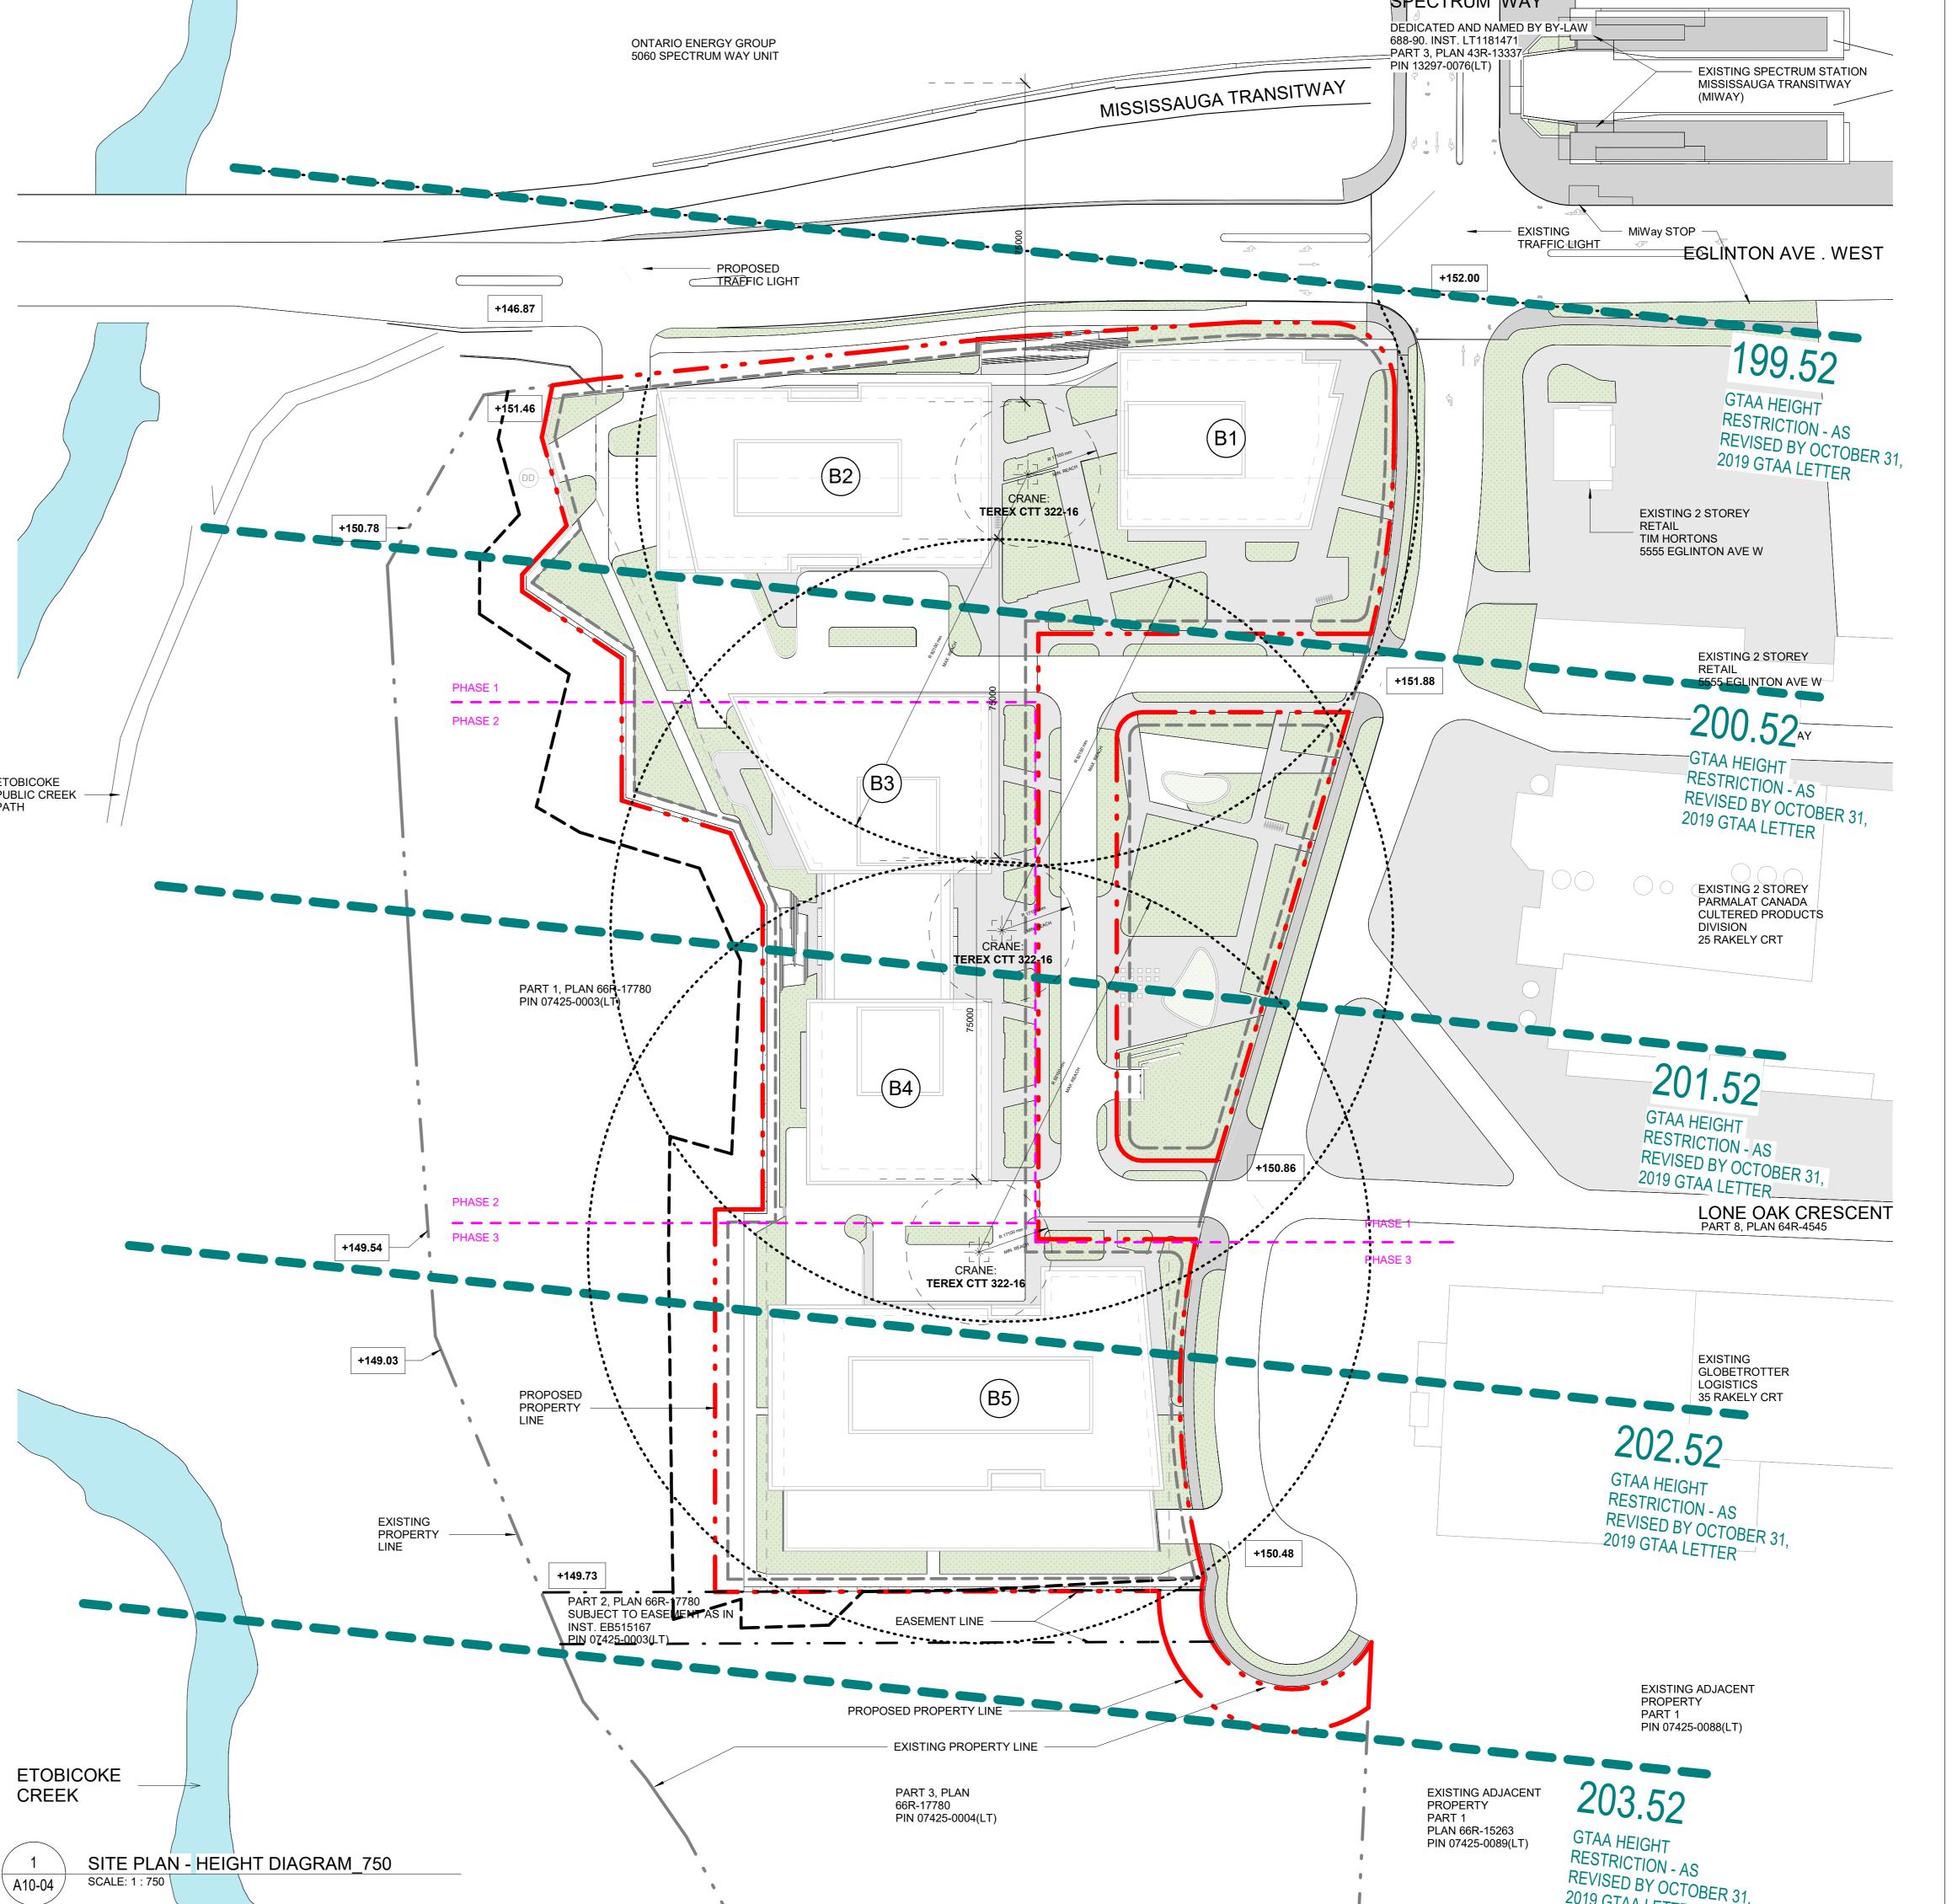


TO EXCEED EXISTING GTAA 202.52 HEIGHT RESTRICTION

TEMPORARY PERMIT OF ADDITIONAL

1.48M = TOTAL HEIGHT OF 204.00 FOR DURATION OF CONSTRUCTION


REQUEST:

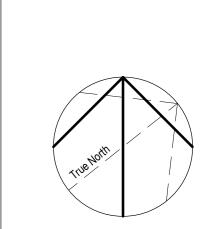


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ISSUED FOR

2021-01-15 ZONING BY-LAW AMENDMENT 2022-10-03 ZONING BY-LAW AMENDMENT

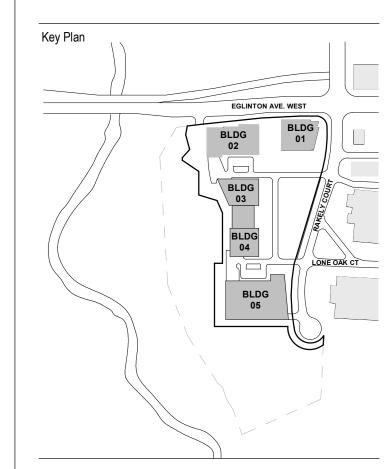

Consultants Civil: R.J. BURNSIDE & ASSOCIATES LIMITED JANET ROSENBERG & STUDIO INC. Landscape: NORR ARCHITECTS AND ENGINEERS LIMITED Architecture: NORR ARCHITECTS AND ENGINEERS LIMITED NORR ARCHITECTS AND ENGINEERS LIMITED Mechanical: NORR ARCHITECTS AND ENGINEERS LIMITED Electrical: Traffic: BA CONSULTING GROUP LTD Planning: Consultant: URBAN STRATEGIES INC. GABRIEL FAIN ARCHITECTS INC.

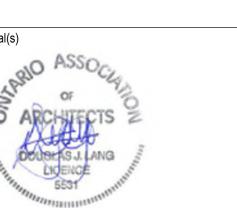

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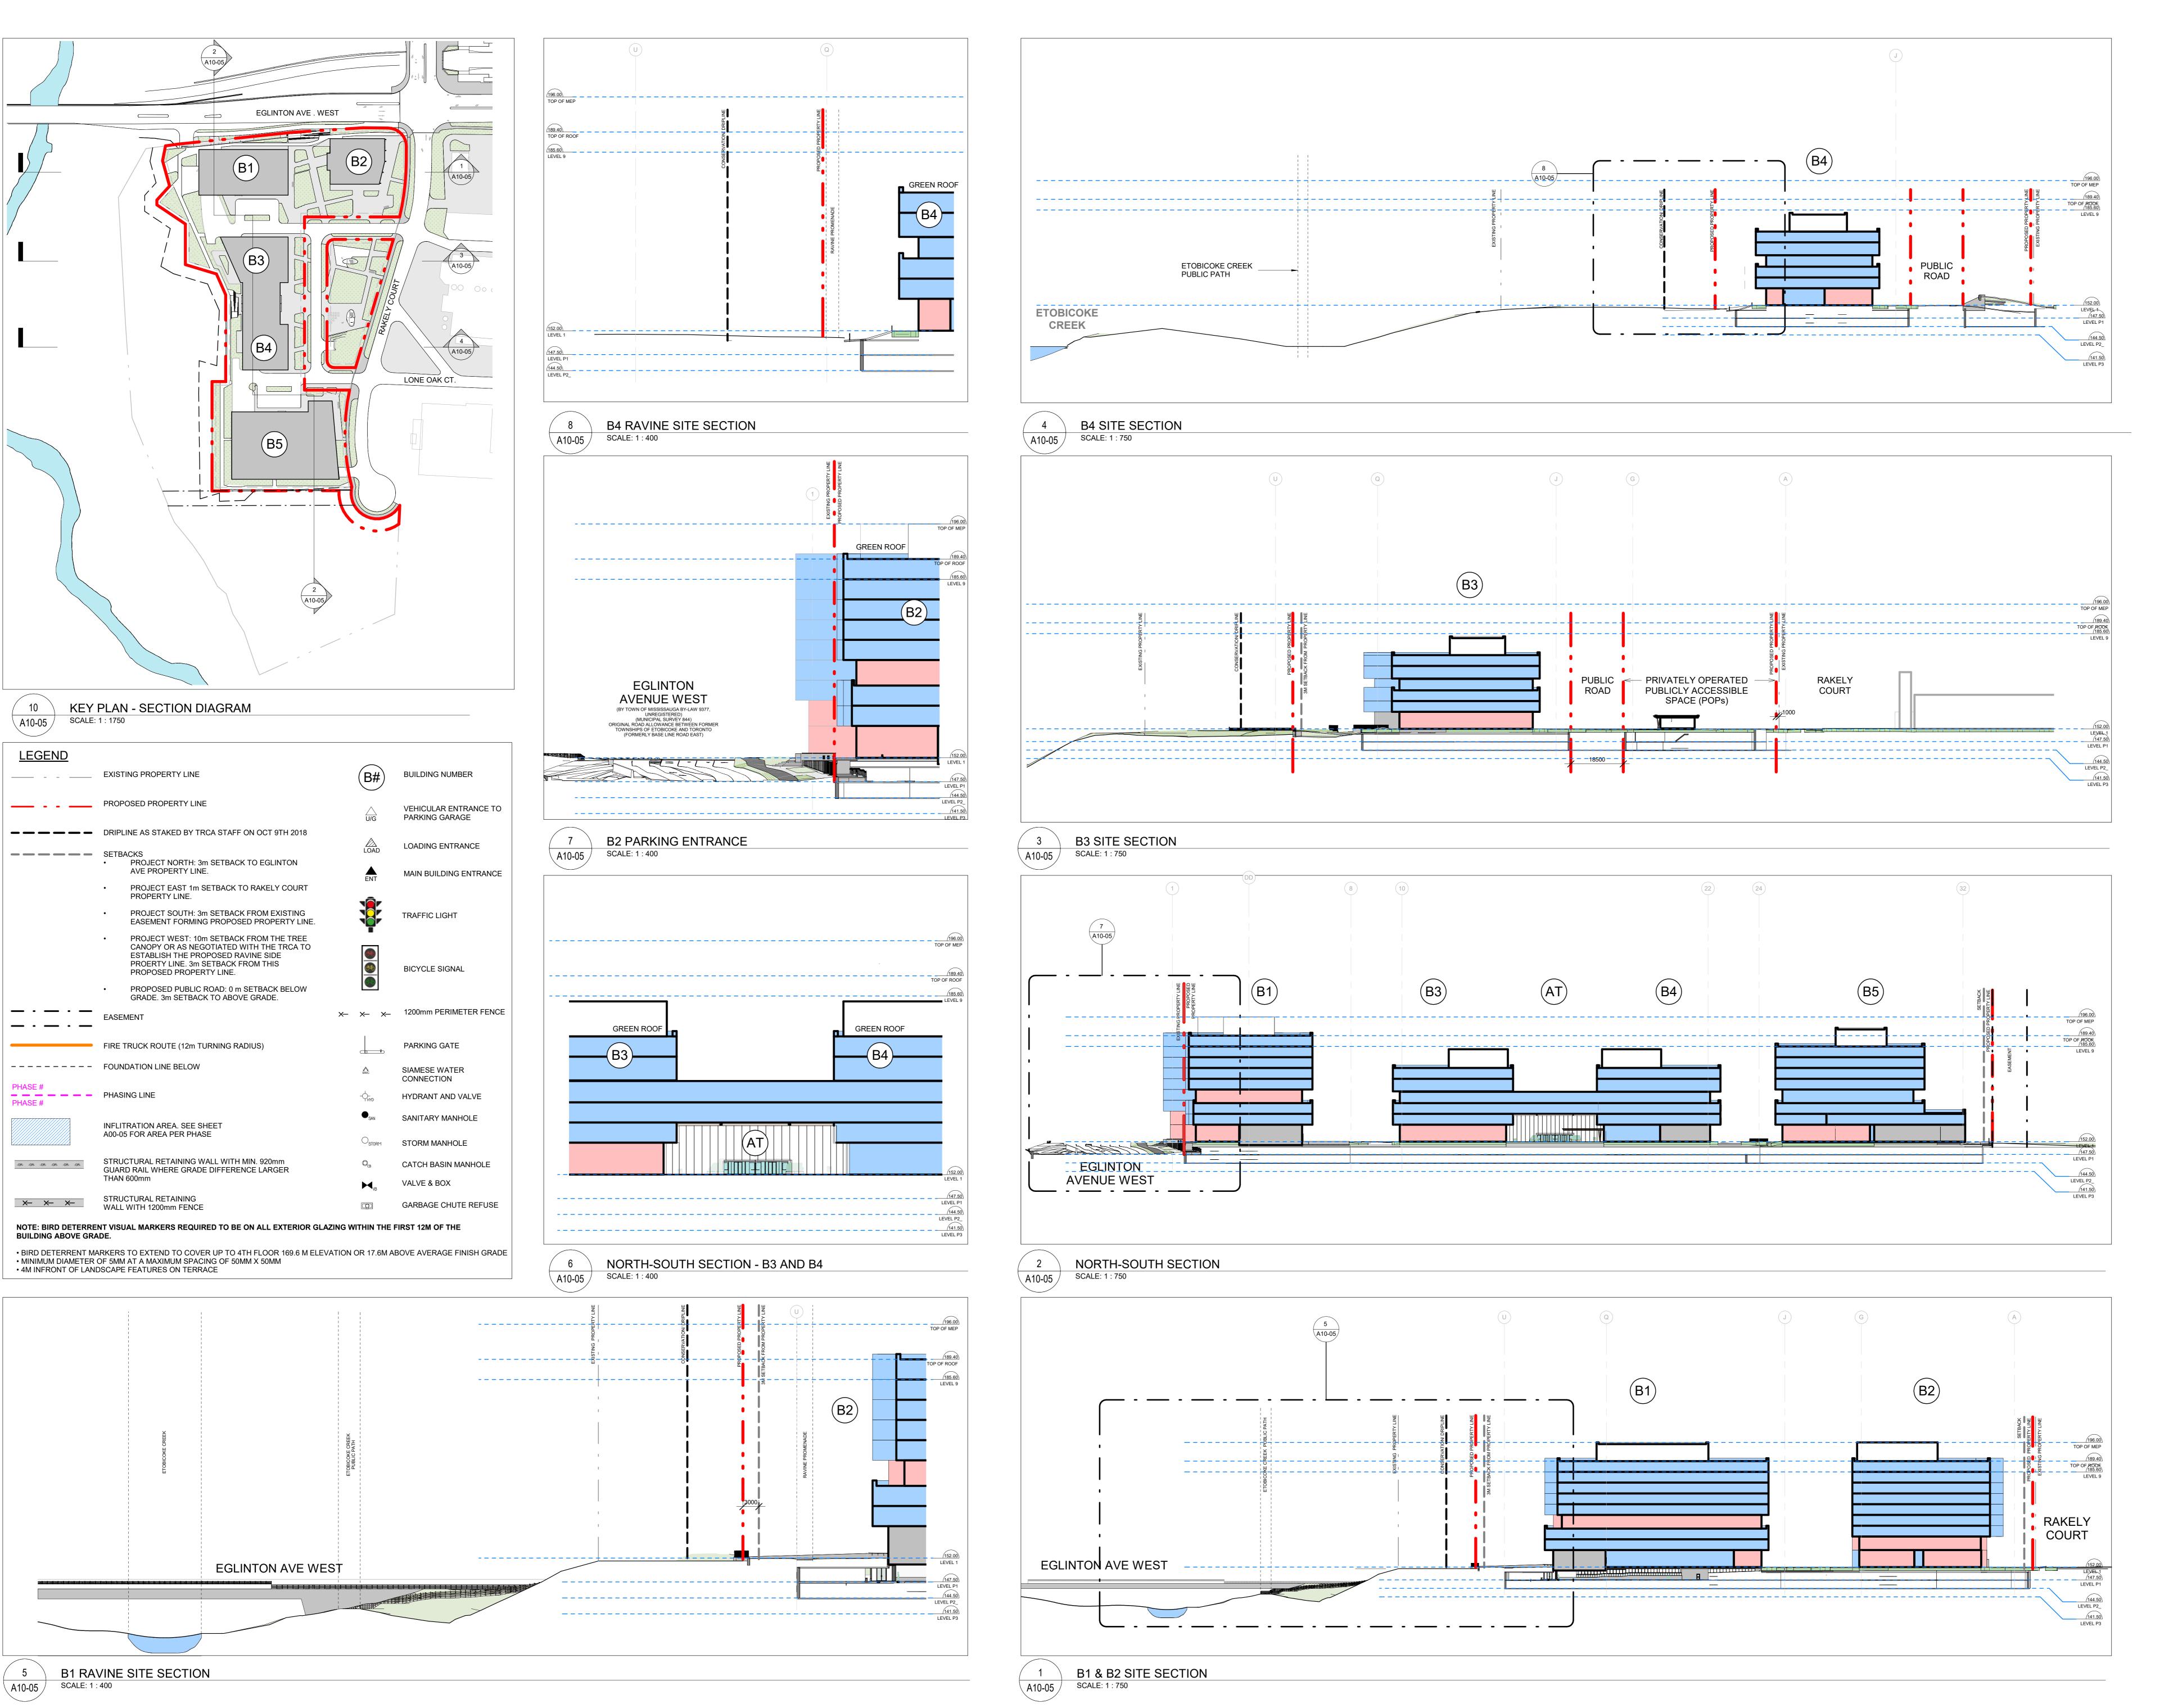
Rakely Eglinton Corporate Centre, Limited Partnership


40 RAKELY COURT, TORONTO, ON, M9C 5A5


GTAA HEIGHT DIAGRAM

As indicated Project No. ONBL 18-0225


Drawing No.



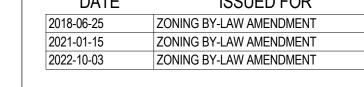

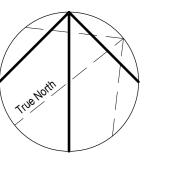

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R.J. BURNSIDE & ASSOCIATES LIMITED JANET ROSENBERG & STUDIO INC. NORR ARCHITECTS AND ENGINEERS LIMITED Architecture: NORR ARCHITECTS AND ENGINEERS LIMITED NORR ARCHITECTS AND ENGINEERS LIMITED Mechanical: NORR ARCHITECTS AND ENGINEERS LIMITED Electrical: BA CONSULTING GROUP LTD Planning: Consultant: URBAN STRATEGIES INC. GABRIEL FAIN ARCHITECTS INC.

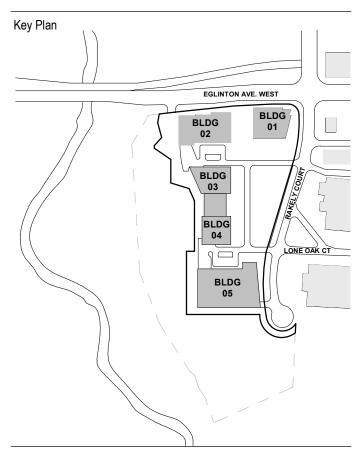NORR Architects & Engineers Limited An Ingenium Group Company 175 Bloor St. East North Tower, 15th Floor Toronto, ON Canada M4W 3R8

Rakely Eglinton Corporate Centre, Limited Partnership

40 RAKELY COURT, TORONTO, ON, M9C 5A5

Drawing Title
SITE SECTIONS

As indicated ONBL 18-0225 Drawing No. A10-05

Project No.

11-0062 2018-05

11-0062 2018-05

11-0062 2018-05

Checklist - Toronto Green Standards Version 3.0

#### Checklist - Toronto Green Standards Version 3.0 Mid to High Rise Residential and all New Non-Residential Development Section Development Tier 1 Performance Measure Documentation for site plan approval Plans and Drawings

Section	Feature	(See full standards and specifications for details and definitions)	(Sections marked with an asterisk are required for rezoning applications)	Plans and Drawings
EC 1.3	Parking Lots	1 shade tree planted parking lots area for every 5 parking spaces	Notations indicate soil volume (soil depth and area), species and quantity on the Planting Plan for parking areas	Plan #To be provided for SPA
EC 1.4	Watering Program	Watering program for trees.	Notations on the Planting Plan include watering program methods and watering schedule.	Plan #To be provided for SPA
EC 2.1	Ravine Areas and Natural Heritage System	Natural Heritage System and the Ravine Protected Area planted with 100% native plants.	Plant list identifies native or non- native species.	Plan #To be provided for SPA
EC 2.2	Ravine and Protected Area Buffers	Stewardship plan implemented for setbacks	Stewardship Plan (if applicable)	Plan #See Tree Preservation Plants & Arborist Repo
EC 3.1	Native and Pollinator Supportive Species	Landscape includes 50% native plants.	Plant list includes common name, scientific name, size, quantity, stock type, and native or non-native species.	Plan #To be provided for SPA
EC 3.2	Invasive Species	No invasive species planted	Plant list includes common name and scientific name.	Plan #To be provided for SPA
EC 4.1	Bird Friendly Glazing	85% of all exterior glazing within the required area is treated to reduce bird collisions.  Fly-through conditions treated at all heights of the building.	TGS V3.0 statistics template  Notations include treated area required, type of treatment, density and colour of visual markers.  Summary table of bird friendly glass treatments for each elevation.	Plan #A10-03 - see legend for note on bird friendly glazing; further information to b provided at SP

Section	Development Feature	Tier 1 Performance Measure (See full standards and specifications for details and definitions)	Documentation for site plan approval (Sections marked with an asterisk are required for rezoning applications)	Plans and Drawings
EC 4.2	Rooftop Vegetation	Glazing 4 m above rooftop vegetation is treated to reduce bird collisions.	Notations include required treated area, type of treatment, density and colour of visual markers.	Plan # A10-03 - see legend for notes on bird friendly glazing: further information to be provided at SPA
EC 4.3	Grate Porosity	Maximum porosity of ventilation grates is 20 mm X 20 mm.	Notations indicate porosity of ground level grates.	Plan # To be provided for SPA
EC 5.1	Exterior Lighting	Dark Sky compliant fixtures.	Notations indicate Dark Sky compliant fixtures.	Plan # To be provided for SPA
ier 1: So	lid Waste			
Section	Development Feature	Tier 1 Performance Measure (See full standards and specifications for details and definitions)	Documentation for site plan approval (Sections marked with an asterisk are required for rezoning applications)	Plans and Drawings
SW 1.1	Waste Collection & Sorting	Waste sorting system for garbage, recycling and organics. (Residential)	Notations indicate type and location of waste sorting sytstem.	Plan # N/A
SW 1.2	Waste Storage Space	Waste storage rooms	Notations indicate area and location of waste storage rooms.	Plan # A20-0P1 A20-01
SW 1.3	Bulky Waste	Provide 10m² for bulky and special collection items. (Residential)	Notations indicate area and location for bulky items collection.	Plan # N/A
SW 1.4	Compaction	Waste storage room with space for containers and the compactor unit.	Notations indicate area and location of waste storage rooms and	Plan # N/A

11-0062 2018-05			

Section	Development Feature	Tier 1 Performance Measure (See full standards and specifications for details and definitions)	Documentation for site plan approval (Sections marked with an asterisk are required for rezoning applications)	Plans and Drawings
SW 3.1	Construction Waste Management	Manage construction and demolition waste in accordance with O. Reg. 103/94	Documentation in accordance with O.Reg 103/94	Plan # To be provided for SPA

fici	ficiency,	, GHGs & Resilience			
opme re	opment	Tier 1 Performance Measure (See full standards and specifications for details and definitions)	Documentation for site plan approval (Sections marked with an asterisk are required for rezoning applications)	Plan	ns and Drawings
ngs y man	-	Design the building to achieve 15% improvement above OBC, SB-10, Division 3 (2017); OR TEUI, TEDI and GHGI targets by building type. (required for Tier 2)	Energy (Modelling) Report and Energy Workbook prior to NOAC (if applicable)	Plan	# See revised Energy Modeling Report
		uality & Efficiency		_	
opme re	opment re	Tier 1 Performance Measure (See full standards and specifications for details and definitions)	Documentation for site plan approval (Sections marked with an asterisk are required for rezoning applications)	Plan	ns and Drawings

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#### Statistics Template - Toronto Green Standard Version 3.0 Mid to High Rise Residential and all New Non-Residential Development

The Toronto Green Standard Version 3.0 Statistics Template is submitted with Site Plan Control Applications and stand alone Zoning Bylaw Amendment applications. Complete the table and copy it directly onto the

Site Plan submitted as part of the application. For Zoning Bylaw Amendment applications: complete General Project Description and Section 1.

For Site Plan Control applications: complete General Project Description, Section 1 and Section 2. For further information, please visit www.toronto.ca/greendevelopment

General Project Description	Proposed
Total Gross Floor Area	92,653m²
Breakdown of project components (m²)	
Residential	N/A
Retail	9,267m²
Commercial	83,385m²
Industrial	N/A
Institutional/Other	N/A
Total number of residential units	N/A

#### Section 1: For Stand Alone Zoning Bylaw Amendment Applications and Site Plan Control Applications

Site Plan Control Applications
Automobile Infrastructure

Checklist - Toronto Green Standards Version 3.0

Checklist - Toronto Green Standards Version 3.0

Impact Study

an # No parking spaces to be dedicated to

only electric

Page 2 of 8

an # A00-02

Plan # A00-02

Checklist - Toronto Green Standards Version 3.0

Plan # A20-0P1

Plan # To be provided

Checklist - Toronto Green Standards Version 3.0

Statistics Templates on A10-06, and

drawings A10-05 & A20-08

Plan # See revised Functional

Documentation for site plan approval Plans and Drawings

Page 3 of 8

Documentation for site plan approval Plans and Drawings

Notations indicate location and the Plan # A10-02

✓ Notations on Plans and Drawings. Plan #A20-01

✓ Notations on Plans and Drawings. Plan #A20-01

Notations on Plans and Drawings. Plan # To be provided

Mid to High Rise Residential and all New Non-Residential Development

Business Telephone Number: 416-340-9004 ext 217

Mid to High Rise Residential and all New Non-Residential Development

required for rezoning applications)

TGS V3.0 statistics template.

and location of LEV spaces.

Project parking statistics include number and location of EVSE spaces

Notations indicate location of EVSE spaces and roughed-in spaces on

Project statistics include rates,

number and type (long-term/short term) of bicycle parking spaces.

Summary table includes number,

type and % of net floor area occupied by bicycle parking for each

Mid to High Rise Residential and all New Non-Residential Development

required for rezoning applications)

✓ number of short-term spaces in

Notations indicate location and ✓ number of shower and change

TGS V3.0 statistics template.

Notations indicate location of

albedo paving

Mid to High Rise Residential and all New Non-Residential Development

required for rezoning applications)

Notations include green roof

Materials list includes SRI of high

bicycle parking floor and at-grade.

TGS V3.0 statistics template.

Summary table includes number

Reduce single occupancy vehicles trips by 15%.

Transportation Impact Study (TIS) Plan # See updated Includes TDM analysis (if applicable) Transportation

Documentation for site plan approval Plans and Drawings

Business Email: aiannucci@urbanstrategies.com Registered Owner (First, Last Name): Rakely Eglinton Corporate Centre LP

TGS Documentation includes the submission of the completed Tier 1 TGS Checklist and the Statistics template updated with each planning submission. All sections must be complete for SPA. The TGS Statistics template is provided on the Project Statistics Plan with each submission in

(See full standards and specifications for | (Sections marked with an asterisk are

Complete in conjunction with the full Toronto Green Standard Version 3.0 (TGS V3.0) and Specifications.

Application Information:

Community Planner (First, Last Name):

Property and Applicant Information

Project Name: 40 RAKELY COURT

Name (First, Last Name): Anna lannucci

Applicant/Agent

11-0062 2018-05

Tier 1: Air Quality

\*AQ 1.1 Single-Occupant

\*AQ 1.2 LEV and

11-0062 2018-05

\*AQ 2.3 Short-term

\*AQ 2.4 Shower &

AQ 3.4 Pedestrian

11-0062 2018-05

WQ 1.1 Erosion & Sediment Control

Hardscape

Location

Change Facilities

Page 6 of 8

Vehicle Trips

Sustainable

Non Residential Gross Floor Area (m²): 92,653m²

Office campus development comprising of five buildings,

multi-story buildings varied in height from 4-9 storeys, with retail at grade and a variety of open spaces.

Site Plan Control Zoning Bylaw Amendment Draft Plan of Subdivision

Is this checklist revised from an earlier submission? ✓ Yes ☐ No

Gross Floor Area (m²): 92,653m² Number of Storeys: 85=8,AT=4 Number of Units: 414

Proposal Description: (Include a narrative of your project highlighting green attributes or performances measures)

Address of Subject Land (Street Number and Name): 40 RAKELY COURT, TORONTO, ON, M9C 5A5

For project pursuing Tier 2, 3 and 4, a separate TGS High Performance checklist must be submitted.

Dedicate parking spaces above the

minimum required for low-emitting

\*AQ 2.1 Bicycle Parking Bicycle parking rates in accordance with VTGS V3.0 statistics template.

\*AQ 2.2 Long-term Bicycle Parking Location Plan # A20-0P1

(See full standards and specifications for | (Sections marked with an asterisk are

AQ 3.2 Sidewalk Space Minimum 2.1 meter pedestrian clearway V Notations on Plans and Drawings. Plan # A10-02

details and definitions)

vehicles (LEV).

Infrastructure spaces. Roughed-in conduits for the

\*AQ 1.3 Electric Vehicle Install EVSE for 20% of the parking

Section Development Tier 1 Performance Measure

AQ 3.1 Connectivity Pedestrian walkways

details and definitions)

Bicycle Parking | accordance with Zoning Bylaw 569-201

Short-term bicycle parking in

Shower and change facilities in accordance with Zoning Bylaw 569-2

overed outdoor waiting areas

reduce the urban heat island (75%

75% of the required parking spaces

under cover. (Non-residential only)

Pedestrian-scale lighting

required for Tier 2); OR

details and definitions)

all that apply):

AQ 4.2 Green & Cool One of the following is provided (select TGS V3.0 statistics template.

Green roof for 50% of roof;
Cool roof installed for 100% of roof;

| Cool roof plans.

A combination of a green roof, and cool roof and solar panels for at least 75% of roof.

Notations include SRI of cool roof on roof plan and location of solar panels.

Apply the Erosion and Sediment Control | Notations on Plans and Drawings

Green Roof required under the Green Roof By-Law

Green roof for 50% of roof;

AQ 4.1 UHI Non-roof Treat 50% of non-roof hardscape to

Section Development Tier 1 Performance Measure

Application Number: Date Received (yyyy-mm-dd):

Tier 1 performance measures are required by the City and must be included as part of your approved development application.

Tier 2, 3 and 4 higher performance levels are voluntary and are associated with financial incentives. To determine eligibility for incentives

Automobile Infrastructure	Required	Proposed	Proposed %
Number of Parking Spaces	1390	1485	106.8%
Number of parking spaces dedicated for priority LEV parking	0	0	
Number of parking spaces with EVSE	371	378	101.8%
Cycling Infrastructure	Required	Proposed	Proposed %
Number of long-term bicycle parking spaces (residential)	N/A	N/A	N/A
Number of long-term bicycle parking spaces (all other uses)	120	143	119.1%
Number of long-term bicycle parking (all uses) located on:			
a) first storey of building			
b) second storey of building			
c) first level below-ground	120	143	119.1%
d) second level below-ground			
e) other levels below-ground			







#### Statistics Template - Toronto Green Standard Version 3.0 Mid to High Rise Residential and all **New Non-Residential Development**

Cycling Infrastructure	Required	Proposed	Proposed %
Number of short-term bicycle parking spaces (residential)	N/A	N/A	N/A
Number of short-term bicycle parking spaces (all other uses)	154	185	120%
Number of male shower and change facilities (non-residential)	3	5	167%
Number of female shower and change facilities (non-residential)	3	5	167%
Tree Planting & Soil Volume	Required	Proposed	Proposed %
Total Soil Volume (40% of the site area + 66 m <sup>2</sup> x 30 m <sup>3</sup> ).		To be provided for SPA	

## Section 2: For Site Plan Control Applications

Available Roof Space provided as Solar Panels (m2)

Cycling Infrastructure	Required	Proposed	Proposed %
Number of short-term bicycle parking spaces (all uses) at-grade or on first level below grade			
UHI Non-roof Hardscape	Required	Proposed	Proposed %
Total non-roof hardscape area (m²)			
Total non-roof hardscape area treated for Urban Heat Island (minimum 50%) (m²)			
Area of non-roof hardscape treated with: (indicate m²)			
a) high-albedo surface material			
b) open-grid pavement			
c) shade from tree canopy			
d) shade from high-albedo structures			
e) shade from energy generation structures			
Percentage of required car parking spaces under cover (minimum 75%)(non-residential only)			
Green & Cool Roofs	Required	Proposed	Proposed %
Available Roof Space (m²)			
Available Roof Space provided as Green Roof (m²)			
Available Roof Space provided as Cool Roof (m²)			

## Statistics Template - Toronto Green Standard Version 3.0 Mid to High Rise Residential and all

**New Non-Residential Development** 

Water Efficiency	Required	Proposed	Proposed %
Total landscaped site area (m²)			
Landscaped site area planted with drought-tolerant plants (minimum 50%) (m² and %) (if applicable)			
Tree Planting Areas & Soil Volume	Required	Proposed	Proposed %
Total site area (m²)			
Total Soil Volume (40% of the site area + 66 m²x 30 m³)			
Total number of planting areas (minimum of 30m³ soil)			
Total number of trees planted			
Number of surface parking spaces (if applicable)			
Number of shade trees located in surface parking area interior (minimum 1 tree for 5 parking spaces)			
Native and Pollinator Supportive Species	Required	Proposed	Proposed %
Total number of plants			
Total number of native plants and % of total plants (min.50%)			
Bird Friendly Glazing	Required	Proposed	Proposed %
Total area of glazing of all elevations within 12m above grade (including glass balcony railings)			
Total area of treated glazing (minimum 85% of total area of glazing within 12m above grade) (m²)			
Percentage of glazing within 12m above grade treated with:			
a) Low reflectance opaque materials			
b) Visual markers			

The Green Roof Statistics Template is required to be submitted for Site Plan Control Applications where a green roof is required under the Toronto Municipal Code Chapter 492, Green Roofs. Complete the table below and copy it directly onto the Roof Plan submitted as part of any Site Plan Control Application requiring a green roof in accordance with the Bylaw. Refer to Section § 492-1 of the Municipal Code for a complete list of defined terms, and greater clarity and certainty regarding the intent and application of the terms included in the template. The Toronto Municipal Code Chapter 492, Green Roofs can be found online at: http://www.toronto.ca/legdocs/municode/1184\_492.pdf

#### Green Roof Statistics - Phase 1, Building 2

		Proposed
Gross Floor Area, as defined in Green Roof Bylaw (m2)		25,022m1
Total Roof Area (m2)		3388m²
Area of Residential Private Terraces (m2)		0
Rooftop Outdoor Amenity Space, if in a Residential Building (m2)		0
Area of Renewable Energy Devices (m <sup>2</sup> )		0
Tower (s)Roof Area with floor plate less than 750	m <sup>2</sup>	0
Total Available Roof Space (m²)		3388m²
Green Roof Coverage	Required	Proposed
Coverage of Available Roof Space (m²)	2002m²	2,550mF
Coverage of Available Roof Space (%)	60%	75%

Gross Floor Area (Size of Building)	Coverage of Available Roof Spac (Size of Green Roof)	
2,000 - 4,999 square metres	20 percent	
5,000 - 9,999 square metres	30 percent	
10,000 - 14,999 square metres	40 percent	
15,000 - 19,999 square metres	50 percent	
20,000 square metres or greater	60 percent	

**Green Roof Statistics** 

The Green Roof Statistics Template is required to be submitted for Site Plan Control Applications where a green roof is required under the Toronto Municipal Code Chapter 492, Green Roofs, Complete the table below and copy it directly onto the Roof Plan

submitted as part of any Site Plan Control Application requiring a green roof in accordance with the Bylaw. Refer to Section § 492-

the terms included in the template. The Toronto Municipal Code Chapter 492, Green Roofs can be found online at:

1 of the Municipal Code for a complete list of defined terms, and greater clarity and certainty regarding the intent and application of

## Green Roof Statistics - Phase 1, Building 1

http://www.toronto.ca/legdocs/municode/1184\_492.pdf

	Pi
Gross Floor Area, as defined in Green Roof Bylaw (m2)	- 10
Total Roof Area (m²)	
Area of Residential Private Terraces (m2)	
Rooftop Outdoor Amenity Space, if in a Residential Building (m2)	
Area of Renewable Energy Devices (m²)	
Tower (s)Roof Area with floor plate less than 750 m <sup>2</sup>	
Total Available Roof Space (m²)	
Green Roof Coverage Require	d P
Coverage of Available Roof Space (m²)	
Coverage of Available Roof Space (%) 50%	

Gross Floor Area (Size of Building)	Coverage of Available Roof Space (Size of Green Roof)
2,000 - 4,999 square metres	20 percent
5,000 - 9,999 square metres	30 percent
10,000 - 14,999 square metres	40 percent
15,000 - 19,999 square metres	50 percent
20,000 square metres or greater	60 percent

The Green Roof Statistics Template is required to be submitted for Site Plan Control Applications where a green roof is required under the Toronto Municipal Code Chapter 492, Green Roofs. Complete the table below and copy it directly onto the Roof Plan submitted as part of any Site Plan Control Application requiring a green roof in accordance with the Bylaw. Refer to Section § 492-1 of the Municipal Code for a complete list of defined terms, and greater clarity and certainty regarding the intent and application of the terms included in the template. The Toronto Municipal Code Chapter 492, Green Roofs can be found online at: http://www.toronto.ca/legdocs/municode/1184\_492.pdf

**Green Roof Statistics** 

#### Green Roof Statistics - Phase 2, Atrium

**M** TORONTO

		Proposed
Gross Floor Area, as defined in Green Roof Bylaw (m2)	)	1699m²
Total Roof Area (m <sup>2</sup> )		879m²
Area of Residential Private Terraces (m²)		0
Rooftop Outdoor Amenity Space, if in a Residential Building (m2)		0
Area of Renewable Energy Devices (m <sup>2</sup> )		0
Tower (s)Roof Area with floor plate less than 750 m <sup>2</sup>		0
Total Available Roof Space (m²)		679m <sup>2</sup>
Green Roof Coverage	Required	Proposed
Coverage of Available Roof Space (m <sup>2</sup> )	Om <sup>2</sup>	640m²
Coverage of Available Roof Space (%)	0%	73%

Gross Floor Area (Size of Building)	Coverage of Available Roof Space (Size of Green Roof)	
2,000 - 4,999 square metres	20 percent	
5,000 - 9,999 square metres	30 percent	
10,000 - 14,999 square metres	40 percent	
15,000 - 19,999 square metres	50 percent	
20,000 square metres or greater	60 percent	

IUKUNIU City Plenning Division	Green Roof Statistic

under the Toronto Municipal Code Chapter 492, Green Roofs. Complete the table below and copy it directly onto the Roof Plan submitted as part of any Site Plan Control Application requiring a green roof in accordance with the Bylaw. Refer to Section § 492-1 of the Municipal Code for a complete list of defined terms, and greater clarity and certainty regarding the intent and application of the terms included in the template. The Toronto Municipal Code Chapter 492, Green Roofs can be found online at: http://www.toronto.ca/legdocs/municode/1184\_492.pdf

The Green Roof Statistics Template is required to be submitted for Site Plan Control Applications where a green roof is required

### Green Roof Statistics - Phase 2, Building 3

		Proposed
Gross Floor Area, as defined in Green Roof Bylaw (m2)		11,304erf
Total Roof Area (m²)		2060m²
Area of Residential Private Terraces (m <sup>2</sup> )		0
Rooftop Outdoor Amenity Space, if in a Residential Building (m2)		0
Area of Renewable Energy Devices (m2)		0
Tower (s)Roof Area with floor plate less than 750 m <sup>2</sup>		0
Total Available Roof Space (m²)		2090m²
Green Roof Coverage	Required	Proposed
Coverage of Available Roof Space (m²)	836m <sup>2</sup>	1,382mF
Coverage of Available Roof Space (%)	40%	66%

Gross Floor Area (Size of Building)	Coverage of Available Roof Space (Size of Green Roof)
2,000 - 4,999 square metres	20 percent
5,000 - 9,999 square metres	30 percent
10,000 - 14,999 square metres	40 percent
15,000 - 19,999 square metres	50 percent
20,000 square metres or greater	60 percent

The Green Roof Statistics Template is required to be submitted for Site Plan Control Applications where a green roof is required under the Toronto Municipal Code Chapter 492, Green Roofs. Complete the table below and copy it directly onto the Roof Plan submitted as part of any Site Plan Control Application requiring a green roof in accordance with the Bylaw. Refer to Section § 492-1 of the Municipal Code for a complete list of defined terms, and greater clarity and certainty regarding the intent and application of the terms included in the template. The Toronto Municipal Code Chapter 492, Green Roofs can be found online at:

## Green Roof Statistics - Phase 3, Building 5

http://www.toronto.ca/legdocs/municode/1184\_492.pdf

		Proposed
Gross Floor Area, as defined in Green Roof Bylaw (m2)		28,368m1
Total Roof Area (m2)		5,485W1
Area of Residential Private Terraces (m²)		0
Rooftop Outdoor Amenity Space, if in a Residential Building (m2)		0
Area of Renewable Energy Devices (m2)		0
Tower (s)Roof Area with floor plate less than 750 m <sup>2</sup>		0
Total Available Roof Space (m2)		5465m/
Green Roof Coverage	Required	Proposed
Coverage of Available Roof Space (m²)	3279m²	3363m²
Coverage of Available Roof Space (%)	60%	62%

Gross Floor Area (Size of Building)	Coverage of Available Roof Space (Size of Green Roof)
2,000 - 4,999 square metres	20 percent
5,000 - 9,999 square metres	30 percent
10,000 - 14,999 square metres	40 percent
15,000 - 19,999 square metres	50 percent
20,000 square metres or greater	60 percent

**Green Roof Statistics** 

The Green Roof Statistics Template is required to be submitted for Site Plan Control Applications where a green roof is required under the Toronto Municipal Code Chapter 492, Green Roofs, Complete the table below and copy it directly onto the Roof Plan submitted as part of any Site Plan Control Application requiring a green roof in accordance with the Bylaw. Refer to Section § 492-1 of the Municipal Code for a complete list of defined terms, and greater clarity and certainty regarding the intent and application of the terms included in the template. The Toronto Municipal Code Chapter 492, Green Roofs can be found online at: http://www.toronto.ca/legdocs/municode/1184\_492.pdf

## Green Roof Statistics - Phase 2, Building 4

		Propos
Gross Floor Area, as defined in Green Roof Bylaw (m2)		9,5676
Total Roof Area (m2)		1800#
Area of Residential Private Terraces (m2)		0
Rooftop Outdoor Amenity Space, if in a Residentia	l Building (m²)	0
Area of Renewable Energy Devices (m <sup>2</sup> )		0
Tower (s)Roof Area with floor plate less than 750 n	n <sup>2</sup>	0
Total Available Roof Space (m²)		1800m
Green Roof Coverage	Required	Propos
Coverage of Available Roof Space (m <sup>2</sup> )	540m²	1,0651
Coverage of Available Roof Space (%)	30%	59%

Gross Floor Area (Size of Building)	Coverage of Available Roof Space (Size of Green Roof)
2,000 - 4,999 square metres	20 percent
5,000 - 9,999 square metres	30 percent
10,000 - 14,999 square metres	40 percent
15,000 - 19,999 square metres	50 percent
20,000 square metres or greater	60 percent


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ZONING BY-LAW AMENDMENT

2022-10-03 ZONING BY-LAW AMENDMENT

2021-01-15



Consultants R.J. BURNSIDE & ASSOCIATES LIMITED JANET ROSENBERG & STUDIO INC. Landscape: Architecture: NORR ARCHITECTS AND ENGINEERS LIMITED NORR ARCHITECTS AND ENGINEERS LIMITED NORR ARCHITECTS AND ENGINEERS LIMITED Mechanical: NORR ARCHITECTS AND ENGINEERS LIMITED BA CONSULTING GROUP LTD Planning: Consultant: URBAN STRATEGIES INC. GABRIEL FAIN ARCHITECTS INC.

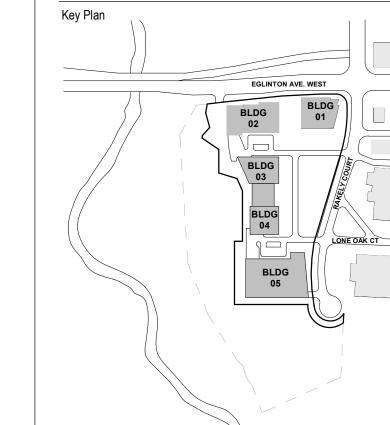Civil:

Structural:

Electrical: Traffic:

NORR Architects & Engineers Limited An Ingenium Group Company 175 Bloor St. East North Tower, 15th Floor Toronto, ON Canada M4W 3R8


Rakely Eglinton Corporate Centre, Limited Partnership

40 RAKELY COURT, TORONTO, ON, M9C 5A5

TGS CHECKLIST

Project No. ONBL 18-0225 Drawing No. A10-06

11-0063 2018-05 Page 3 of 3

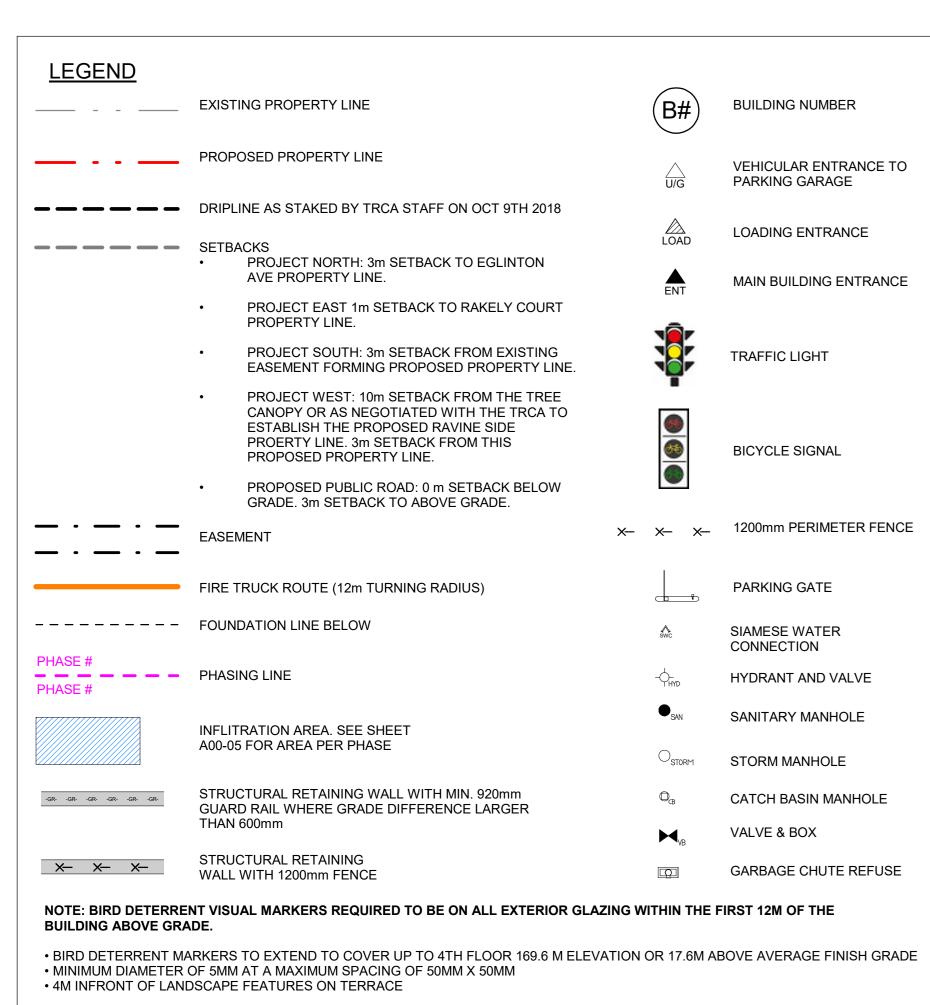

CIRCULATION

ELEVATORS

SERVICE


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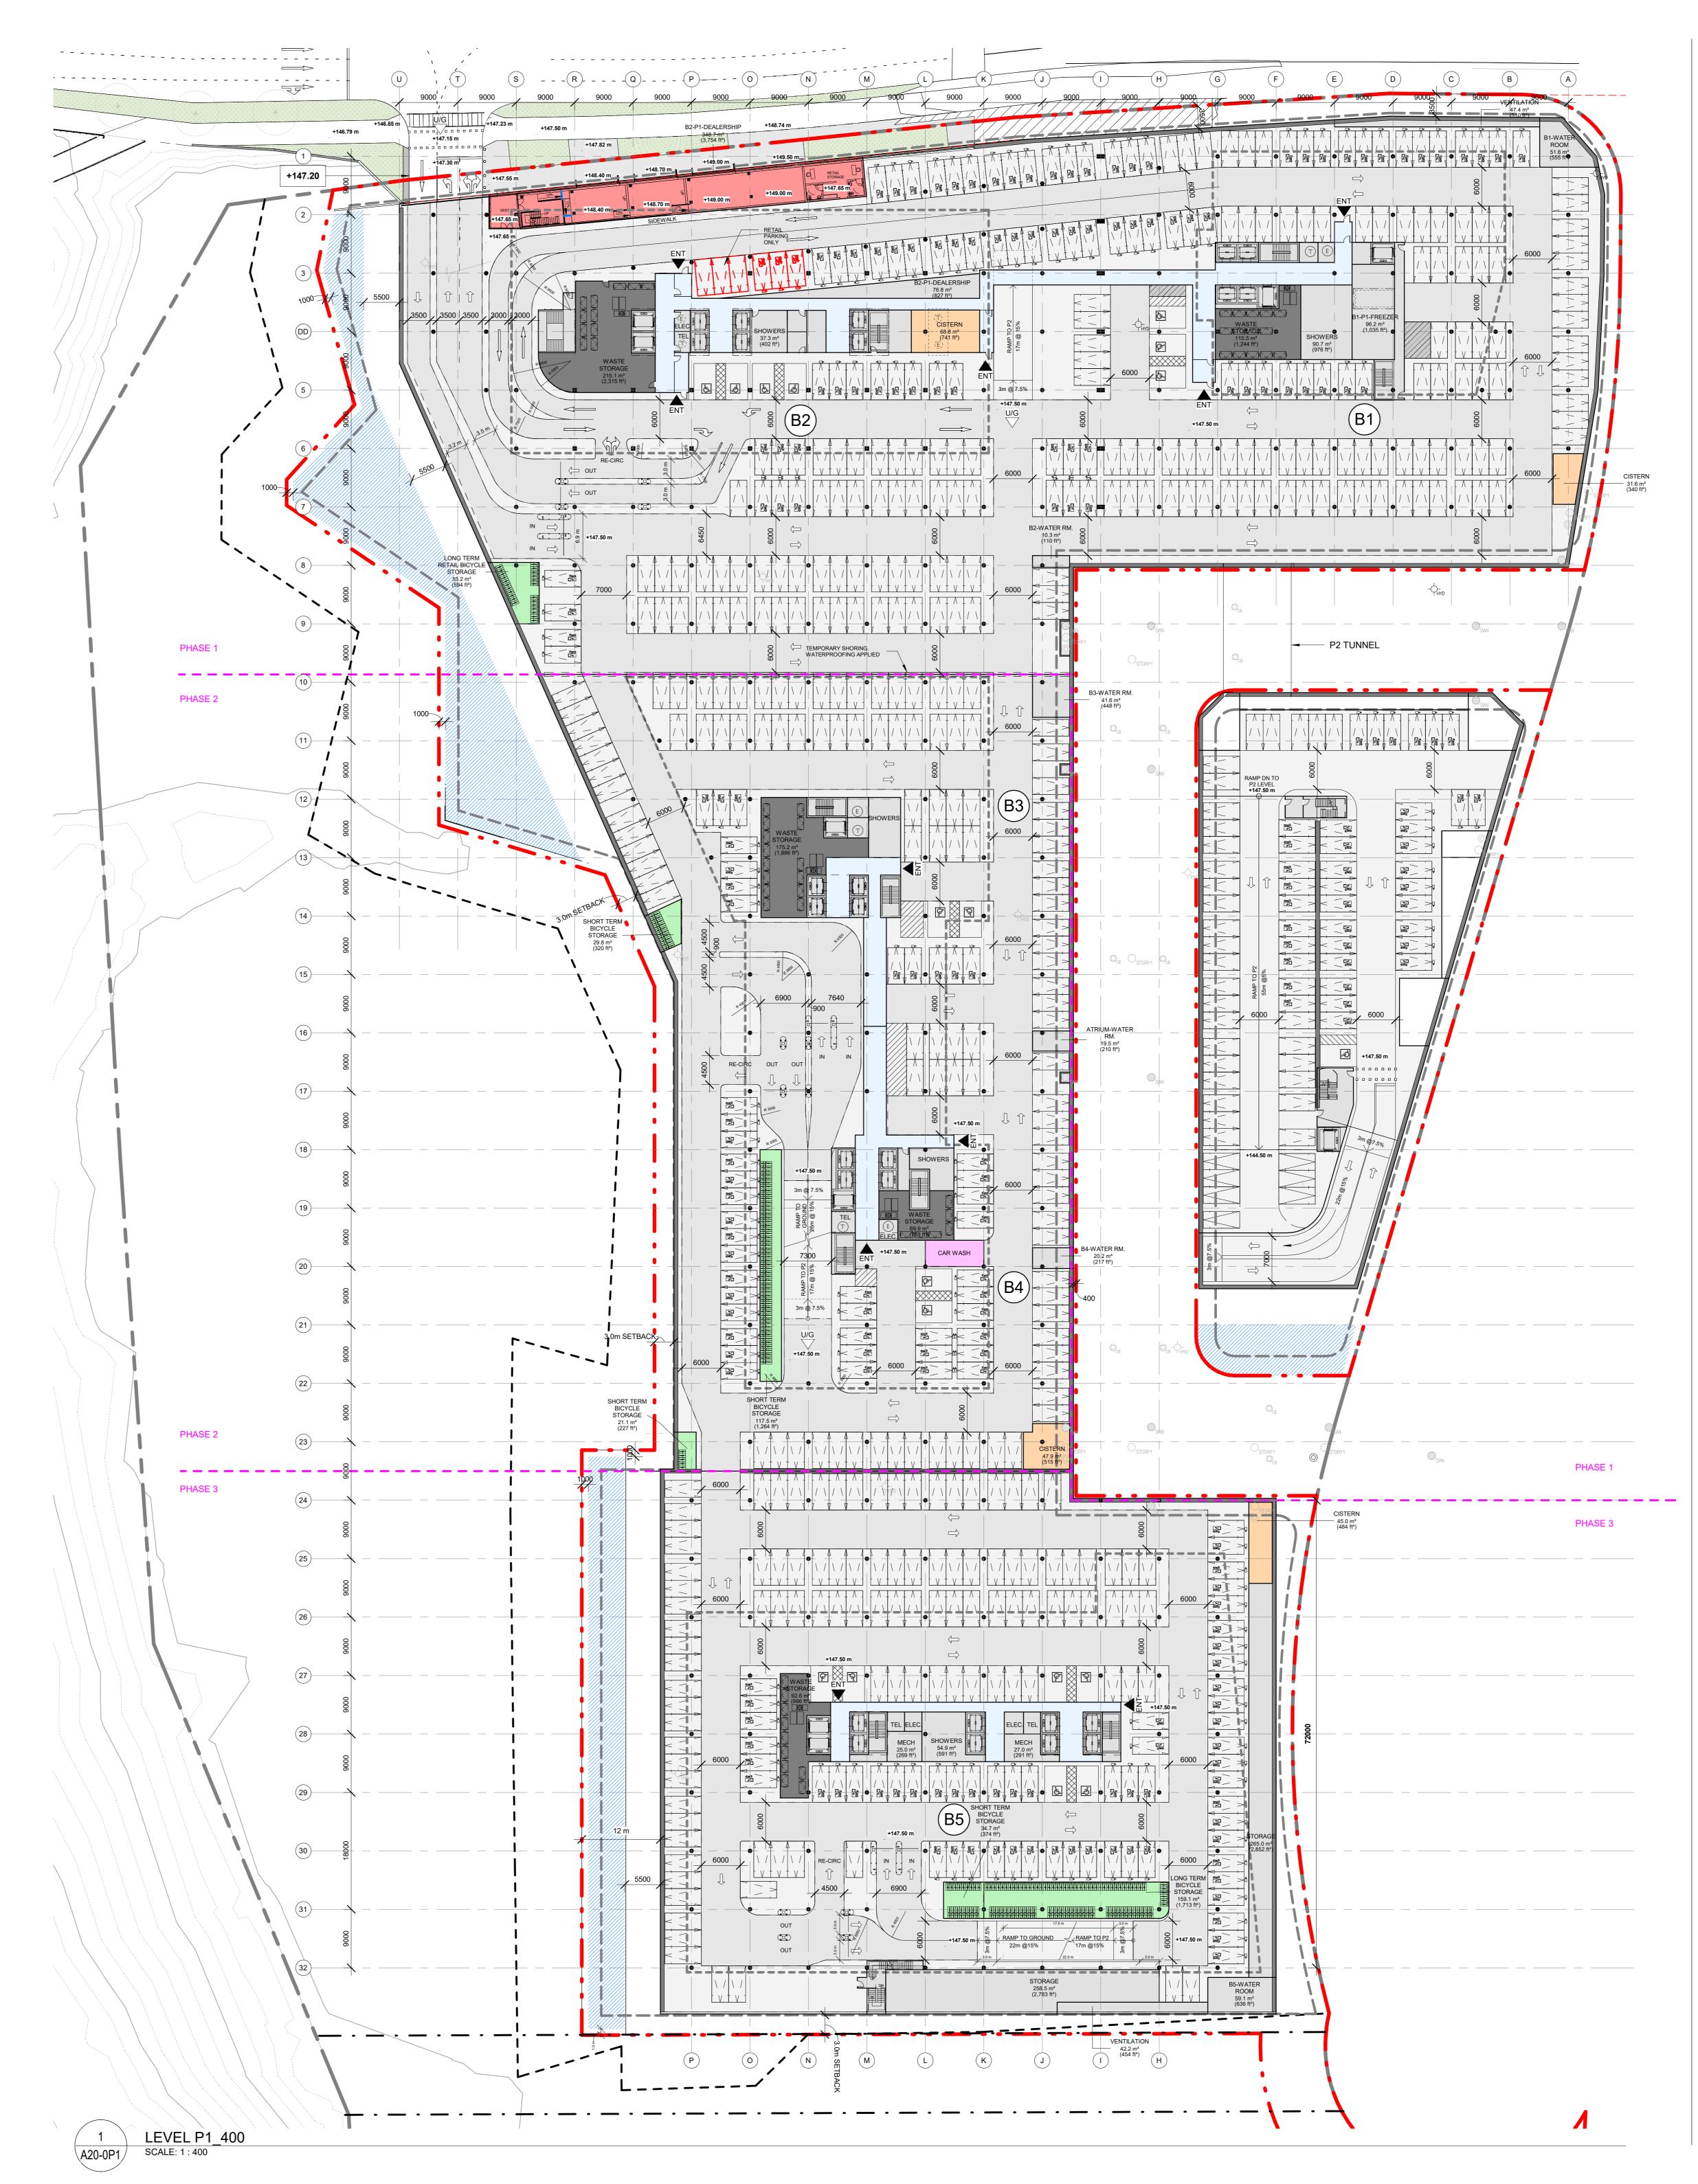
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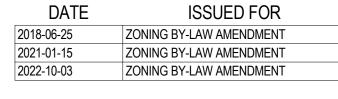
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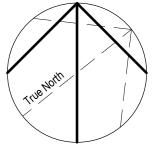
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CAR WASH








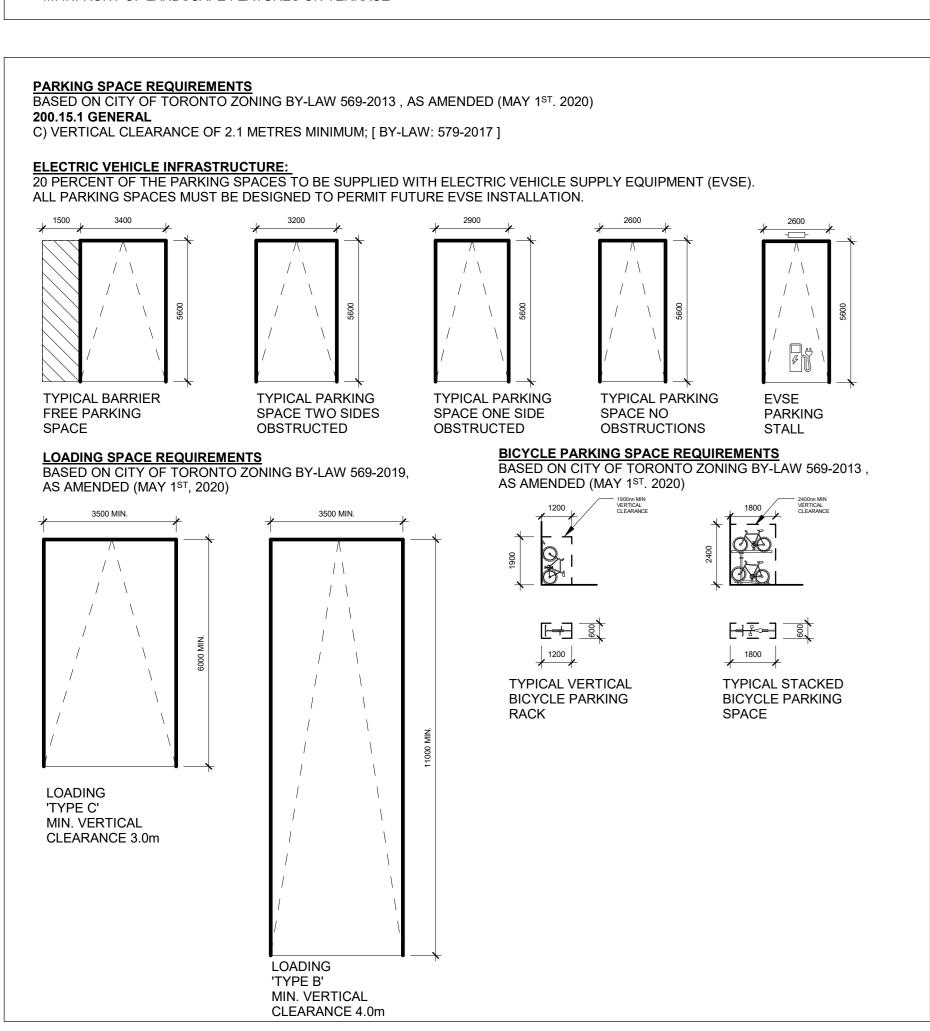

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Landscape: JANET ROSENBERG & STUDIO INC.
Architecture: NORR ARCHITECTS AND ENGINEERS LIMITED
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Mechanical: NORR ARCHITECTS AND ENGINEERS LIMITED
Electrical: NORR ARCHITECTS AND ENGINEERS LIMITED
NORR ARCHITECTS AND ENGINEERS LIMITED
Traffic: BA CONSULTING GROUP LTD
Planning: URBAN STRATEGIES INC.
Consultant: GABRIEL FAIN ARCHITECTS INC.

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Toronto, ON Canada M4W 3R8

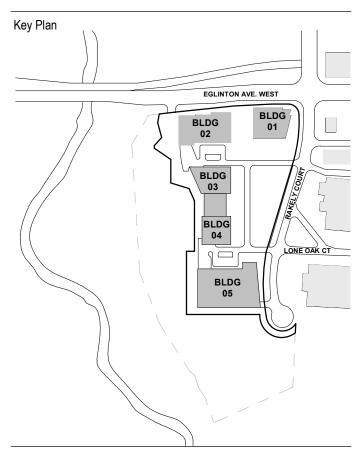Rakely Eglinton Corporate
Centre, Limited Partnership

40 RAKELY COURT, TORONTO, ON, M9C 5A5

Drawing Title

LEVEL P1


As indicated

Project No.

ONBL 18-0225

Drawing No.

A20-0P1

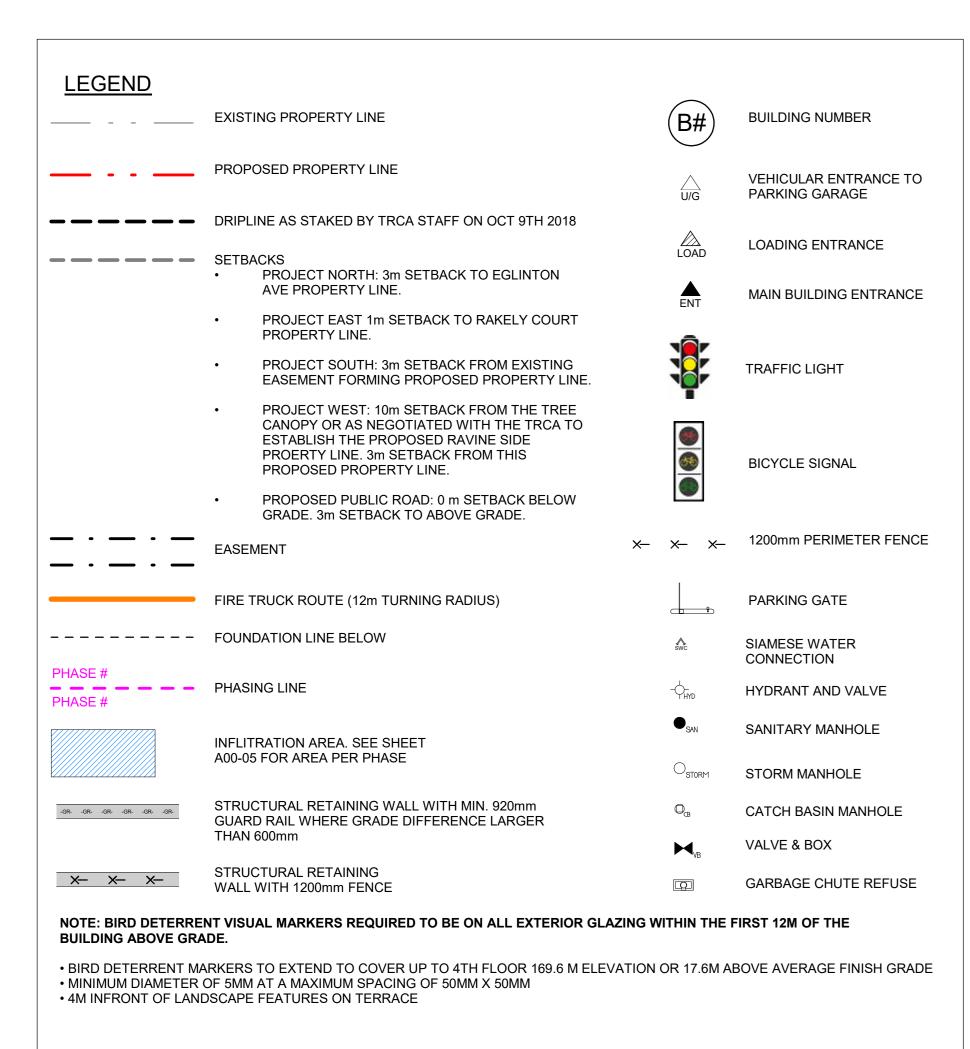

CIRCULATION

STAIRS

SERVICE


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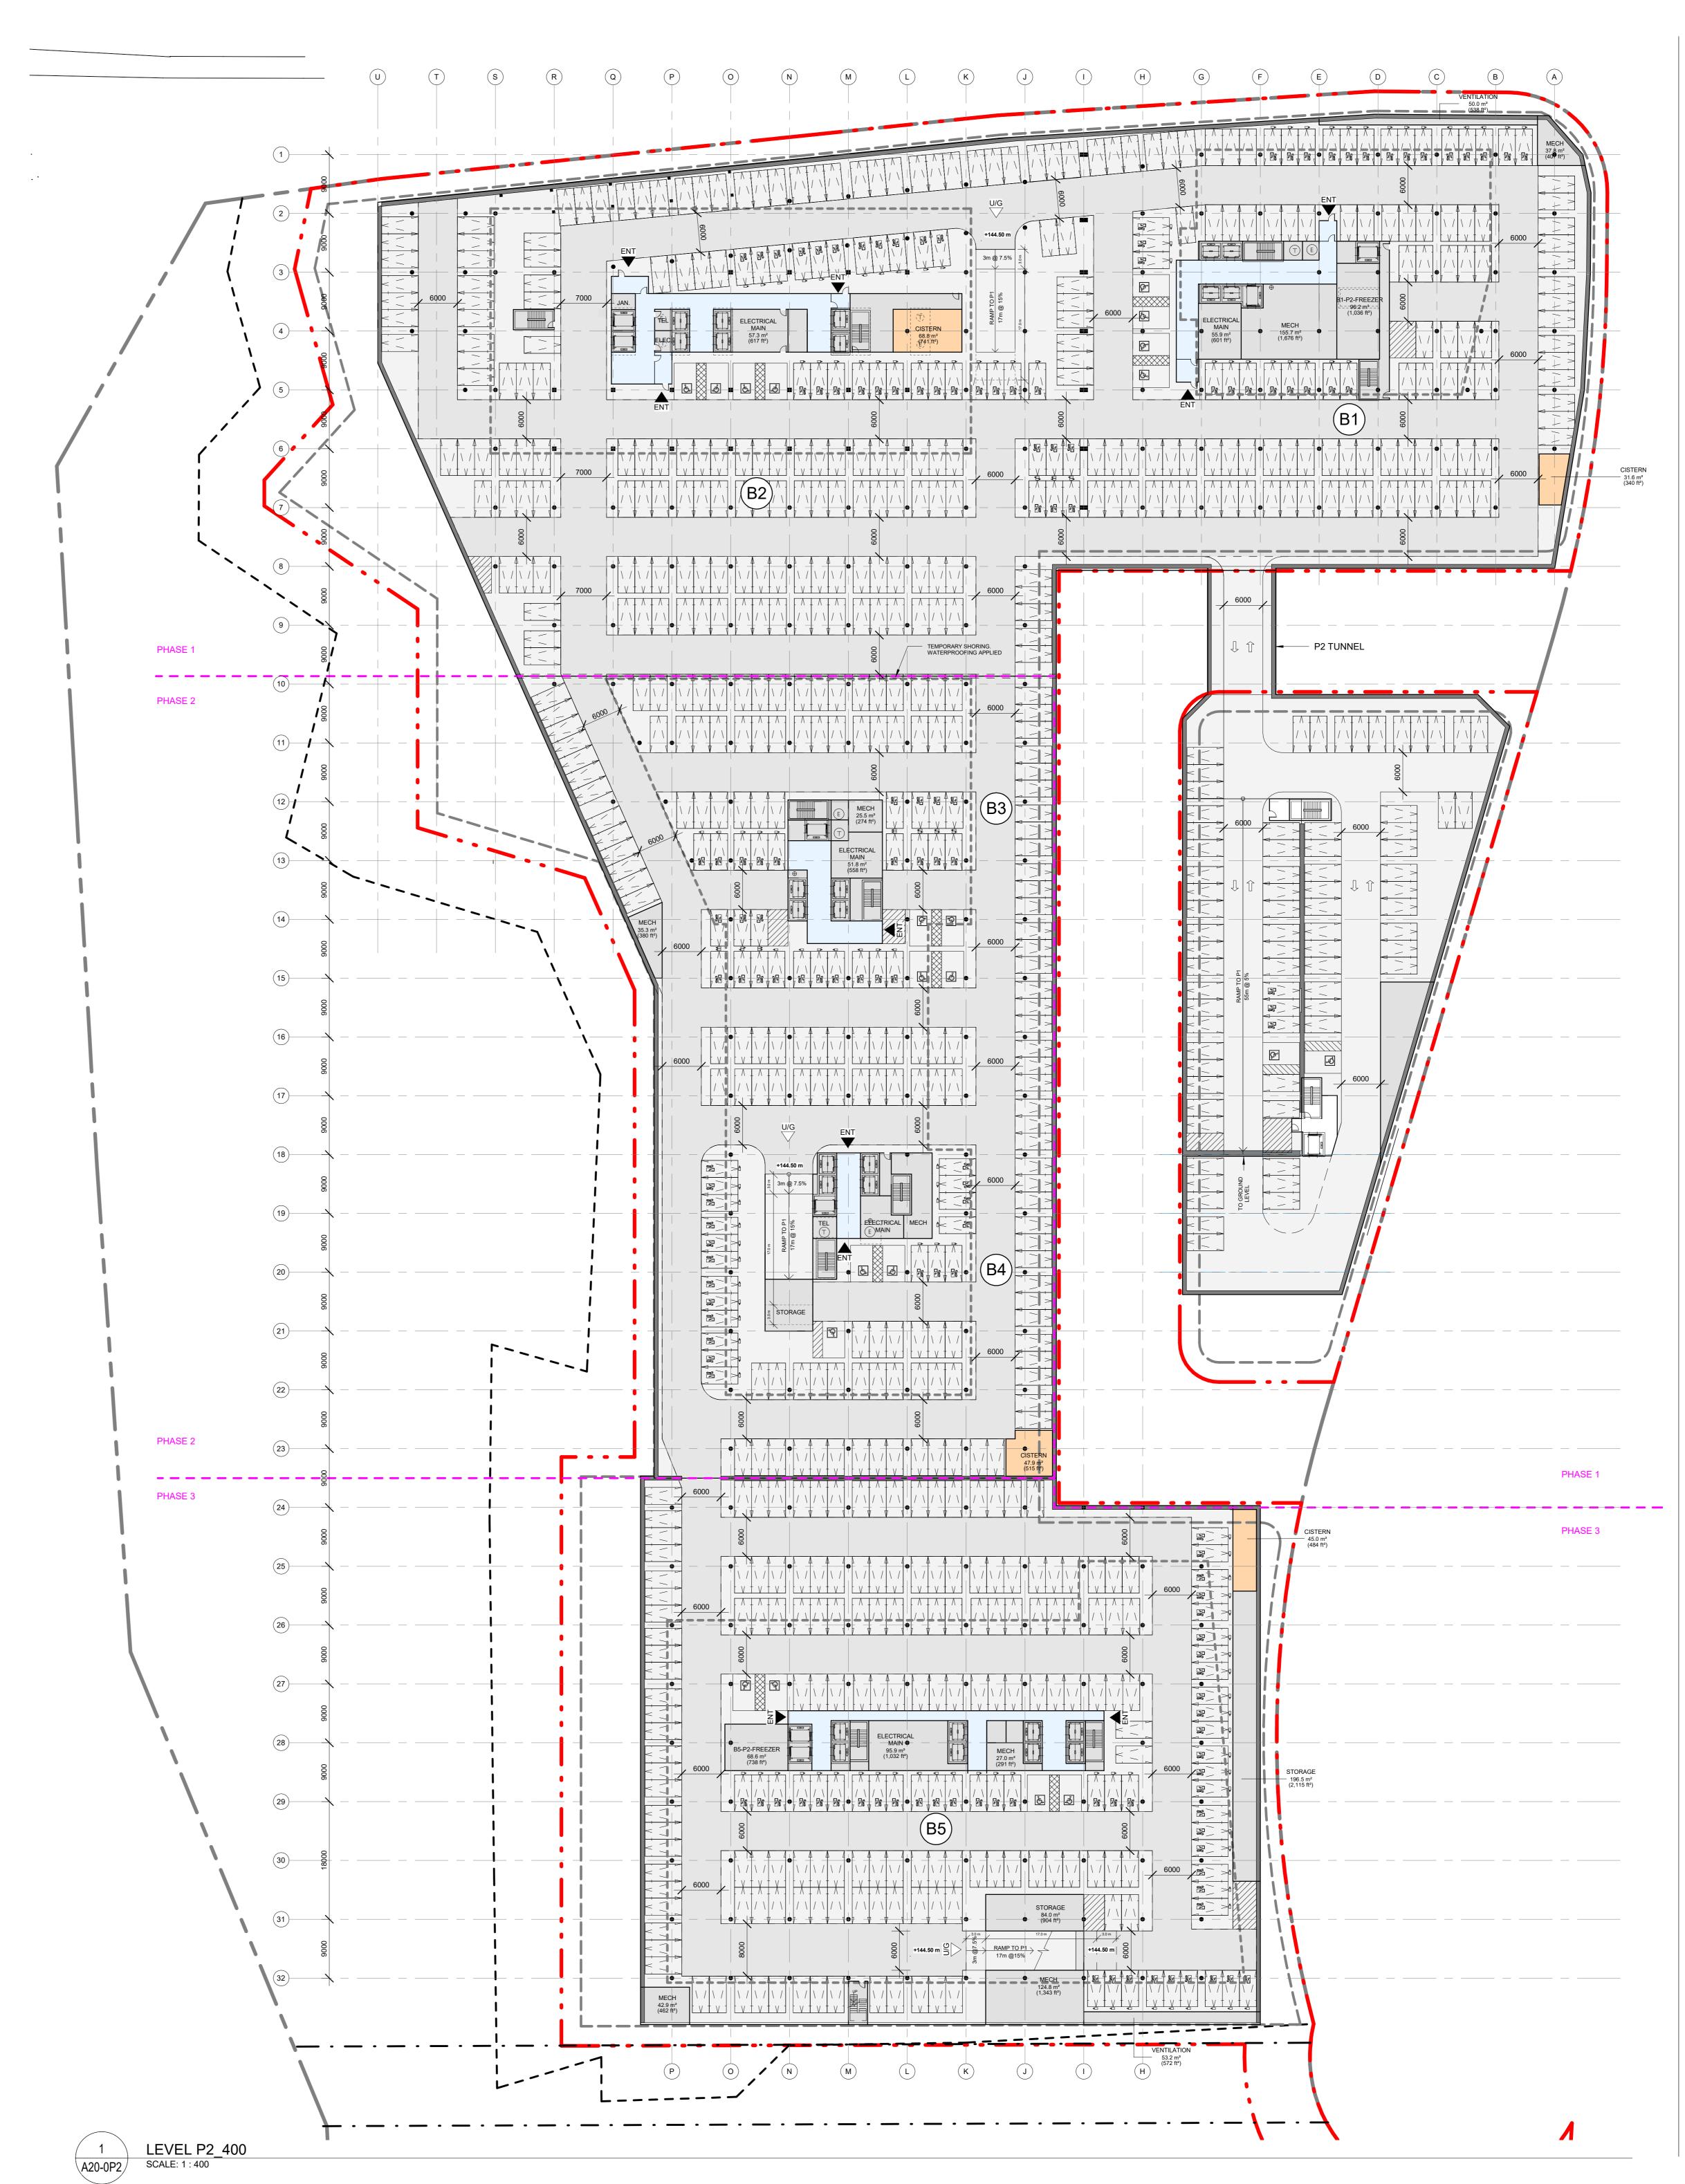
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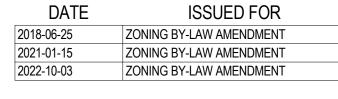
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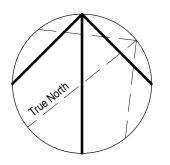
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ELEVATORS








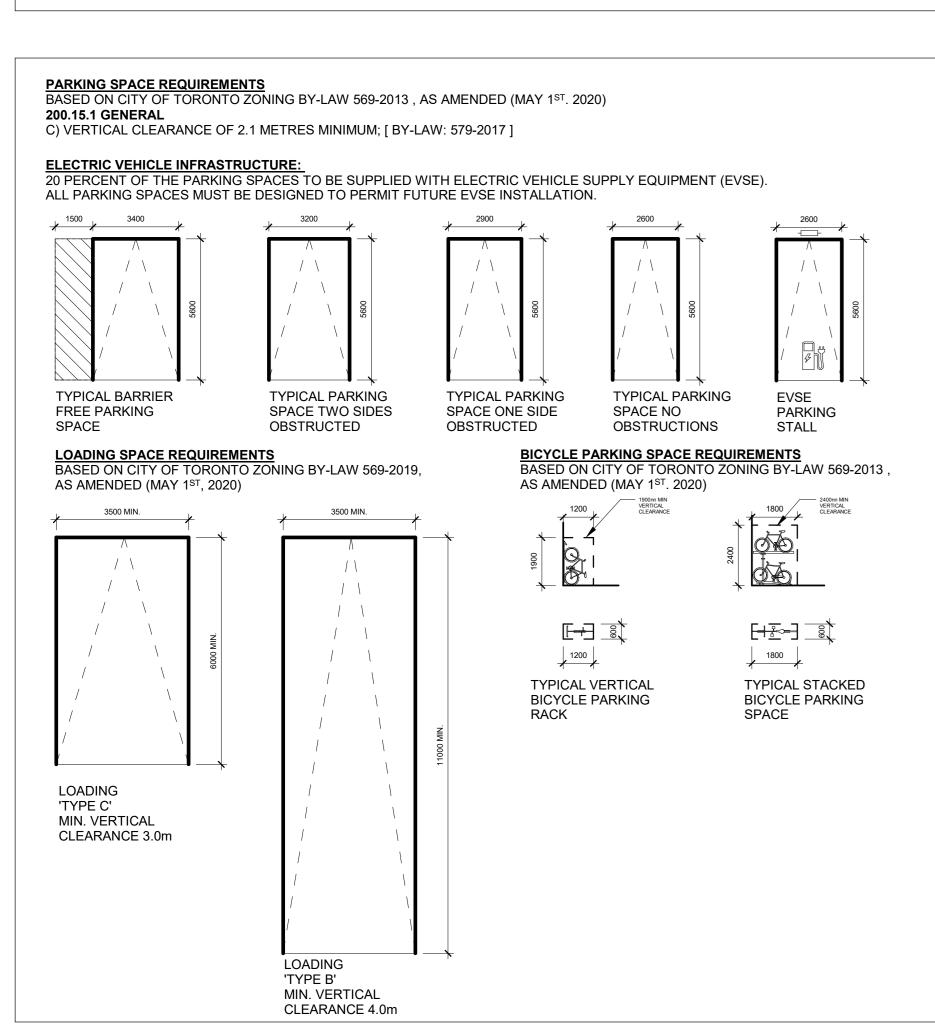

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Drawing Title


LEVEL P2

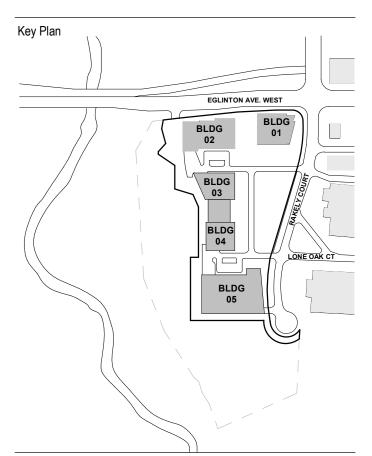As indicated

Project No.

ONBL 18-0225

A20-0P2

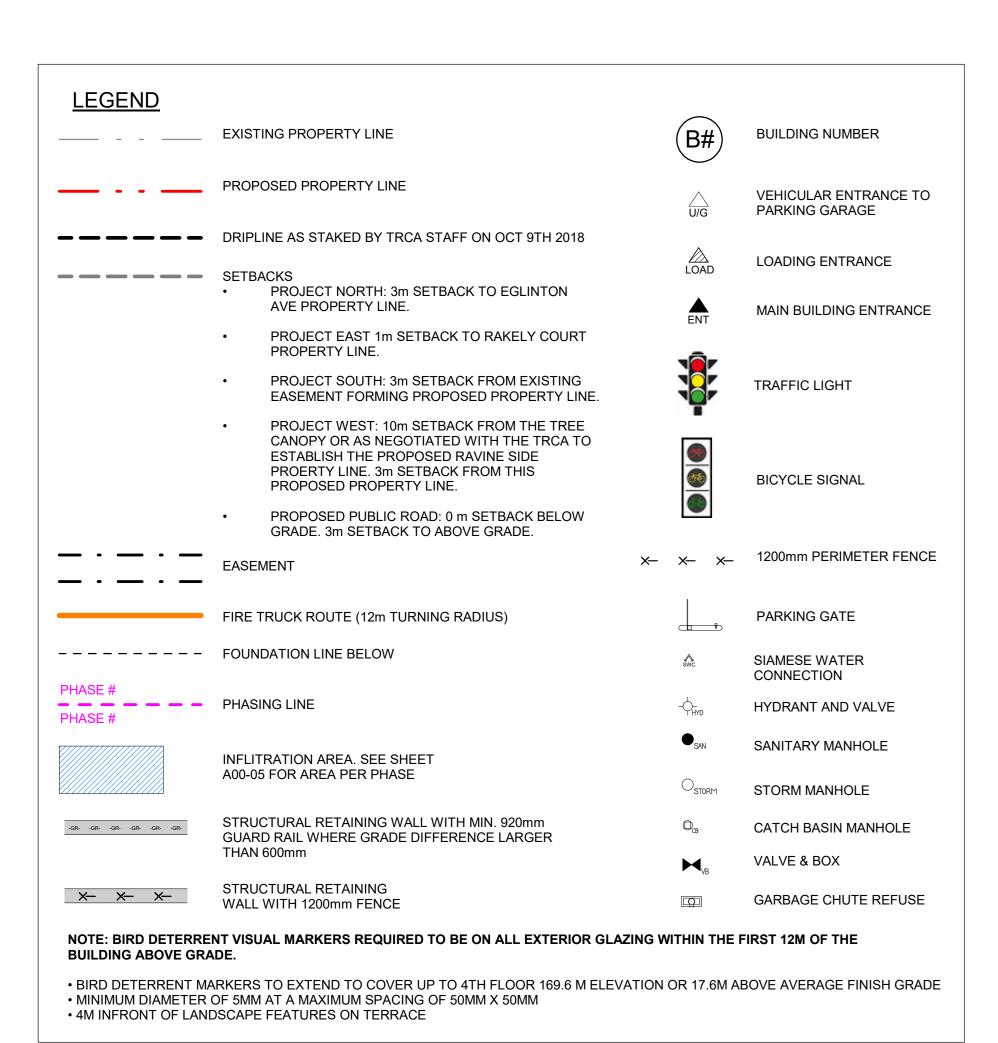

OFFICE CIRCULATION

RETAIL

ELEVATORS

 $\overset{--}{-}$  CIRCULATION


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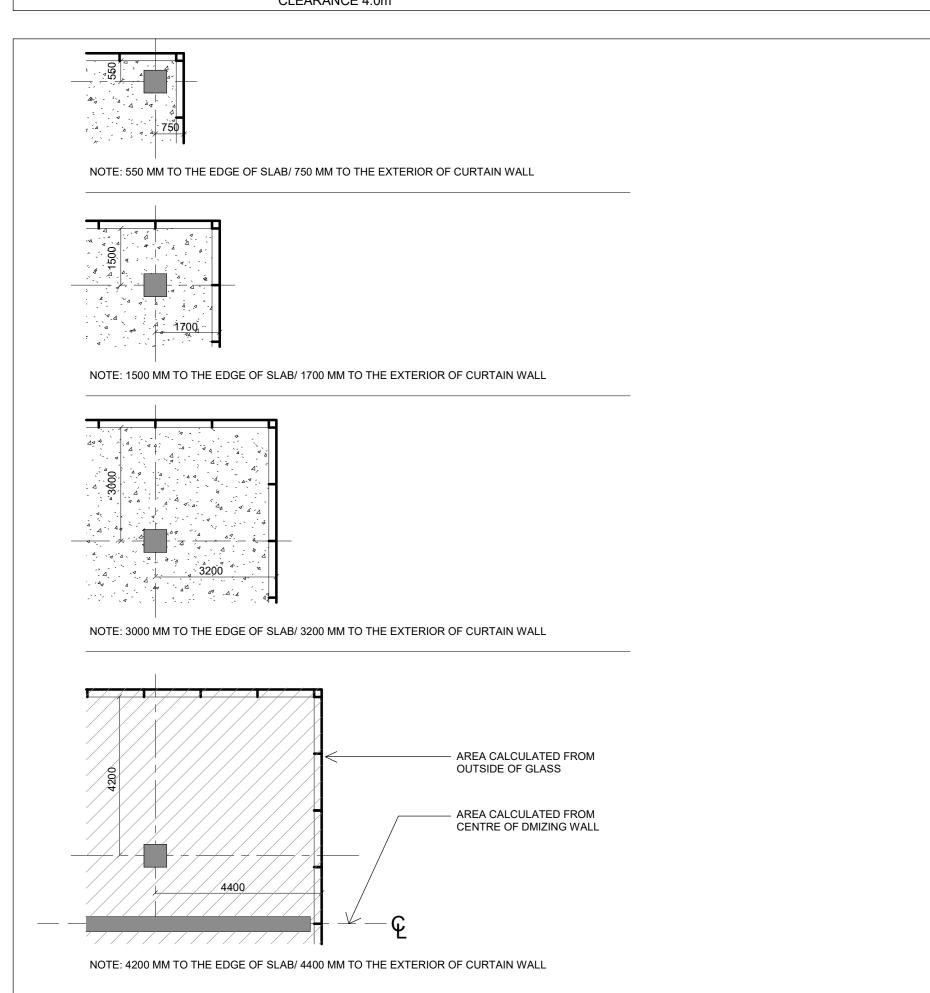
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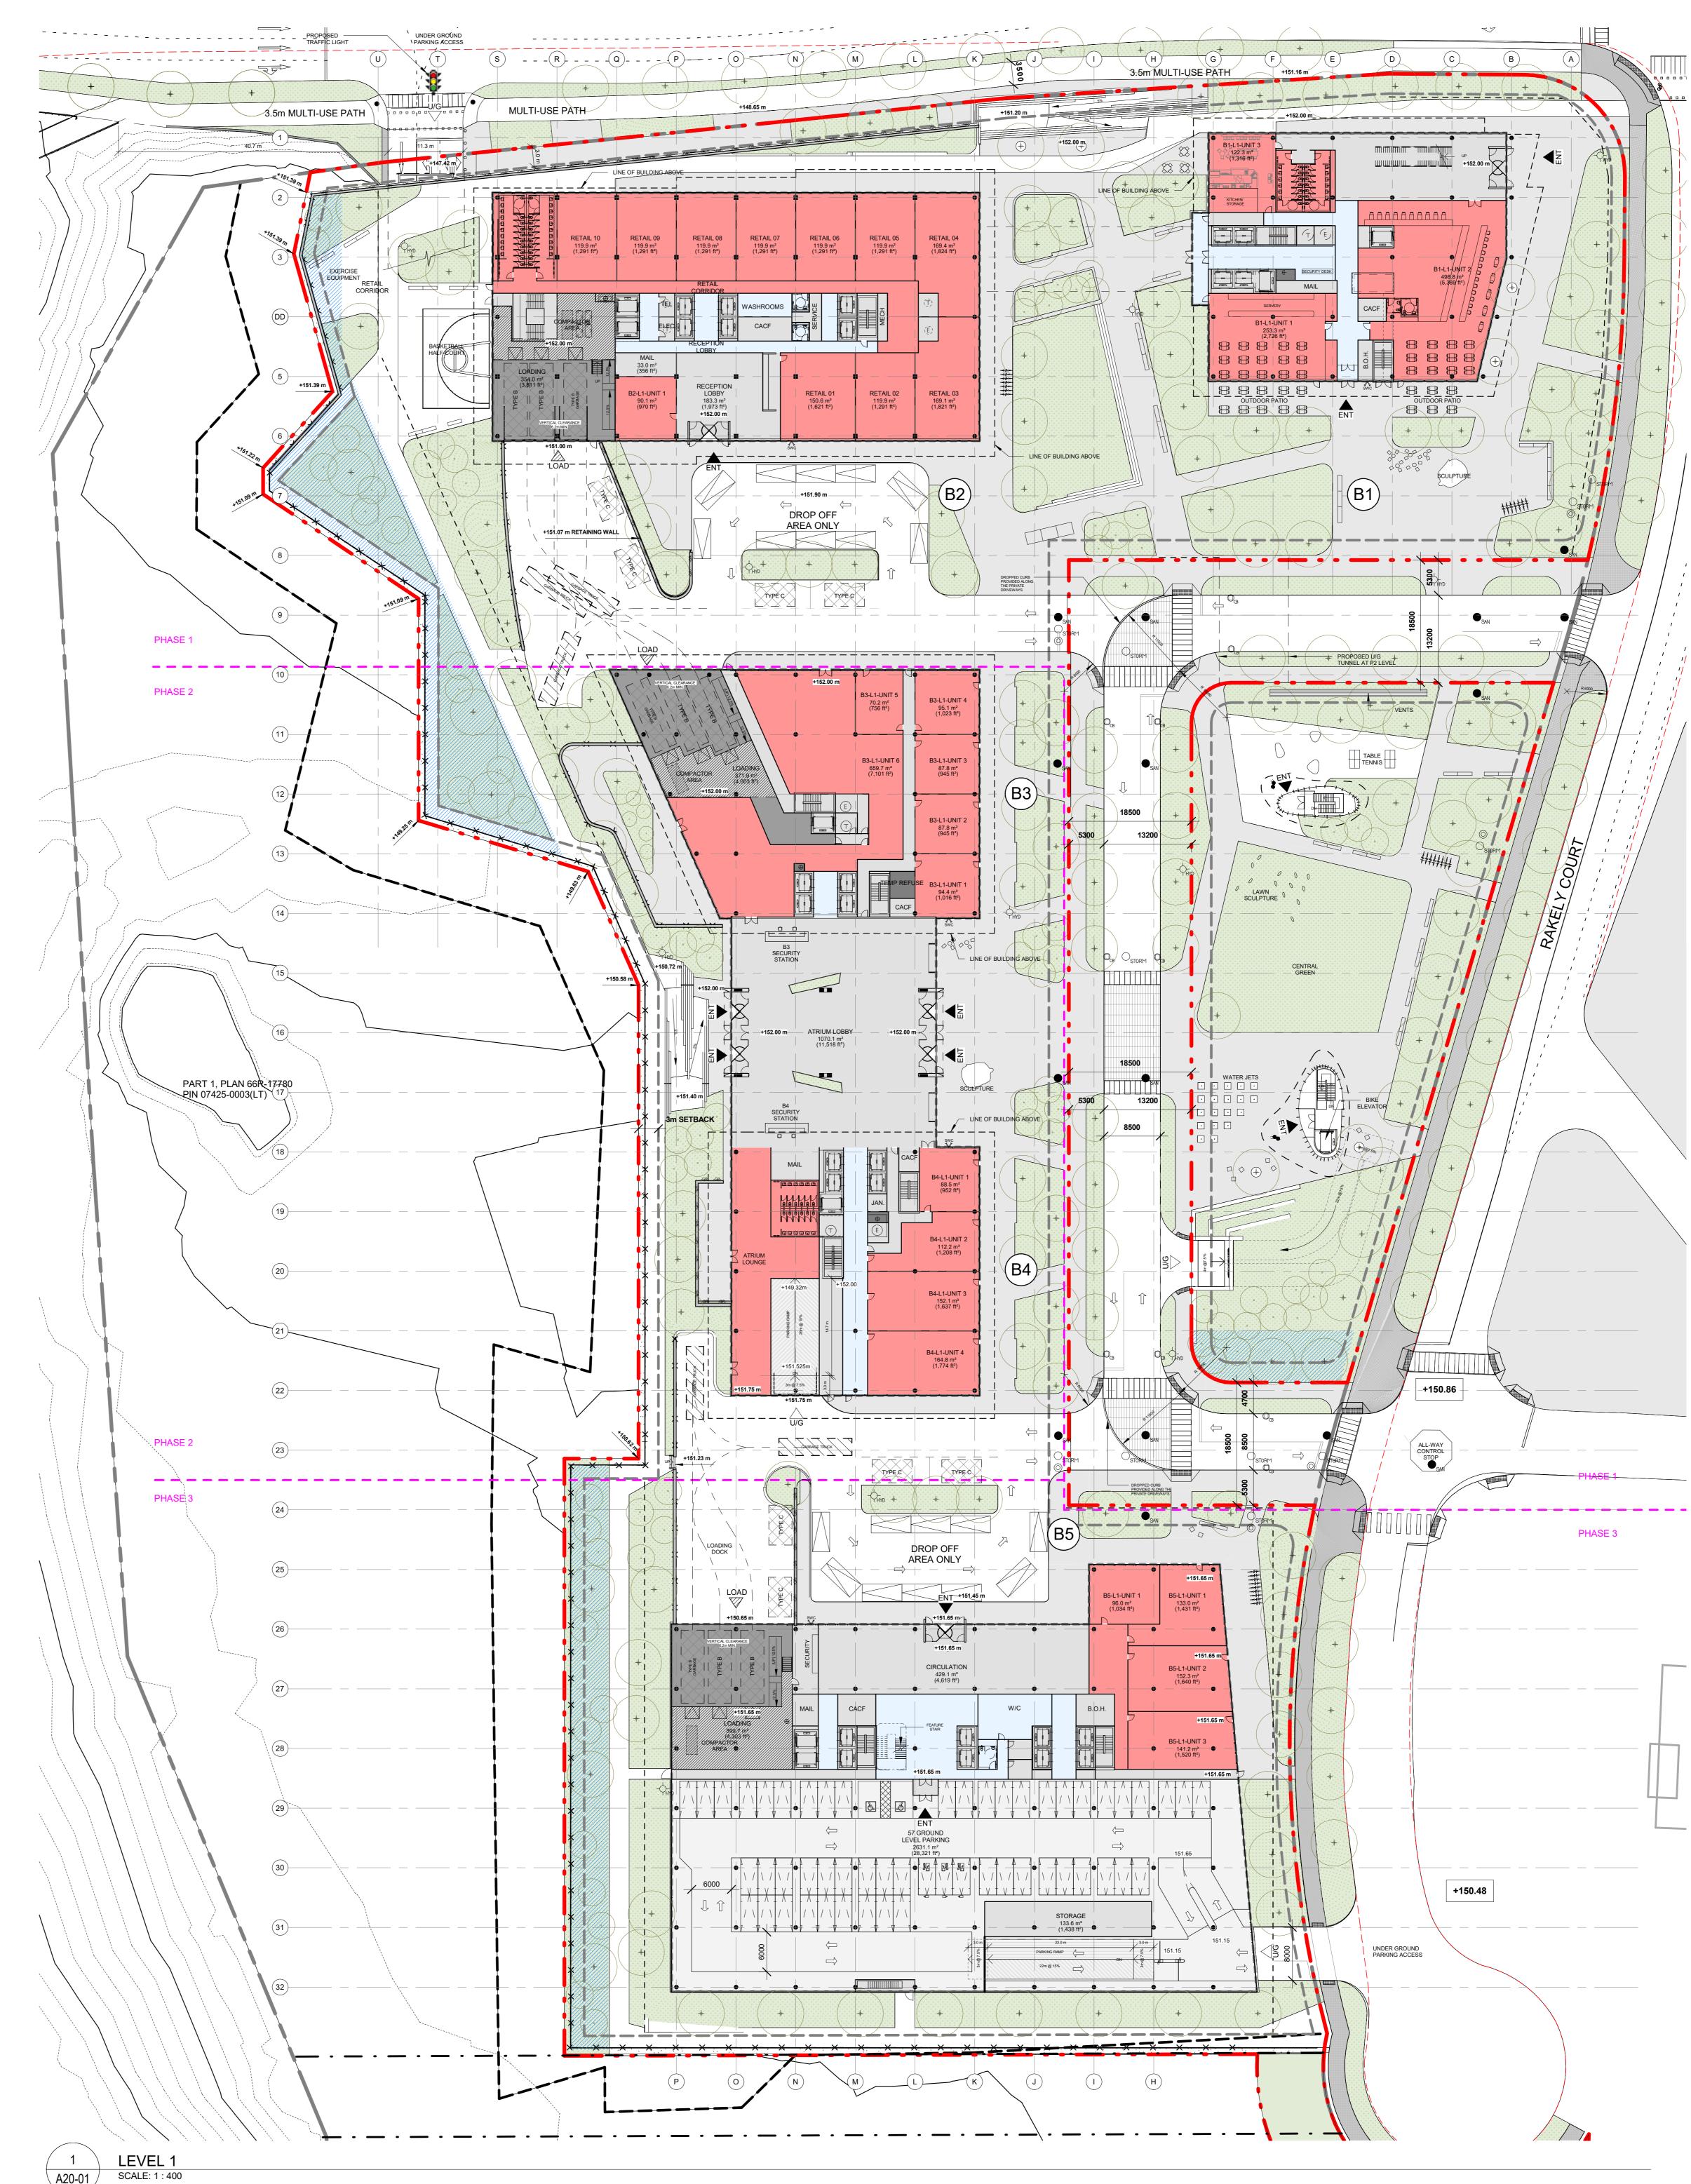
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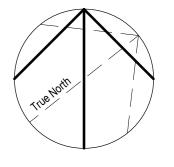
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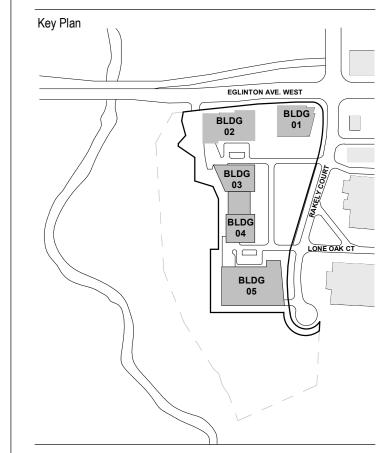




ZONING BY-LAW AMENDMENT ZONING BY-LAW AMENDMENT 2021-01-15 ZONING BY-LAW AMENDMENT 2022-10-03



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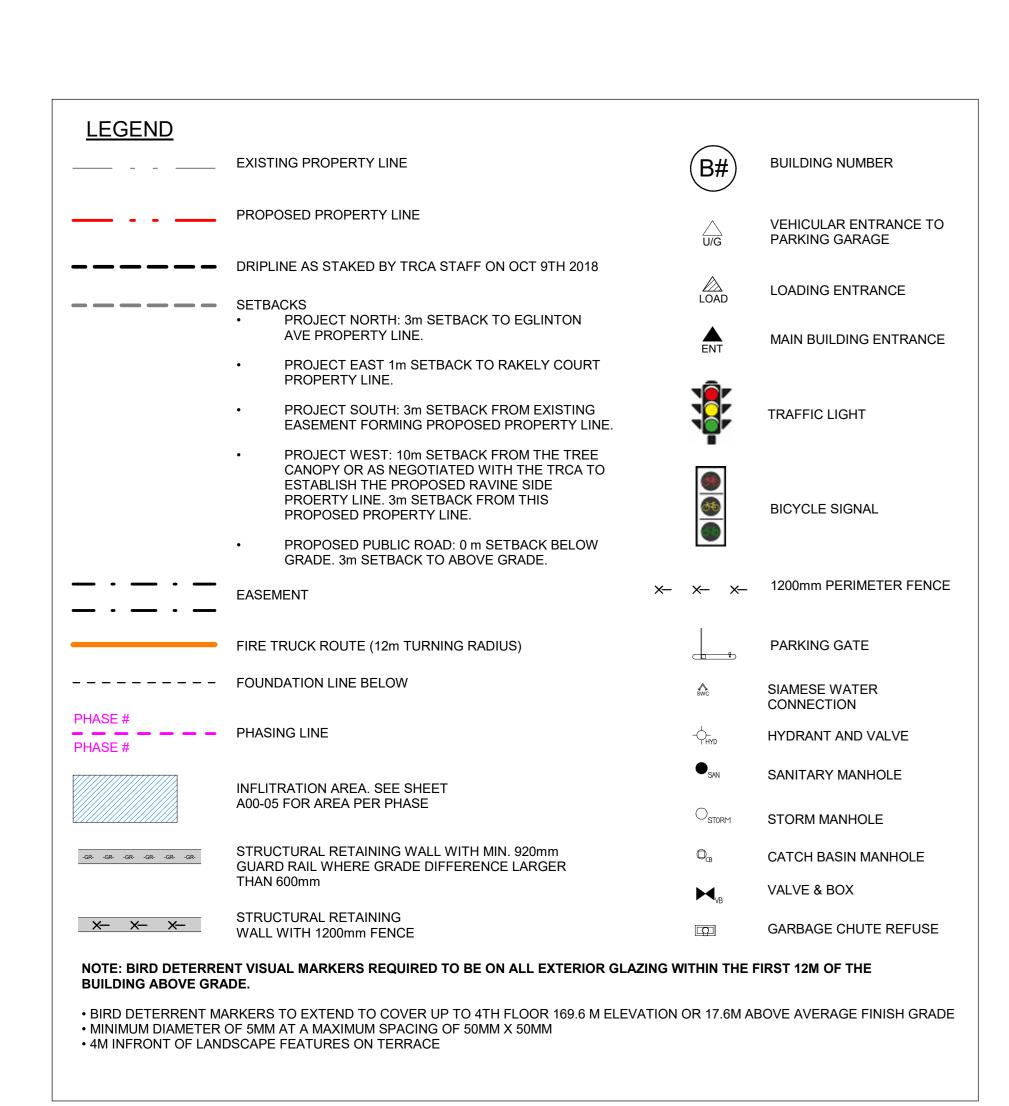
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Drawing Title LEVEL 1

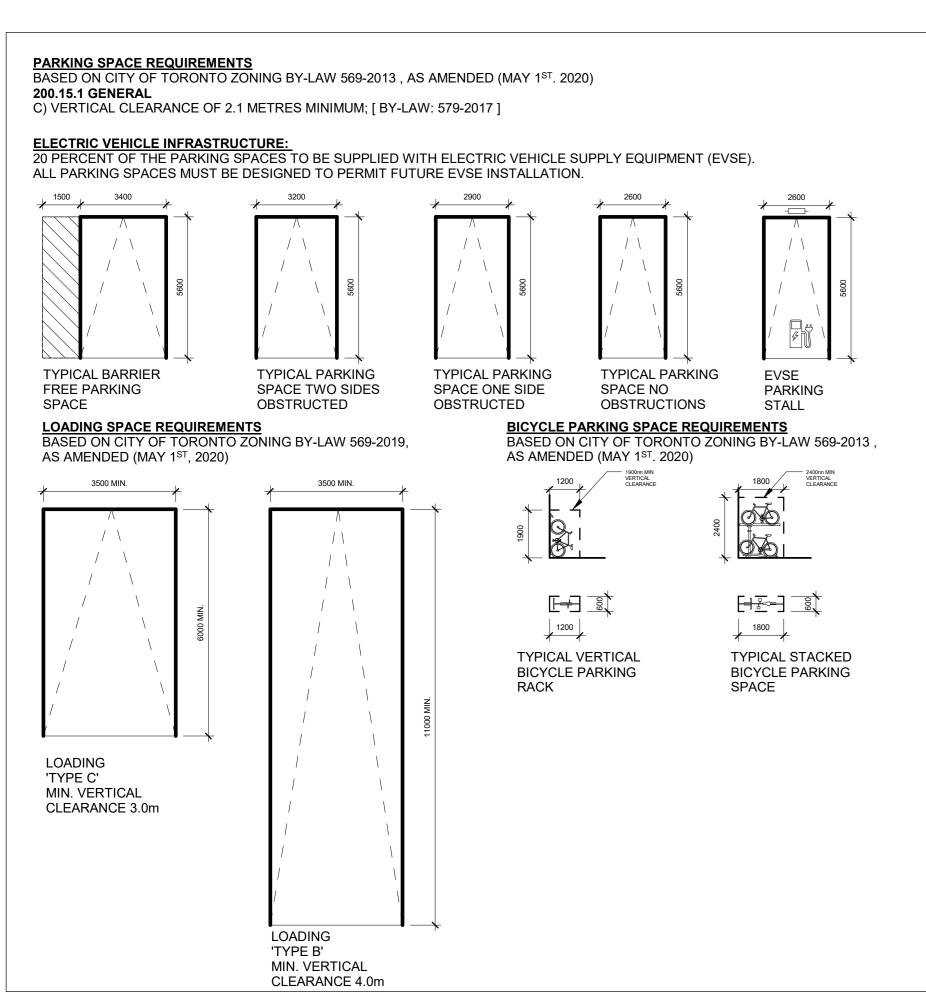As indicated Project No. ONBL 18-0225 Drawing No. A20-01



OFFICE

CIRCULATION

RETAIL


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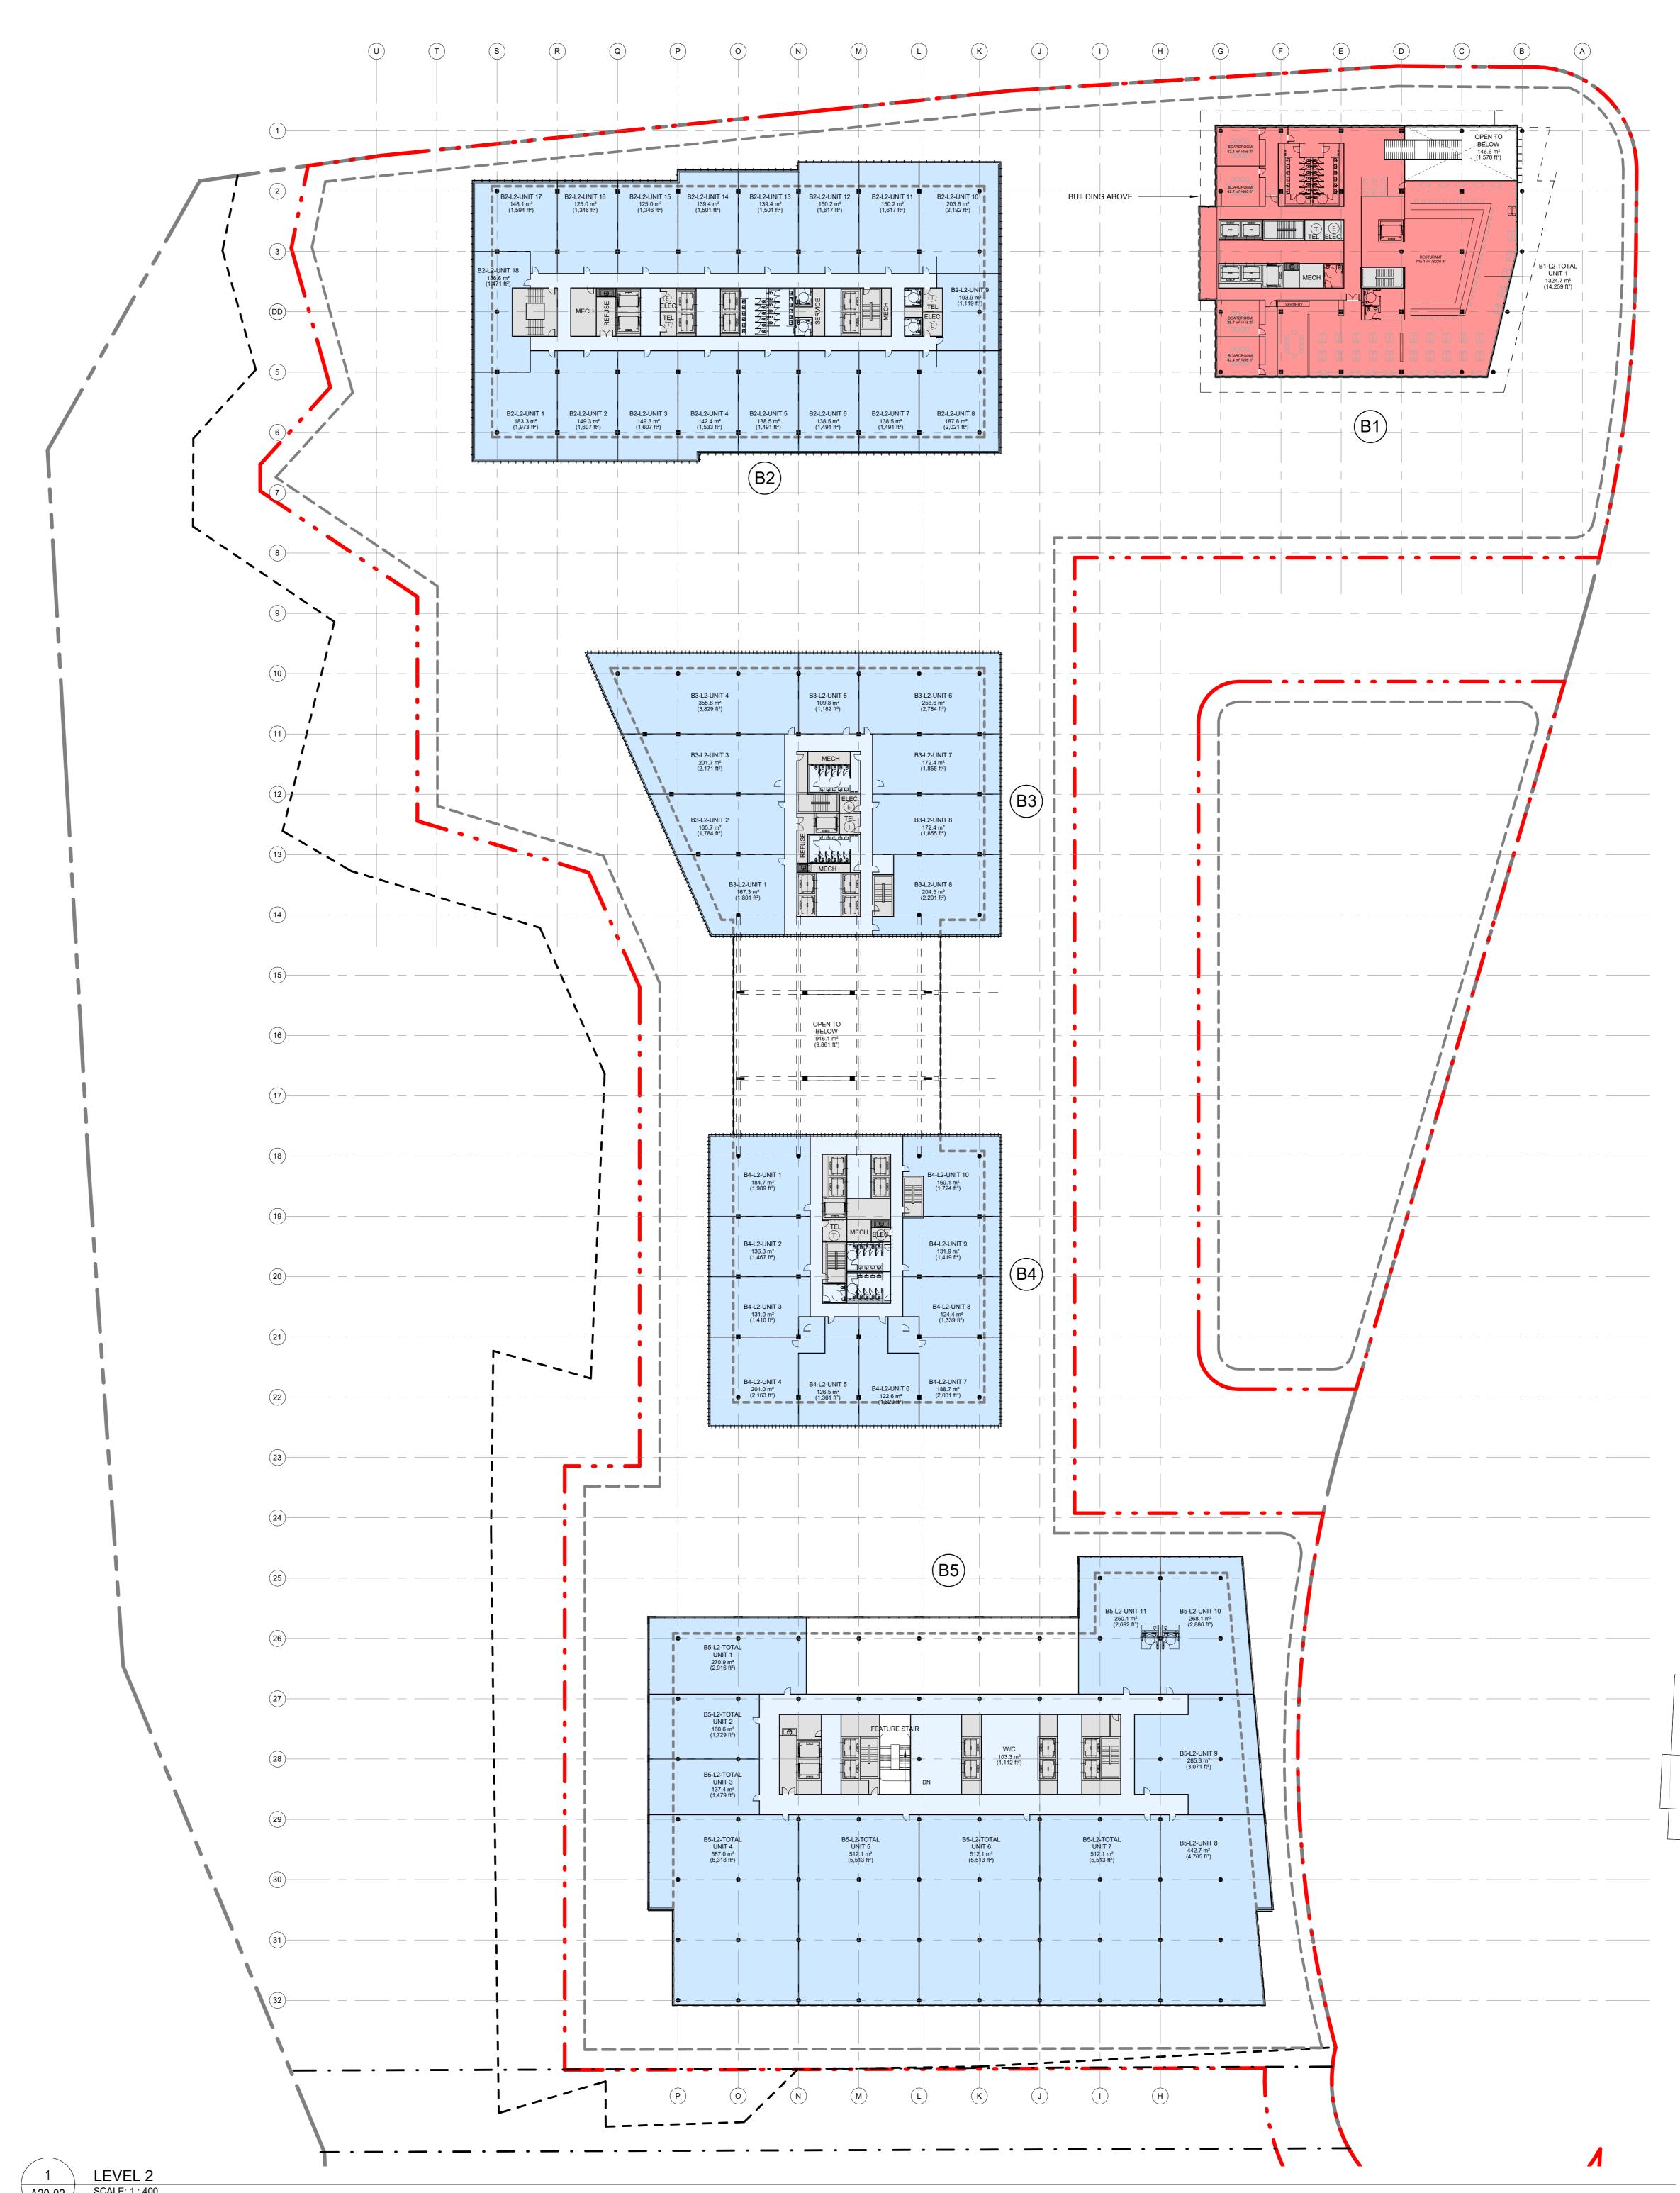
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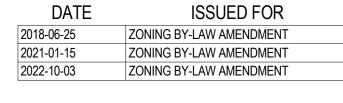
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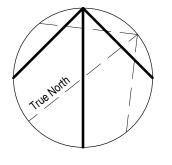
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WASHROOMS








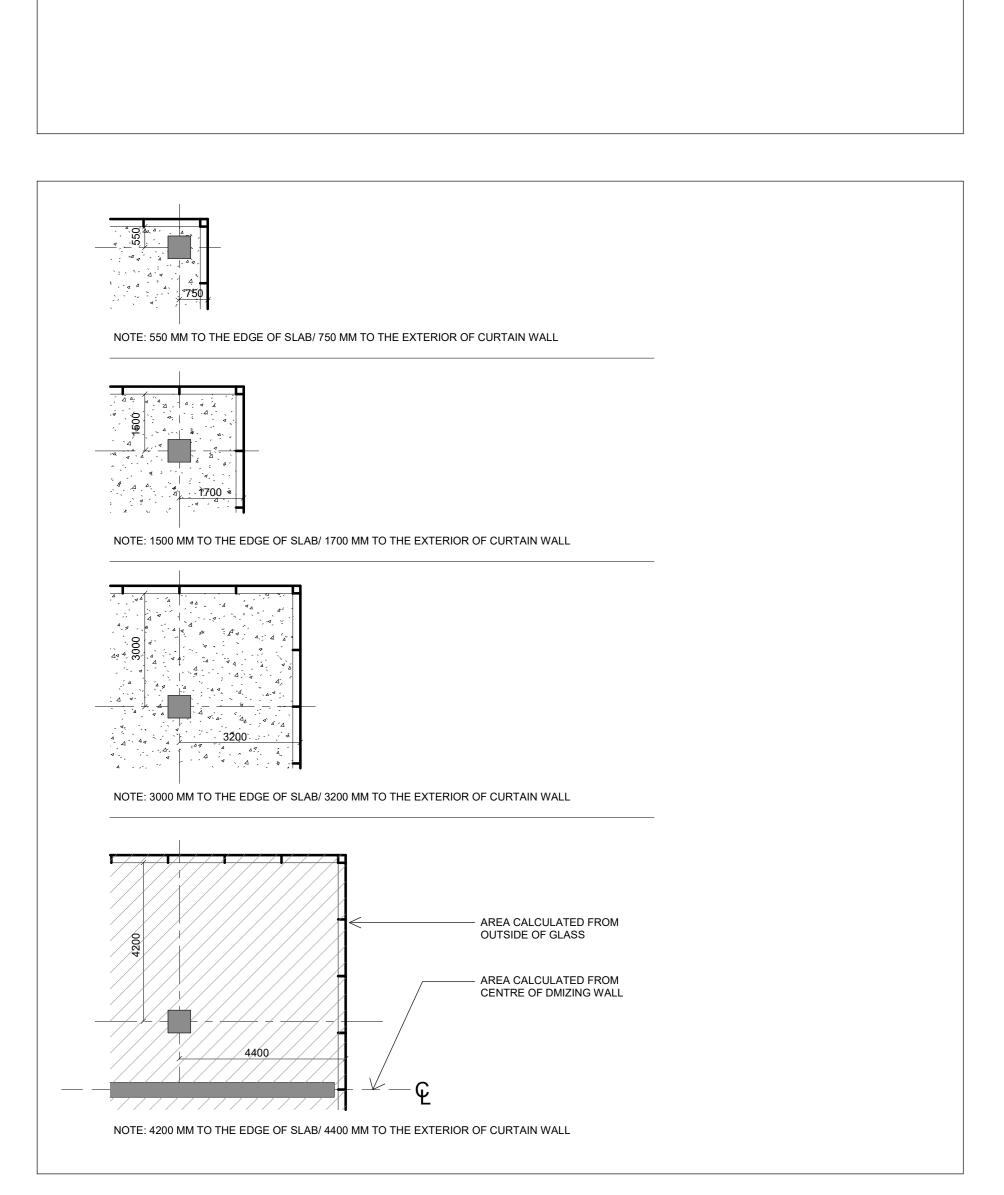

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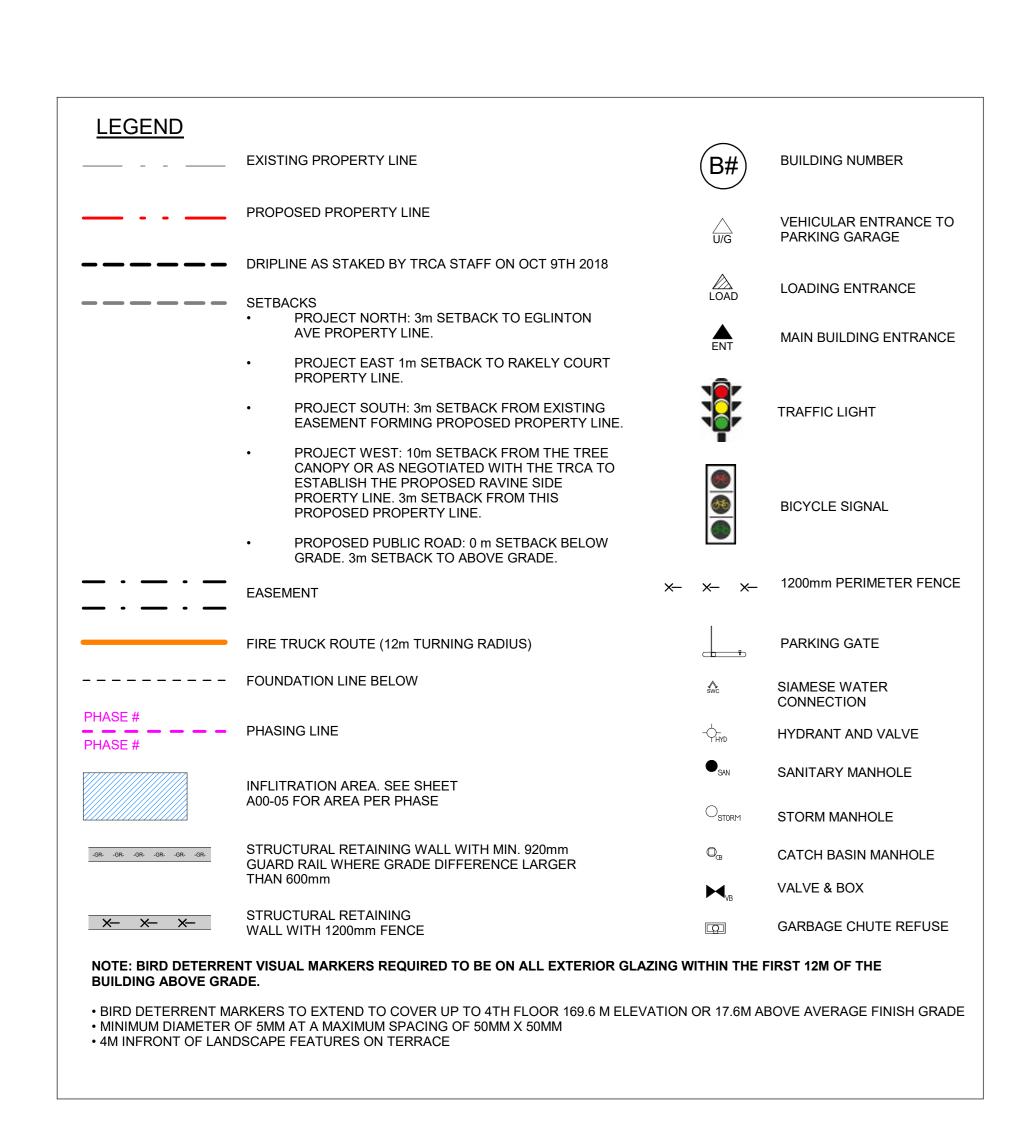
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Drawing Title LEVEL 2

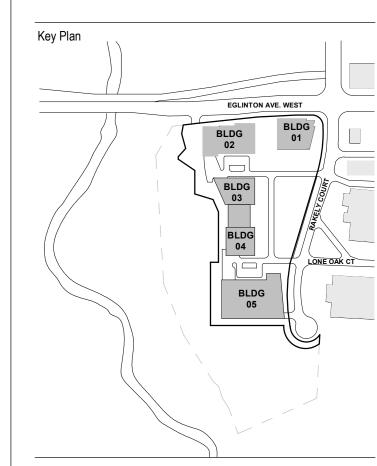1:400 Project No. ONBL 18-0225 Drawing No.





OFFICES

OFFICE CIRCULATION

ELEVATORS

STAIRS


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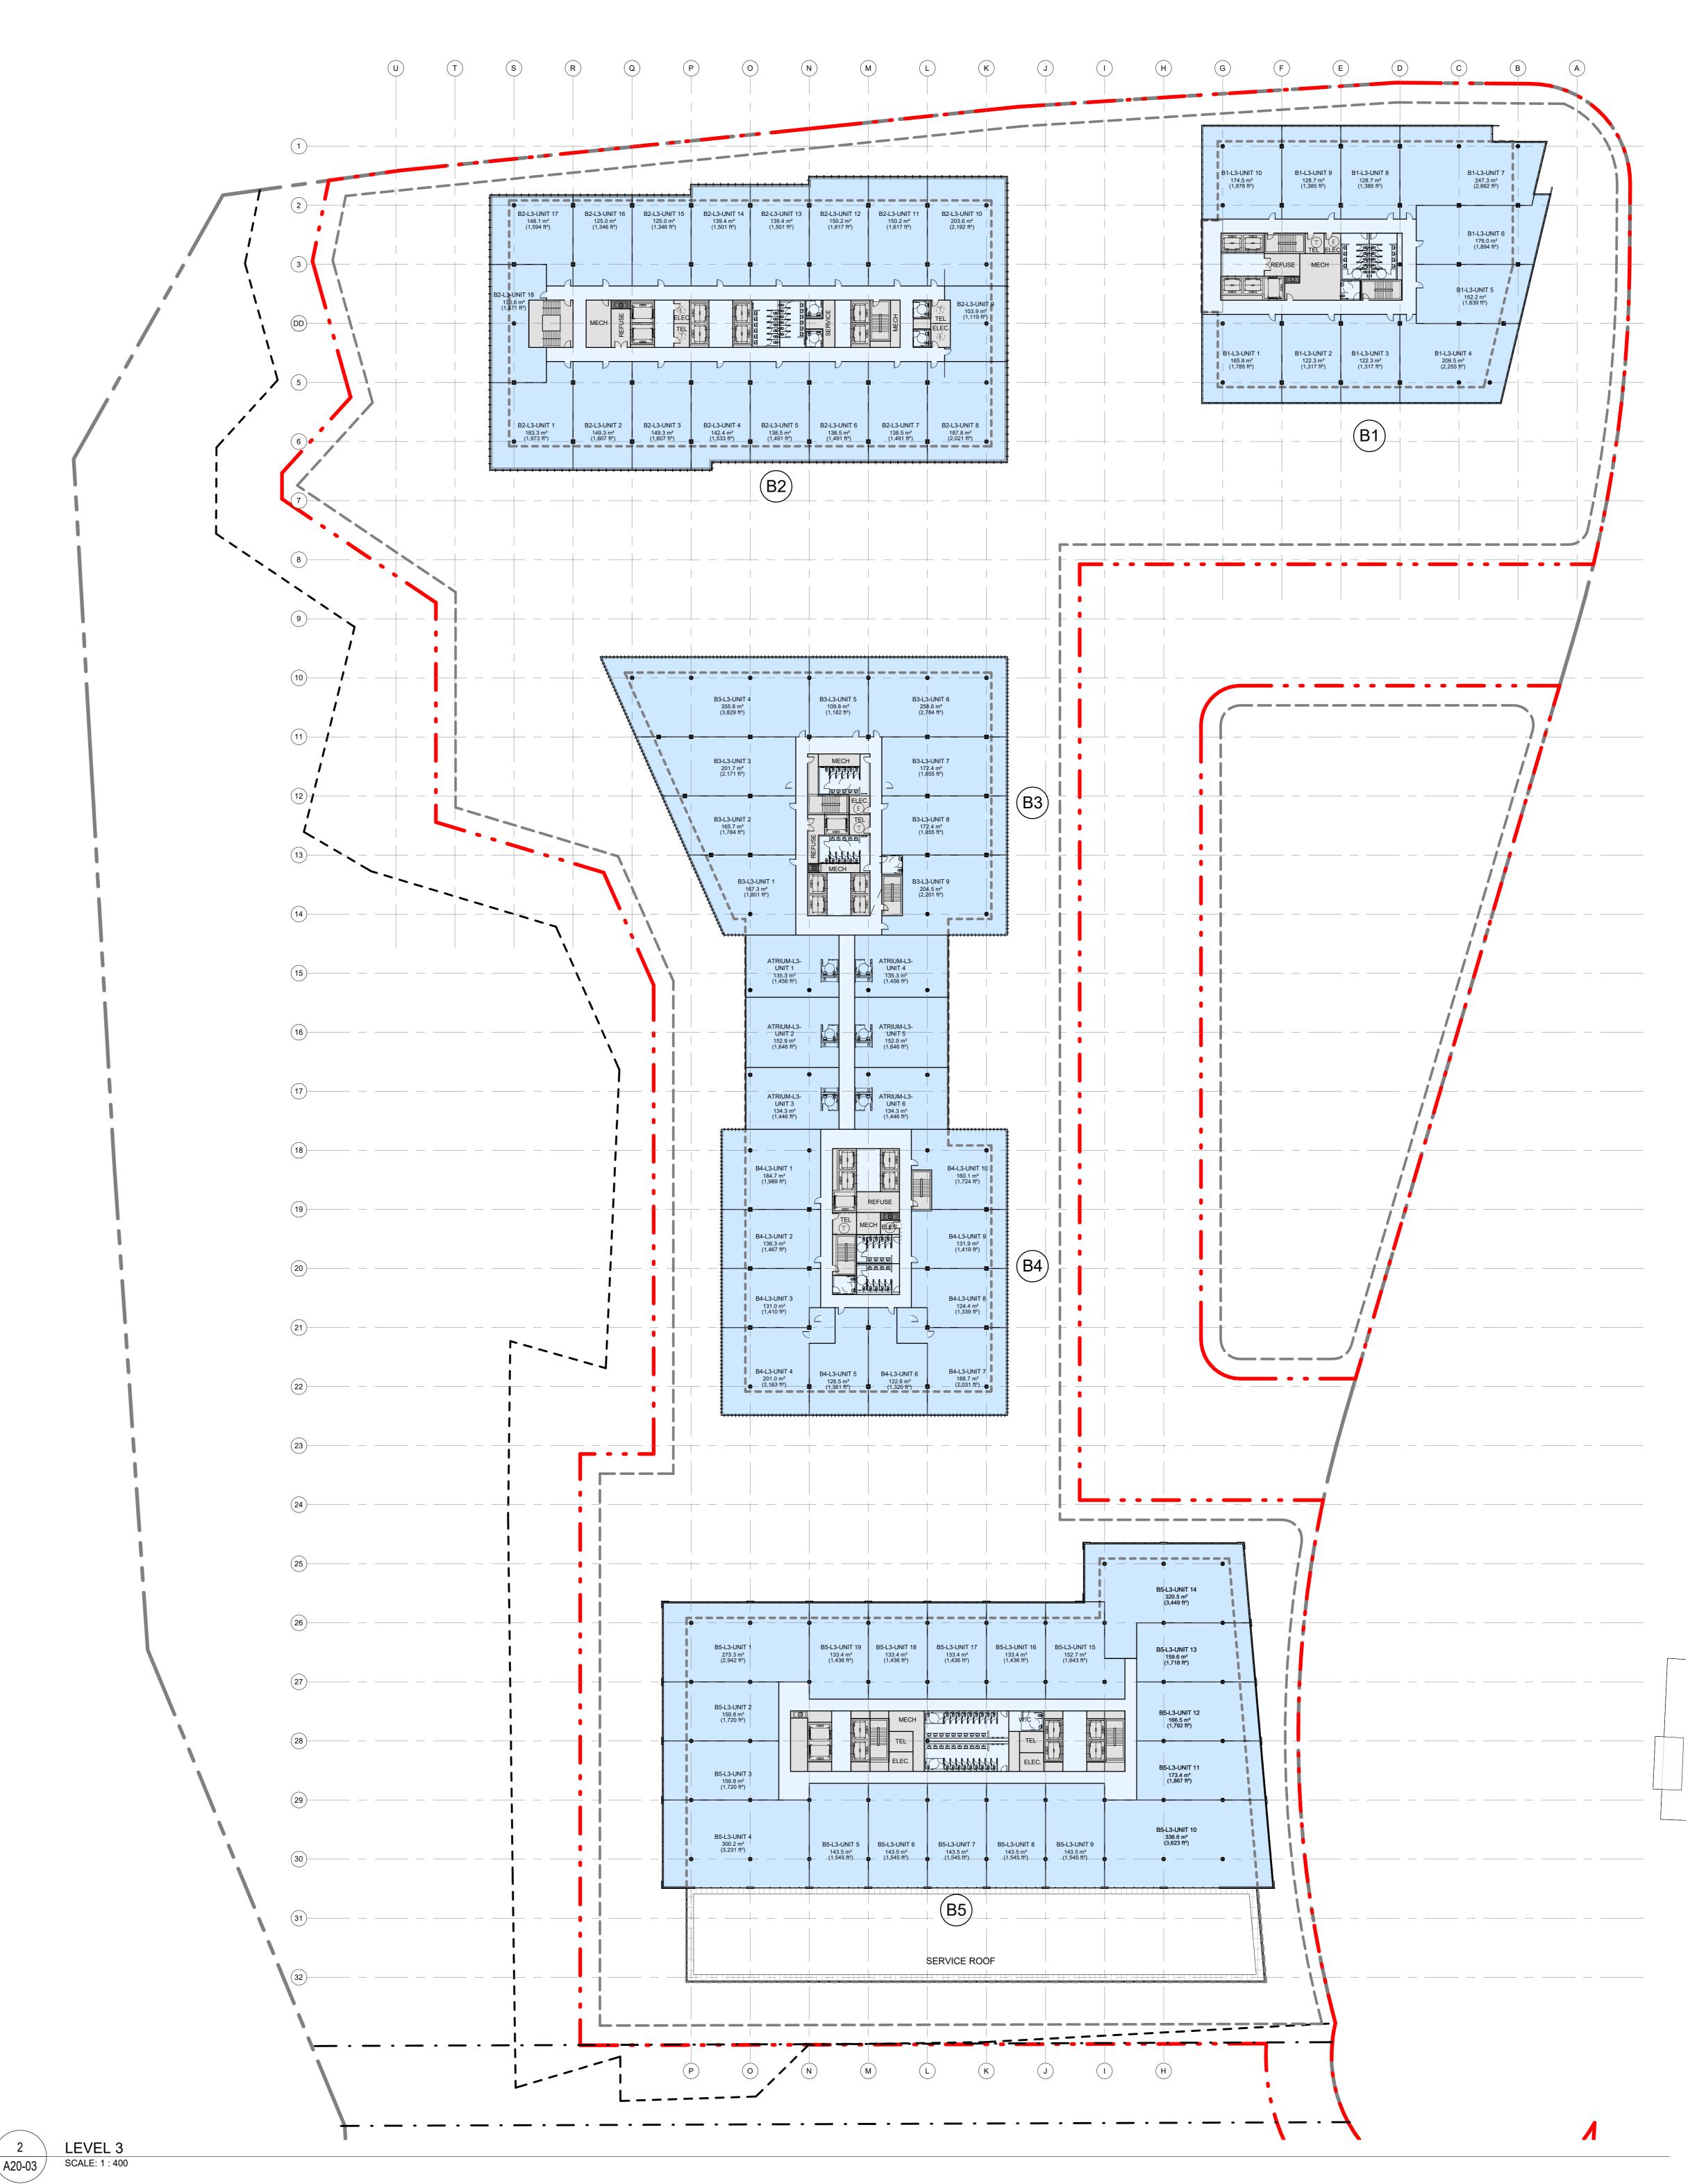
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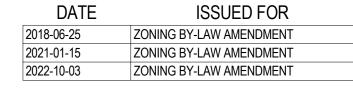
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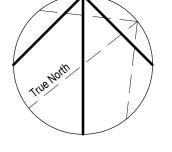
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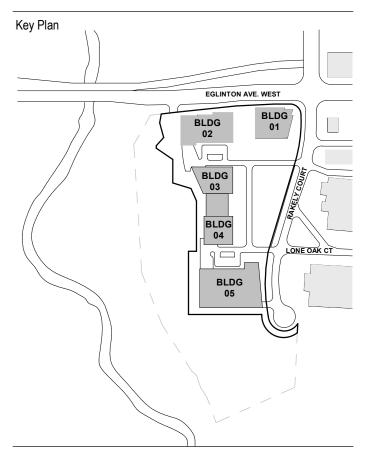






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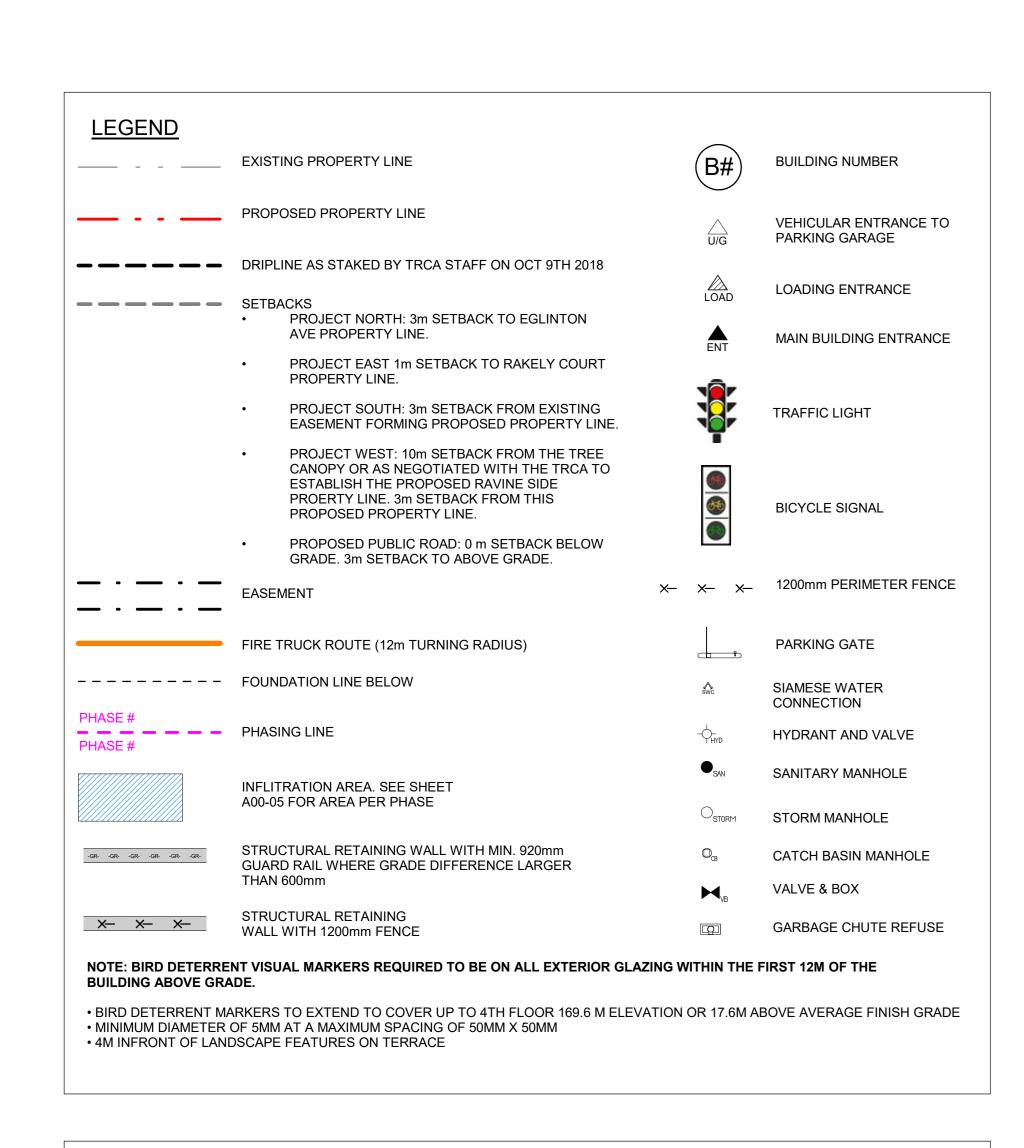
Drawing Title

LEVEL 3

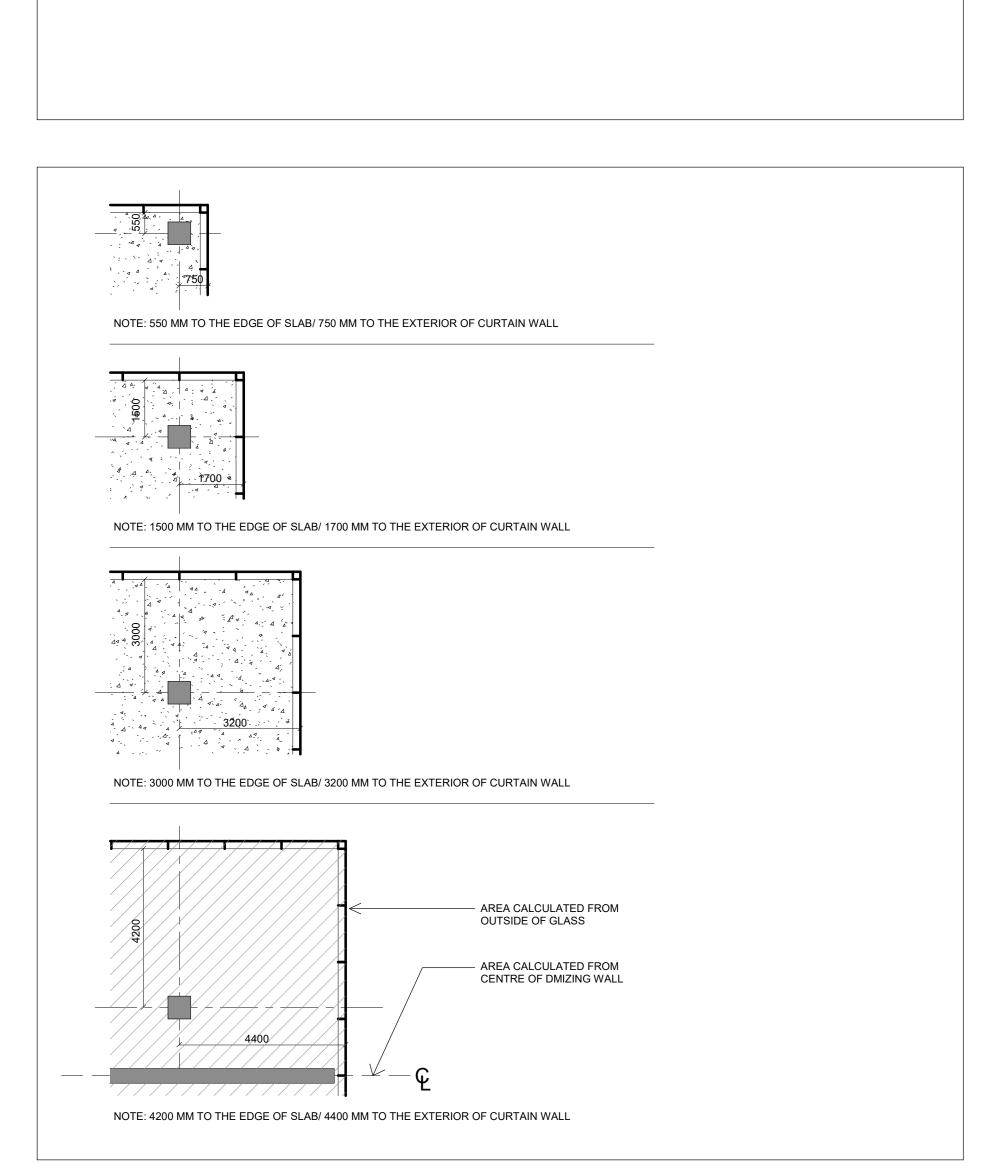1 : 400

Project No.

ONBL 18-0225



OFFICES

OFFICE CIRCULATION

RETAIL

ELEVATORS


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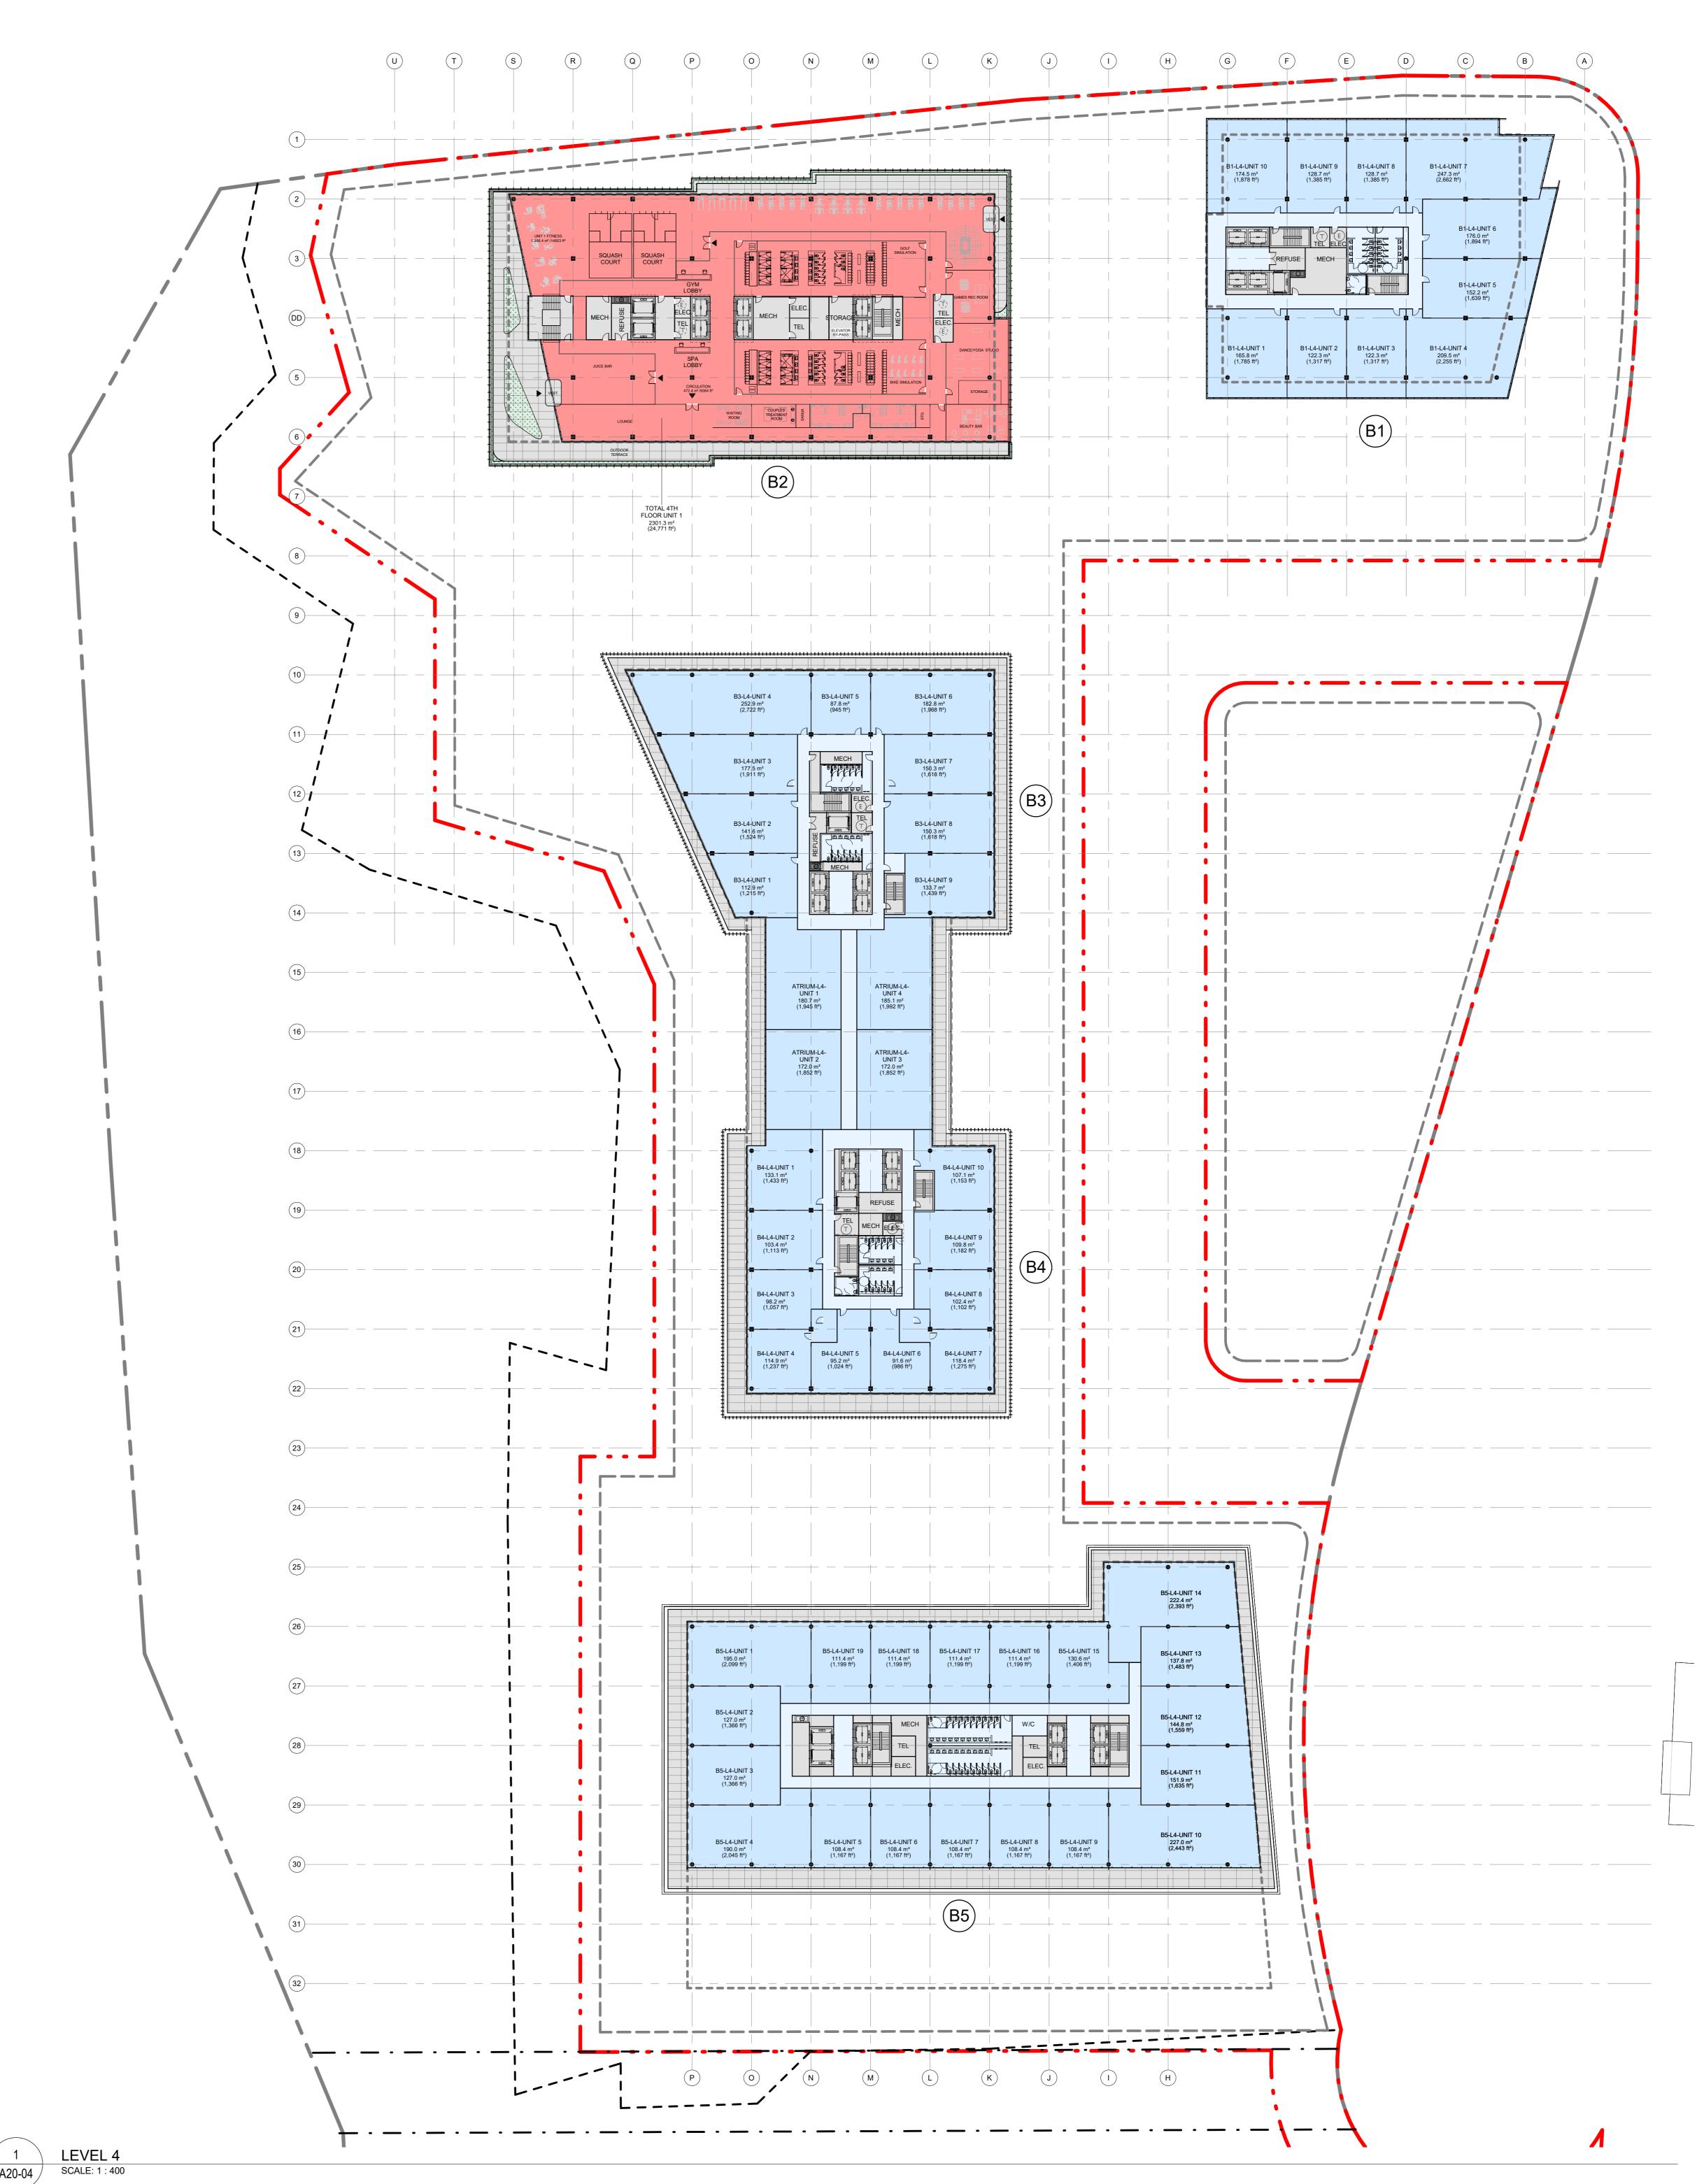
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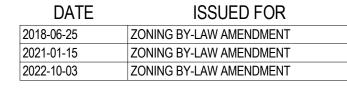
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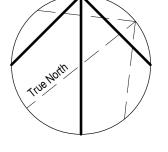
STORAGE

WASHROOMS








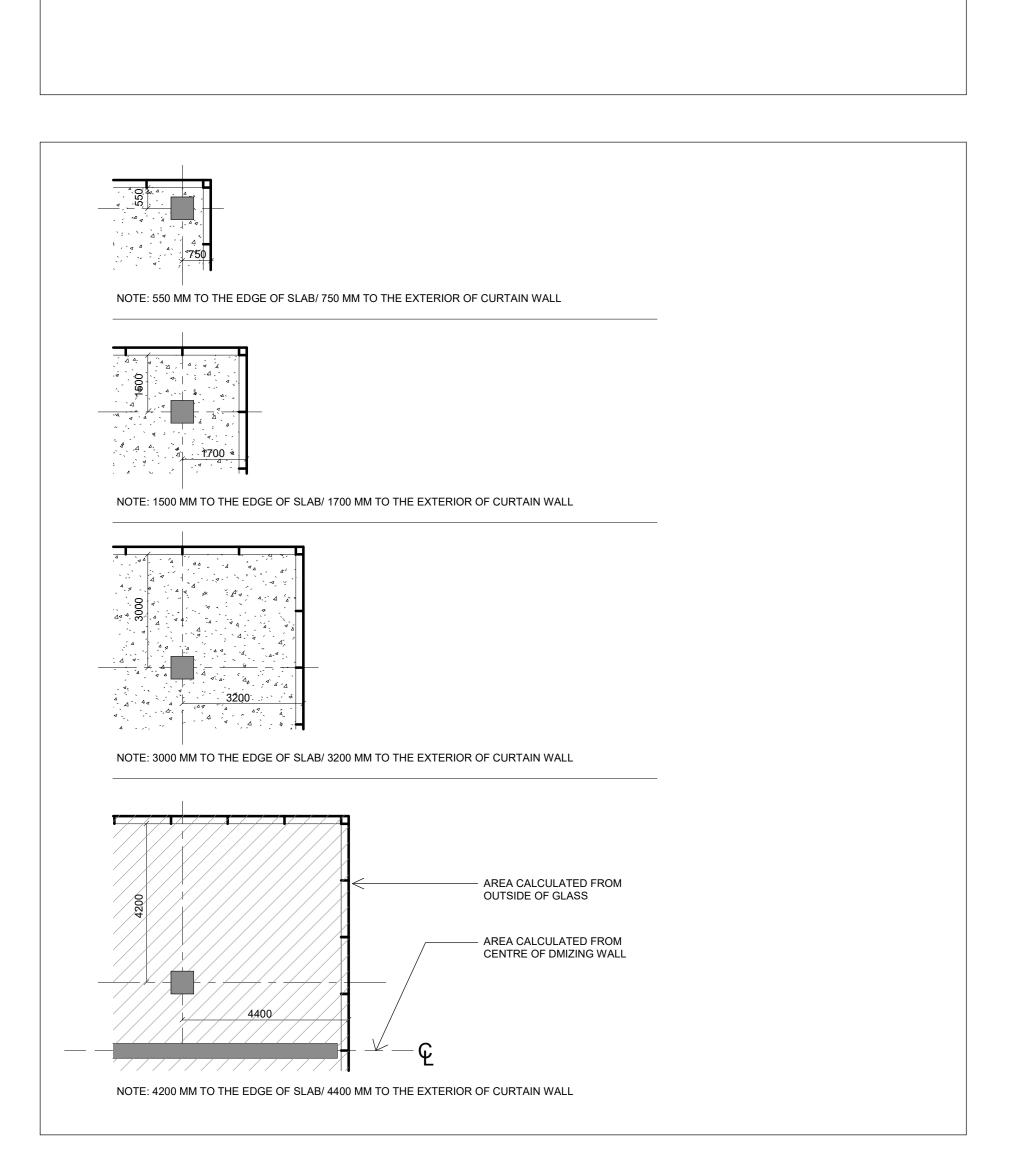

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Drawing Title


LEVEL 4
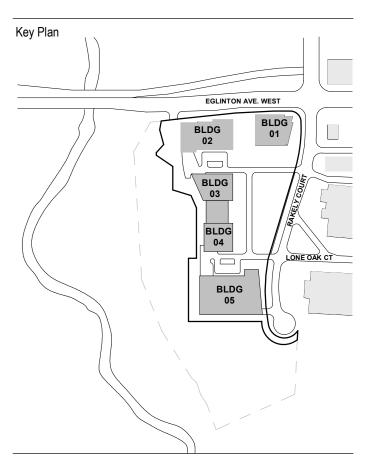
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1:400

Dject No.

ONBL 18-0225

awing No.

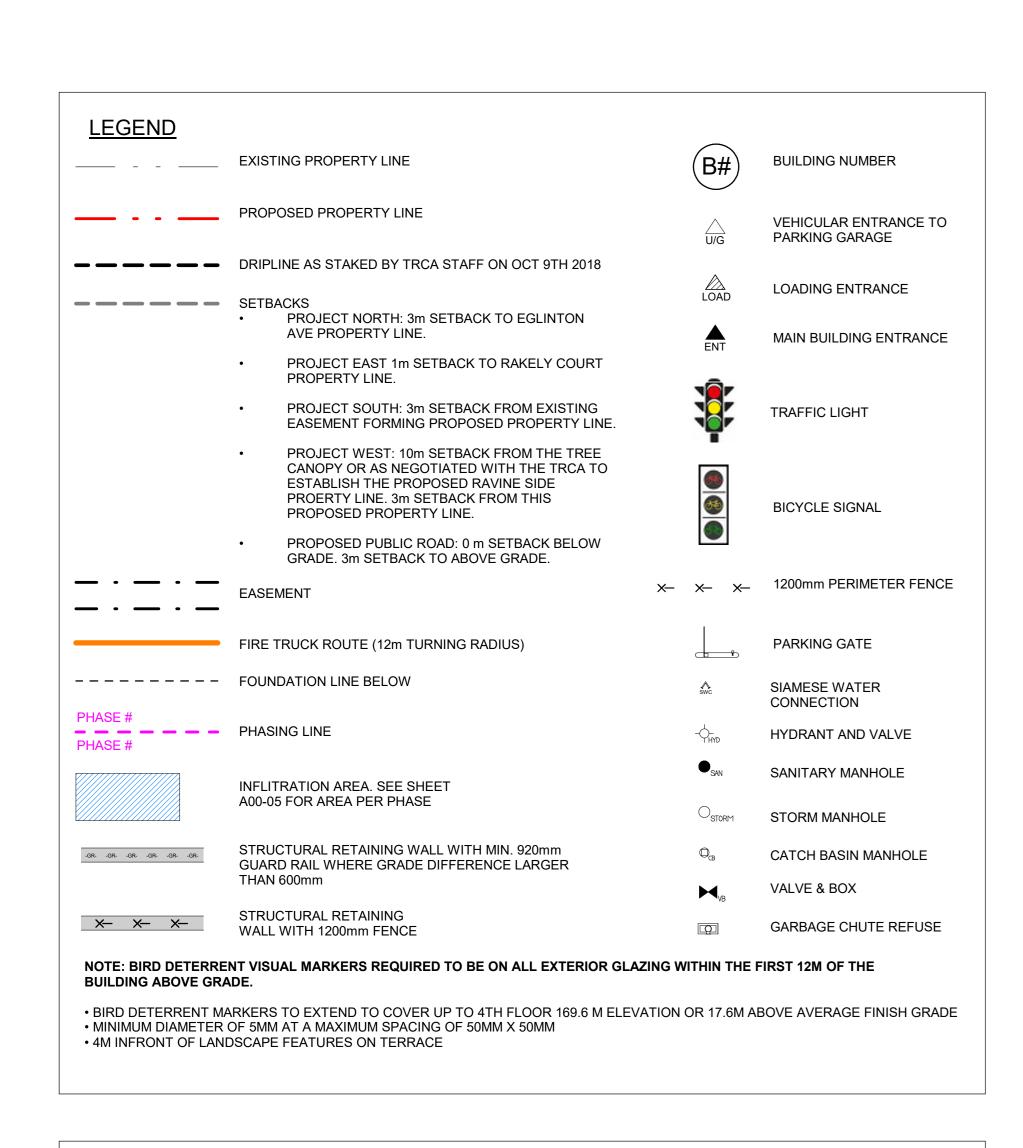

OFFICES

OFFICE CIRCULATION

ELEVATORS

STAIRS


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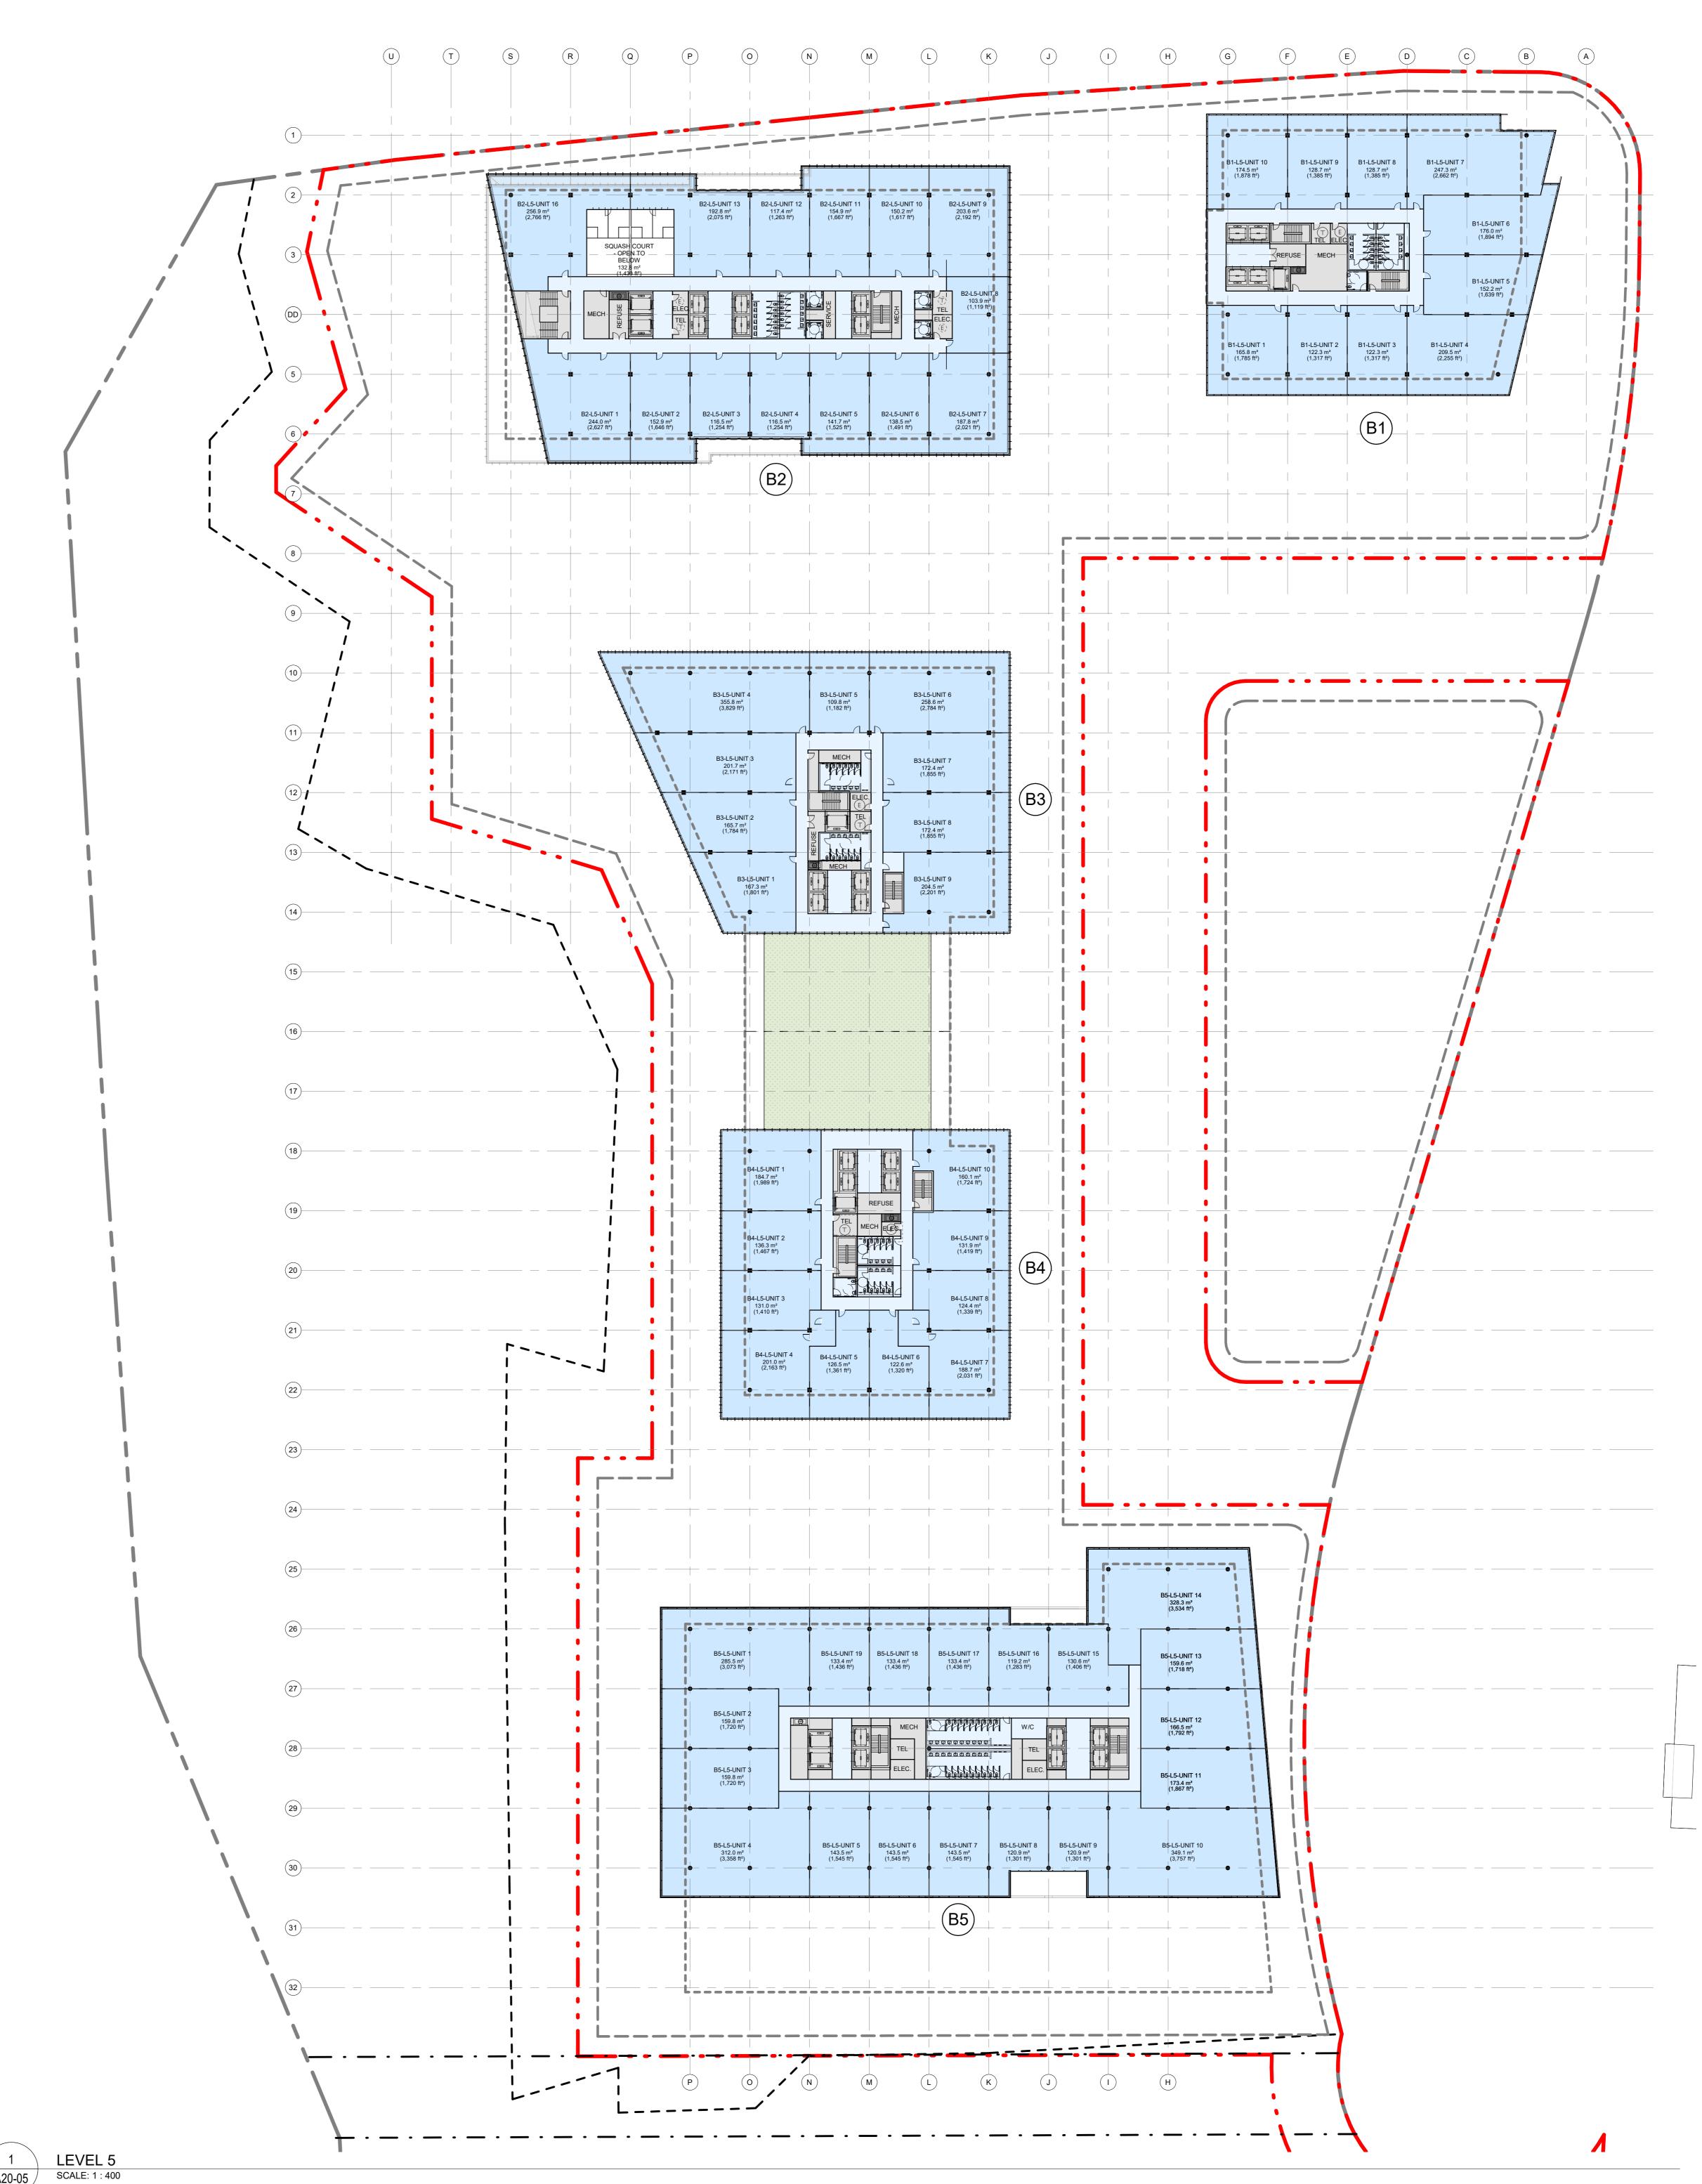
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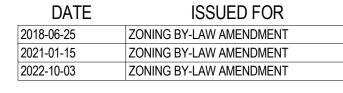
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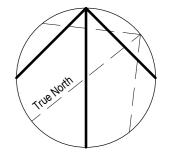
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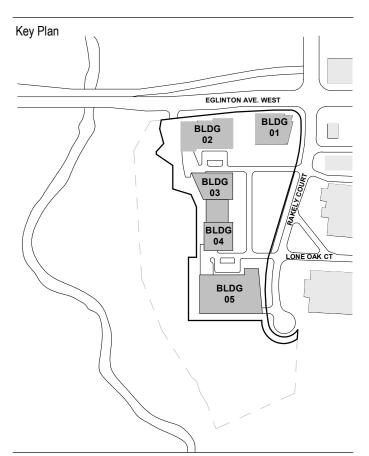






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Drawing Title


LEVEL 5

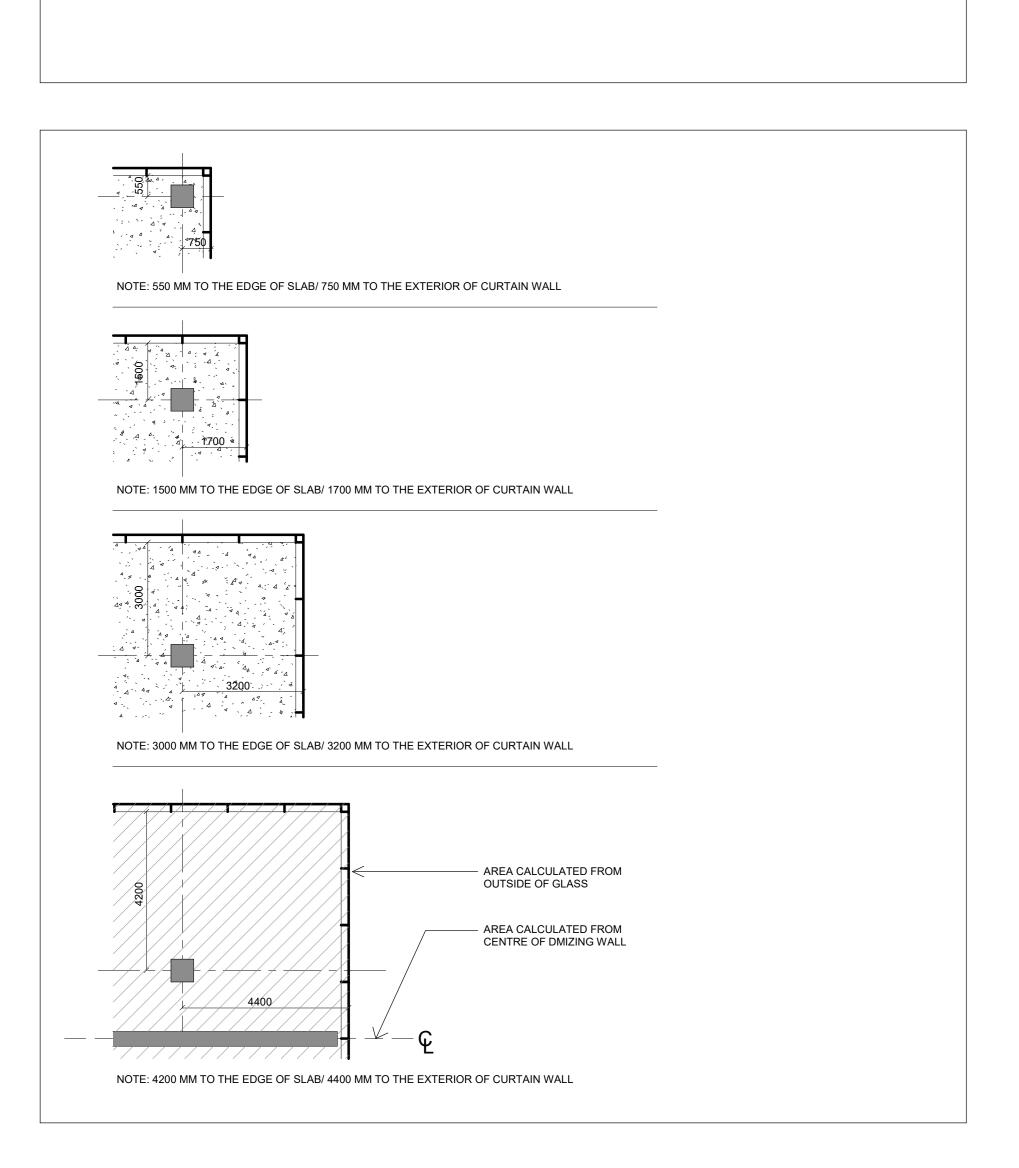1 : 400

Project No.

ONBL 18-0225

Drawing No.

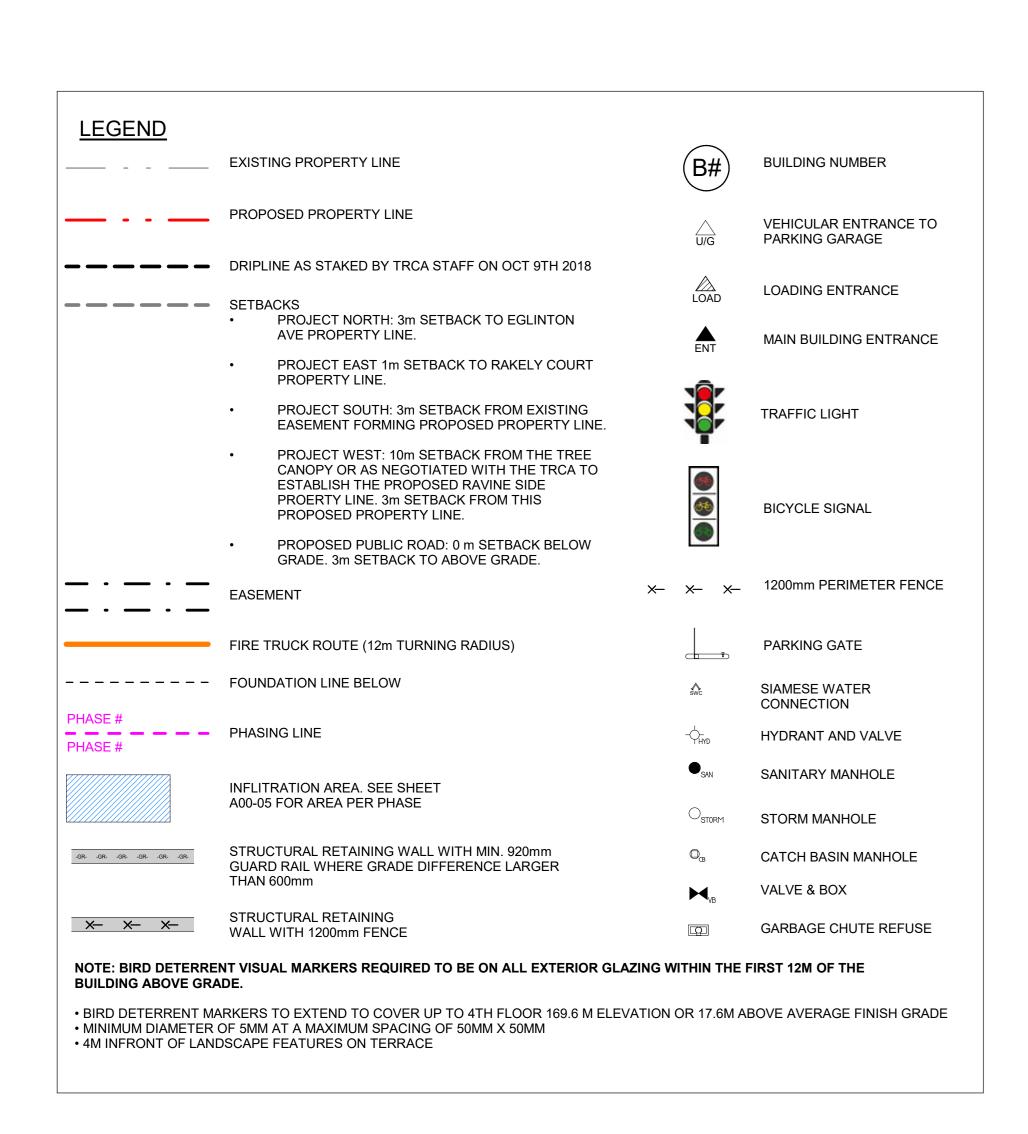

OFFICES

OFFICE CIRCULATION

REFUSE

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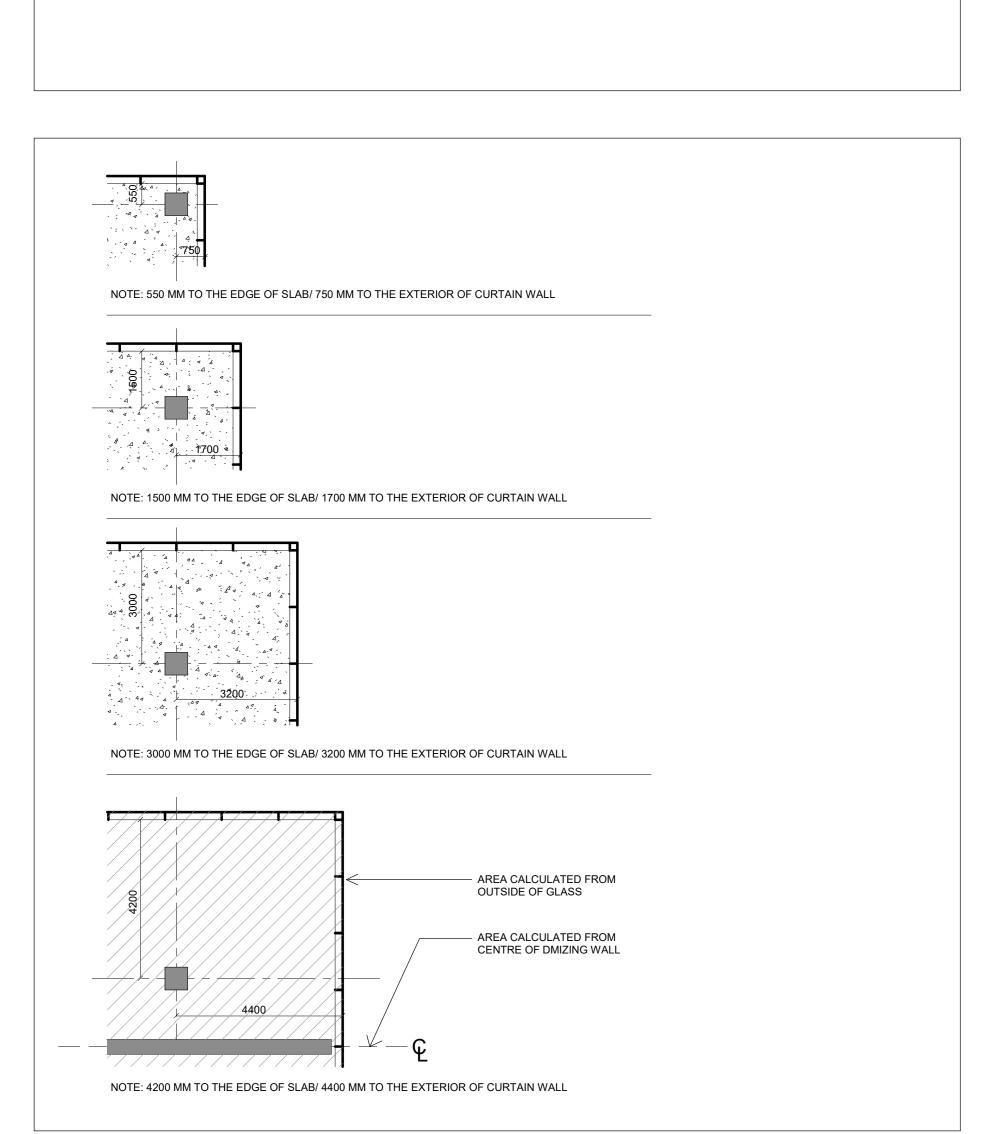
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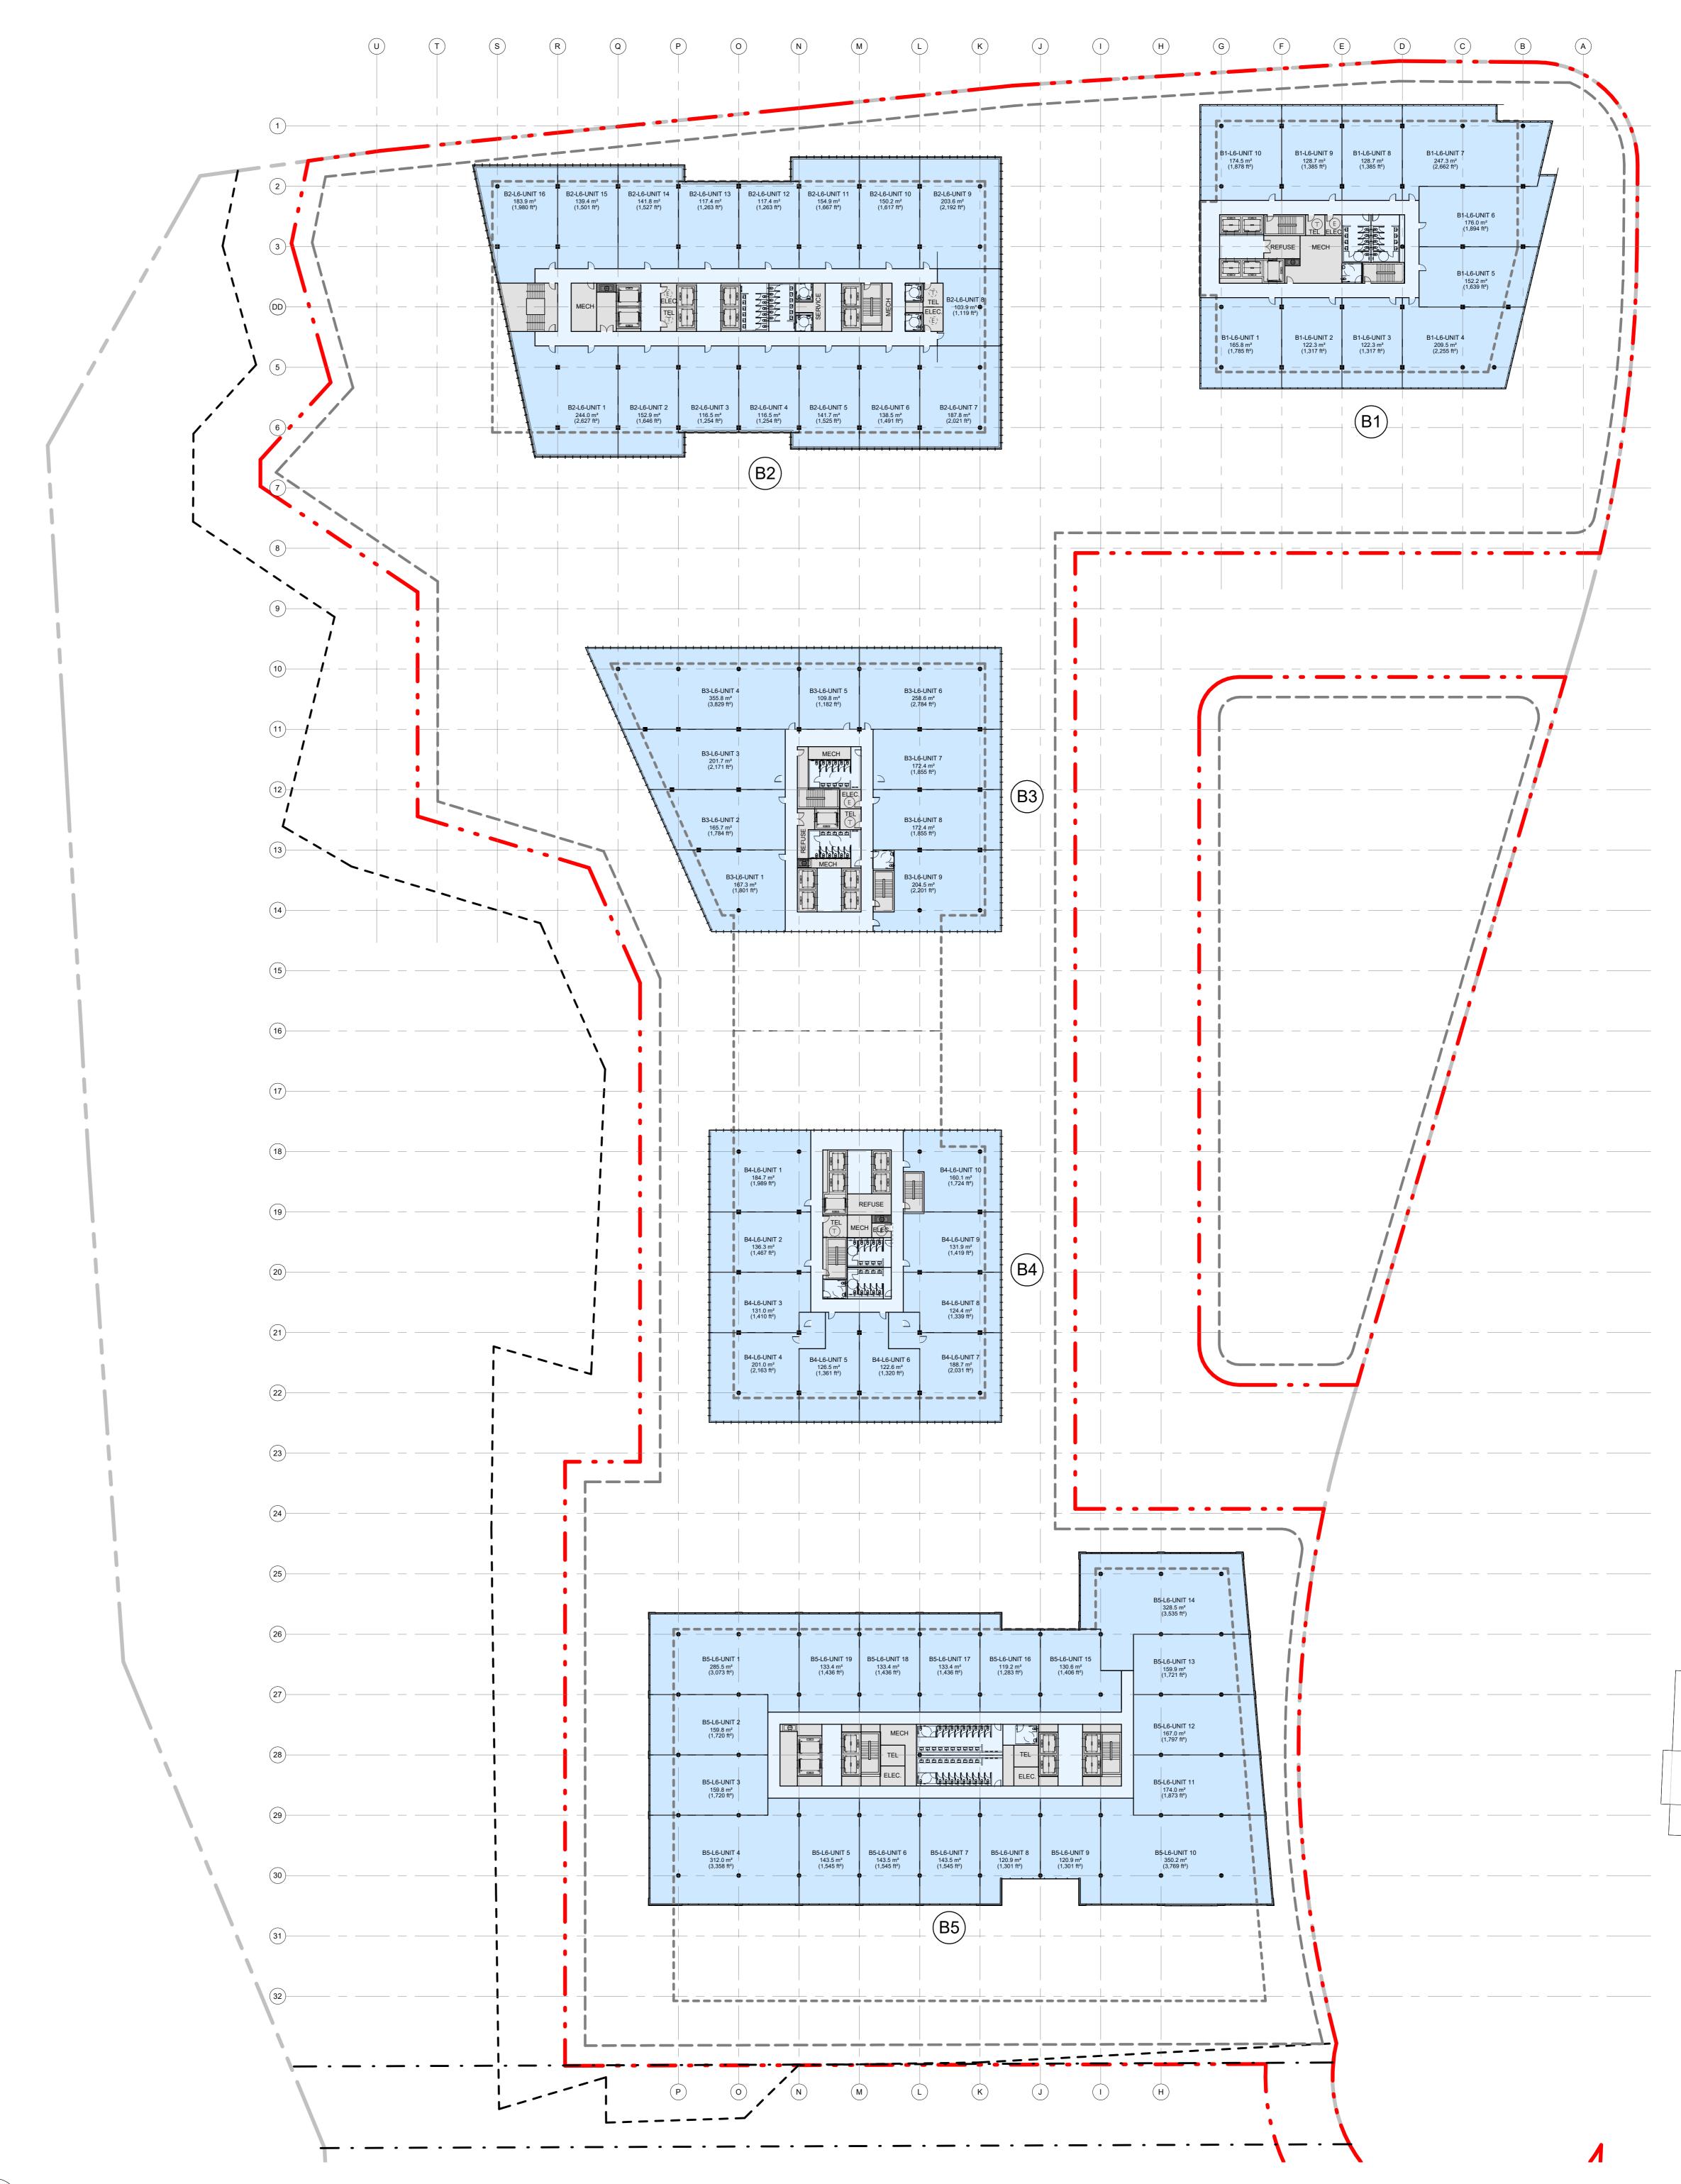
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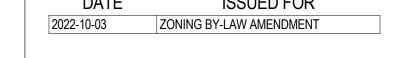
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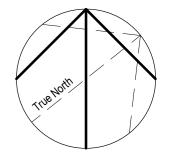
SHOWERS

WASHROOMS










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ASSOCIATION NO.

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Drawing Title

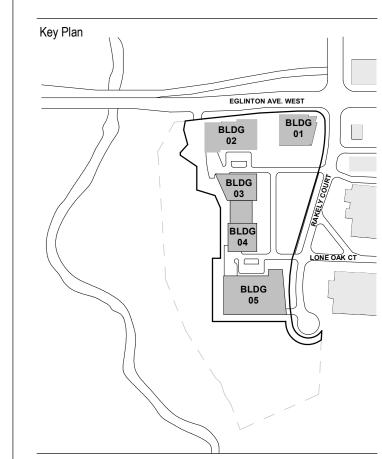LEVEL 6


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1:400

Project No.

ONBL 18-0225

Drawing No.

1 LEVEL 6 A20-06 SCALE: 1: 400

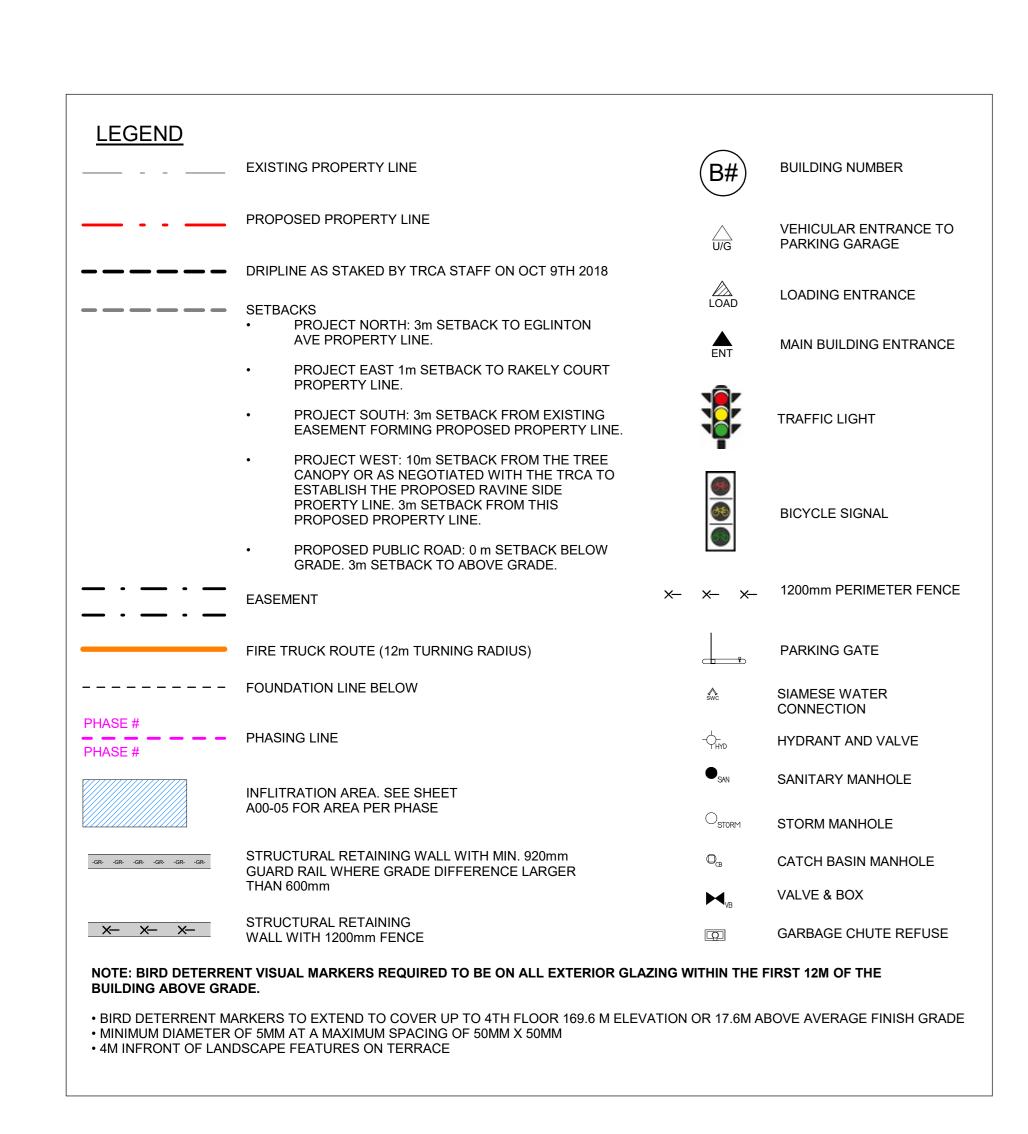

OFFICES

OFFICE CIRCULATION

ELEVATORS

STAIRS


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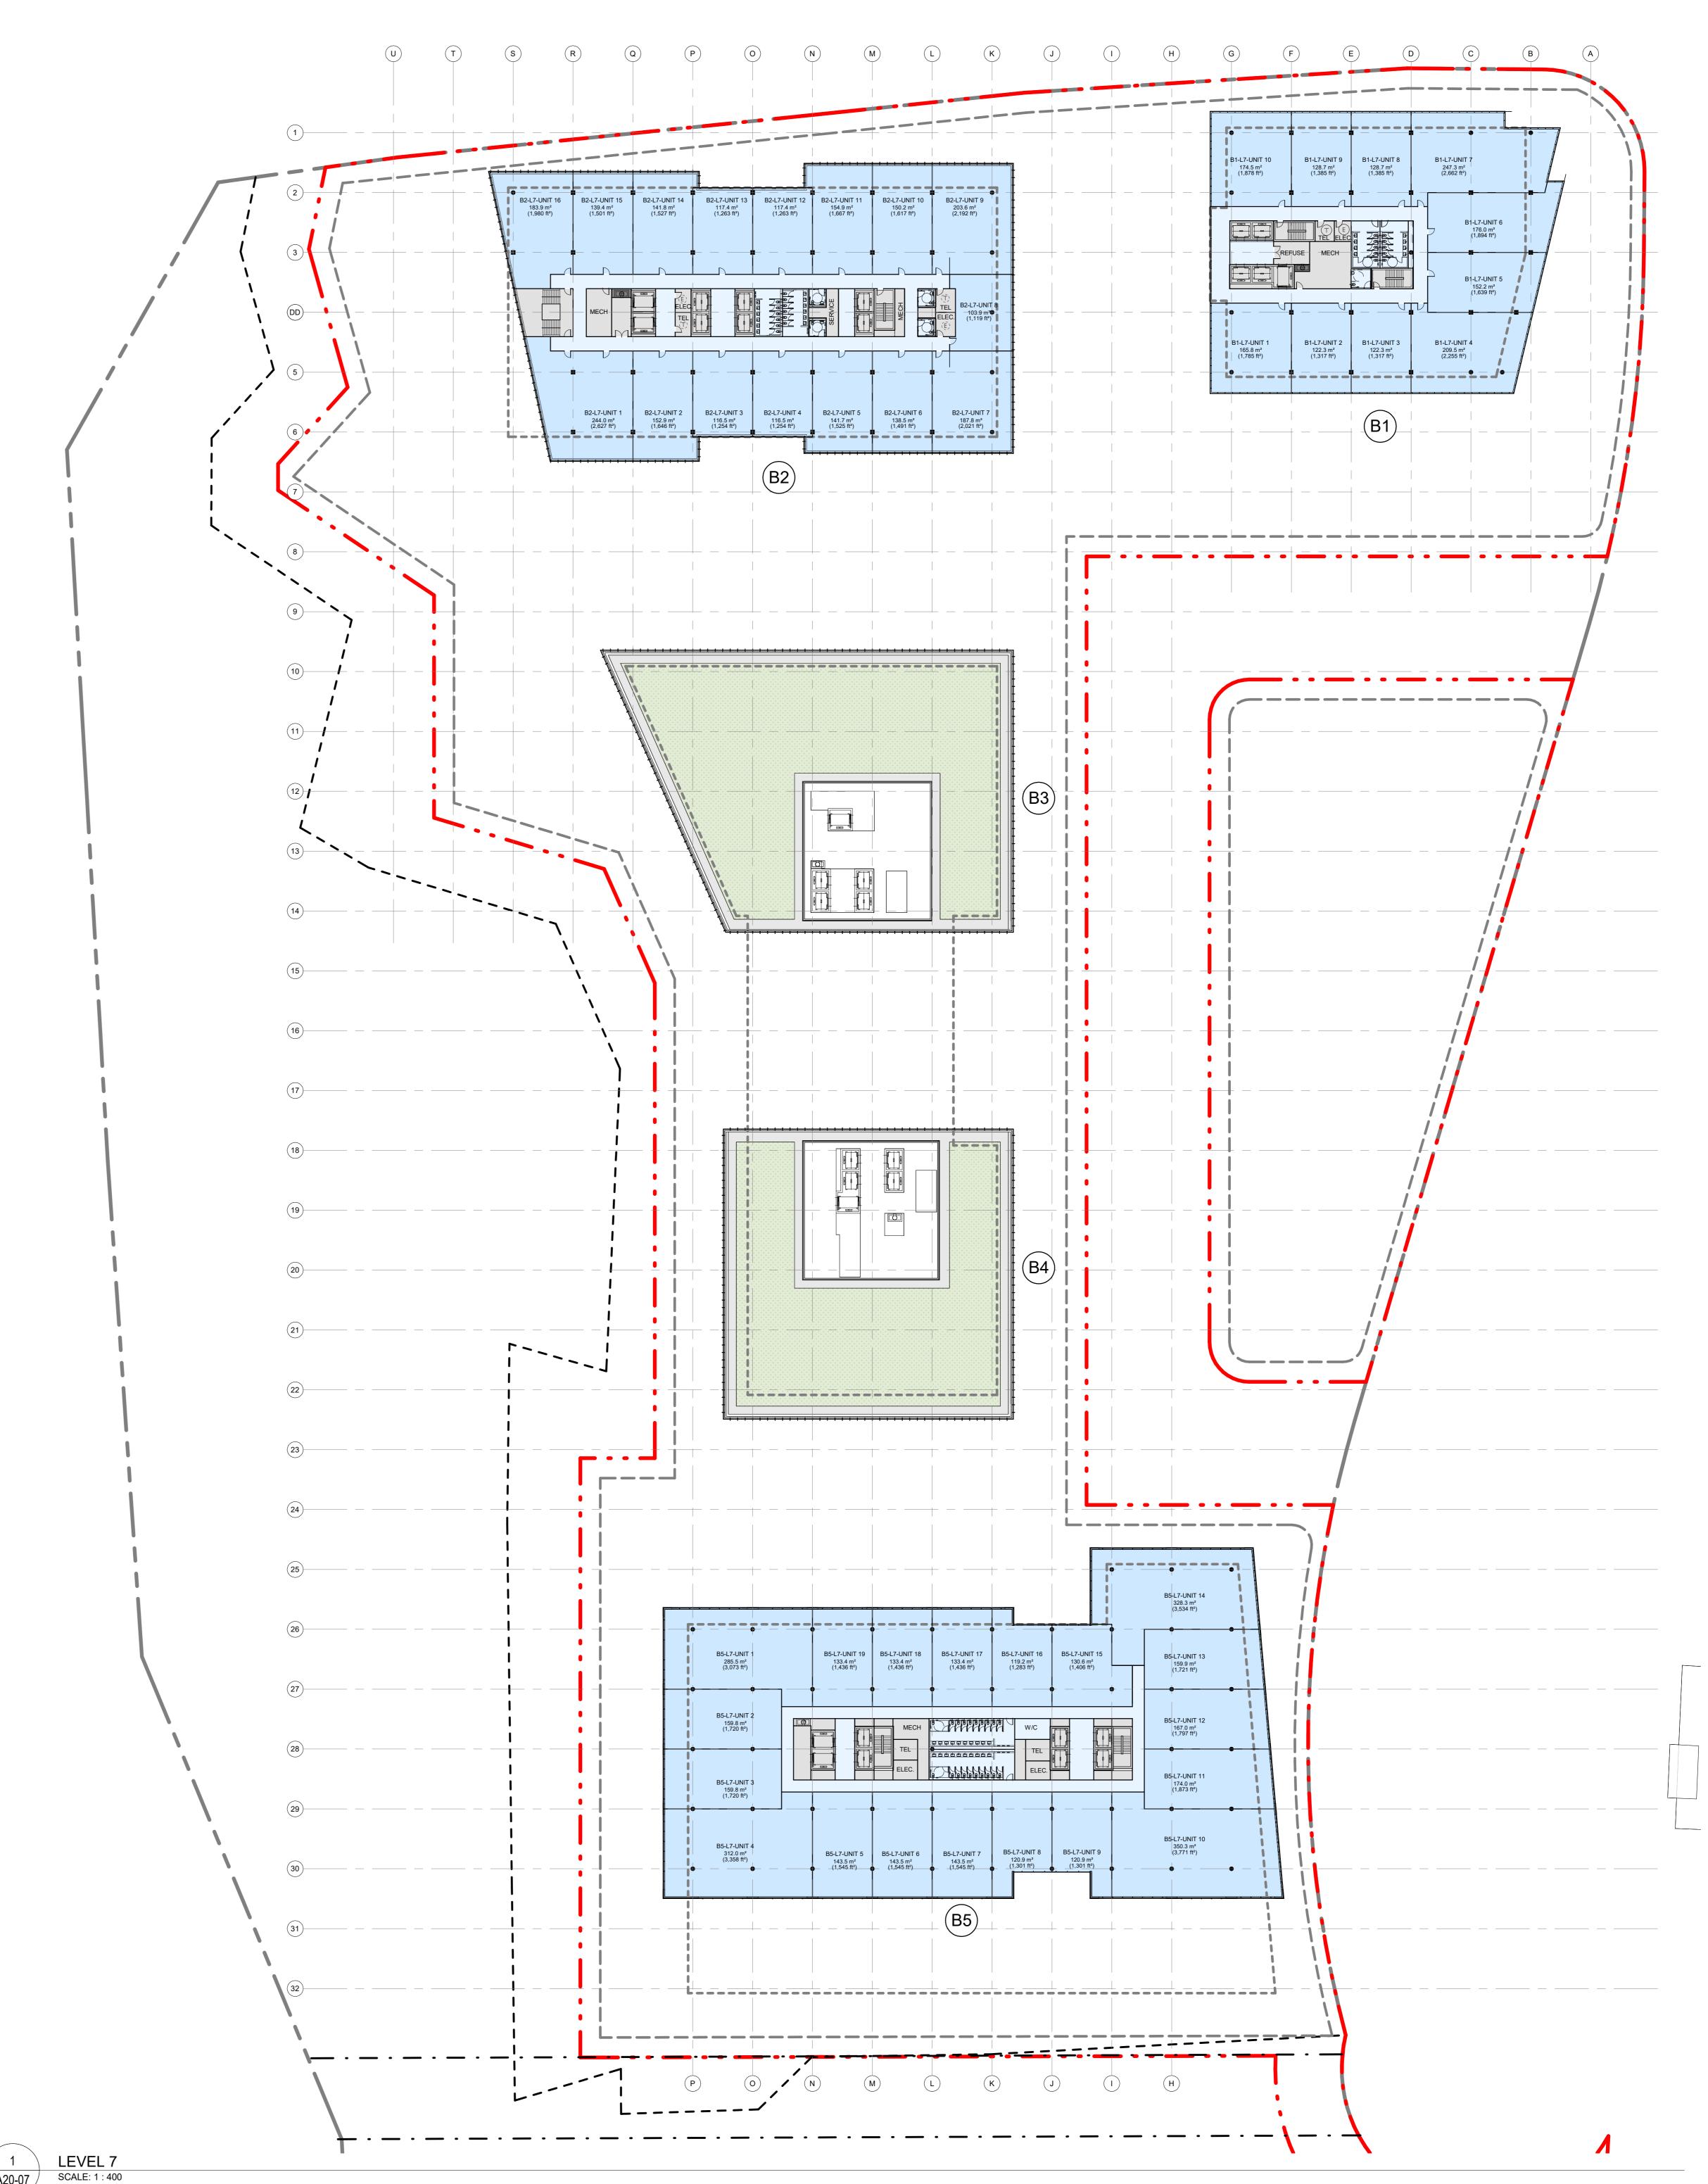
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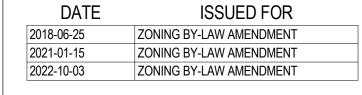
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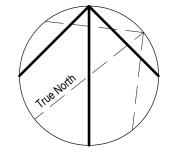
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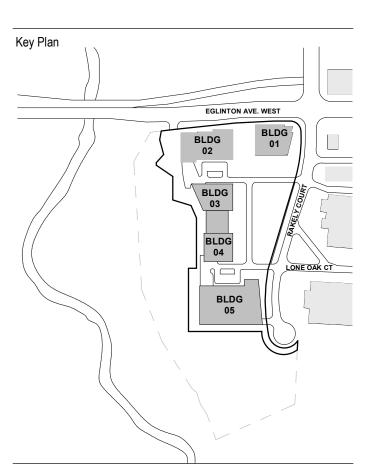






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Drawing Title


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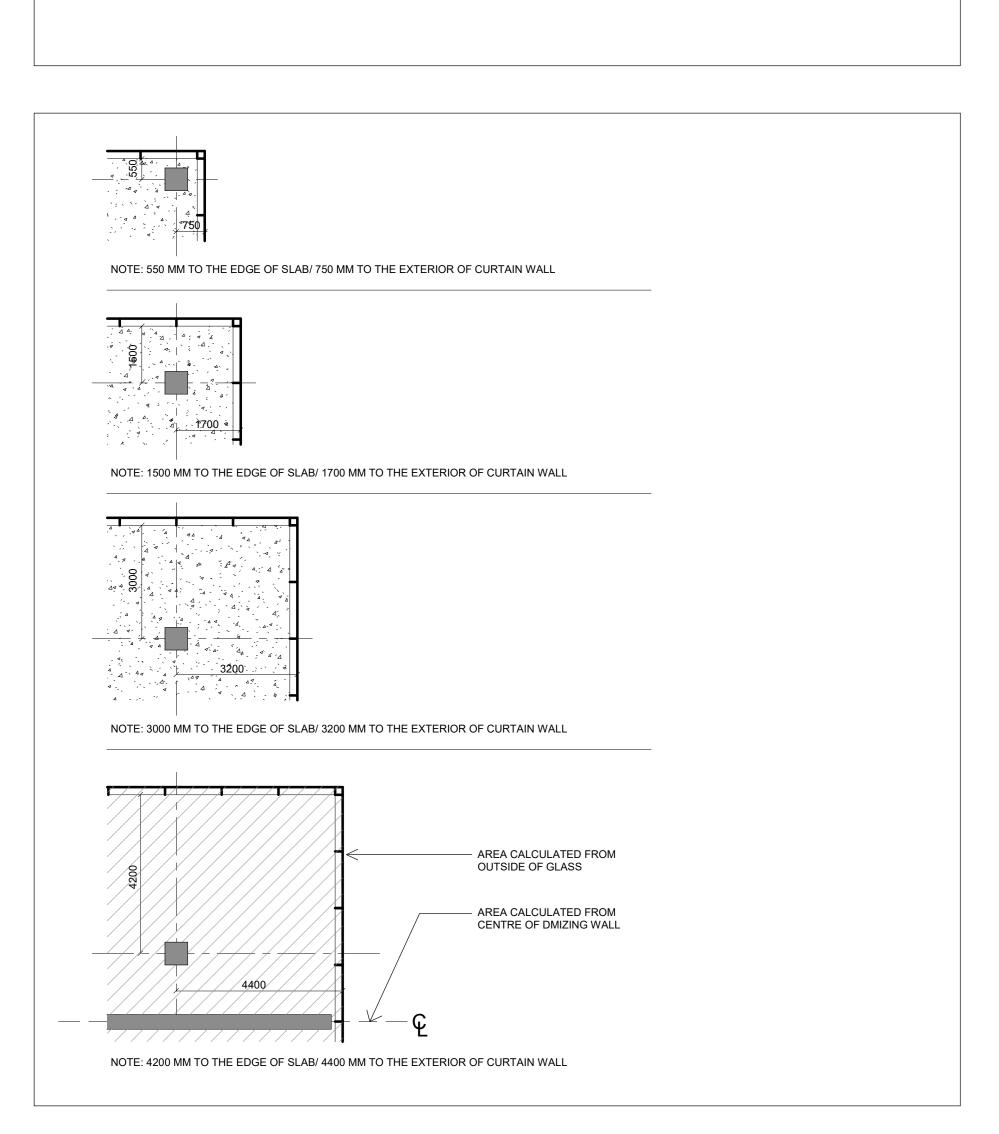
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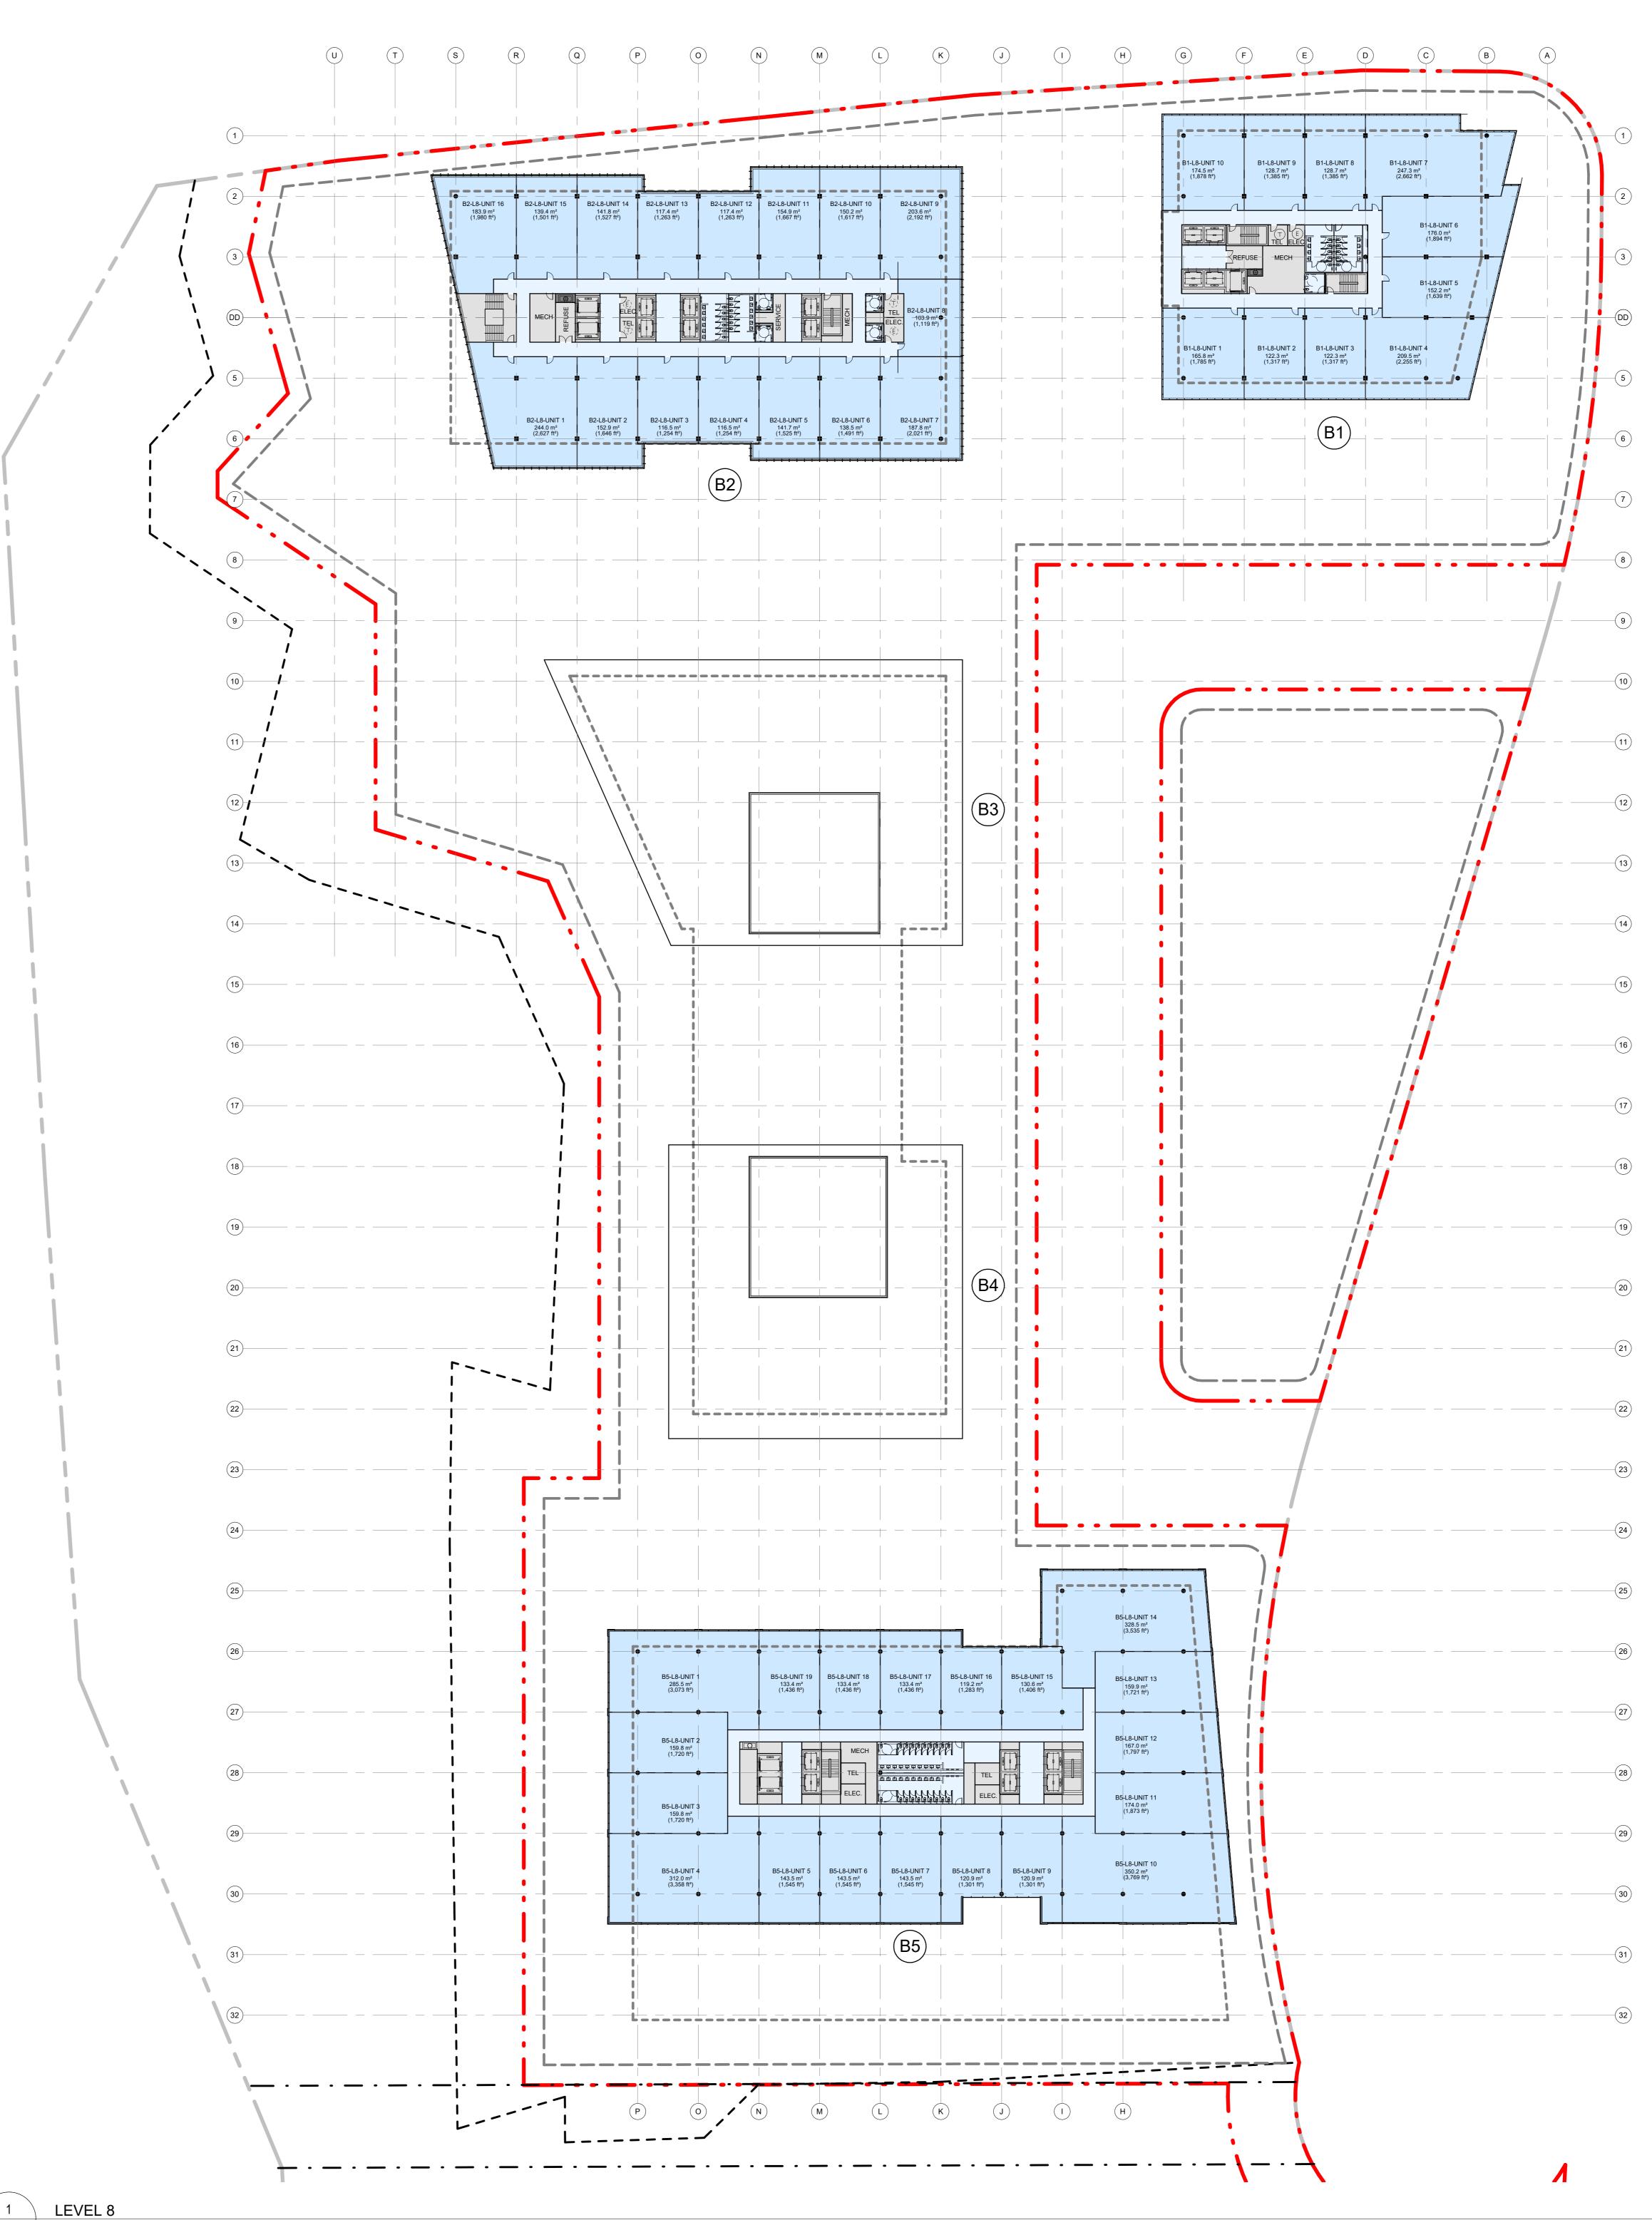
Project No.

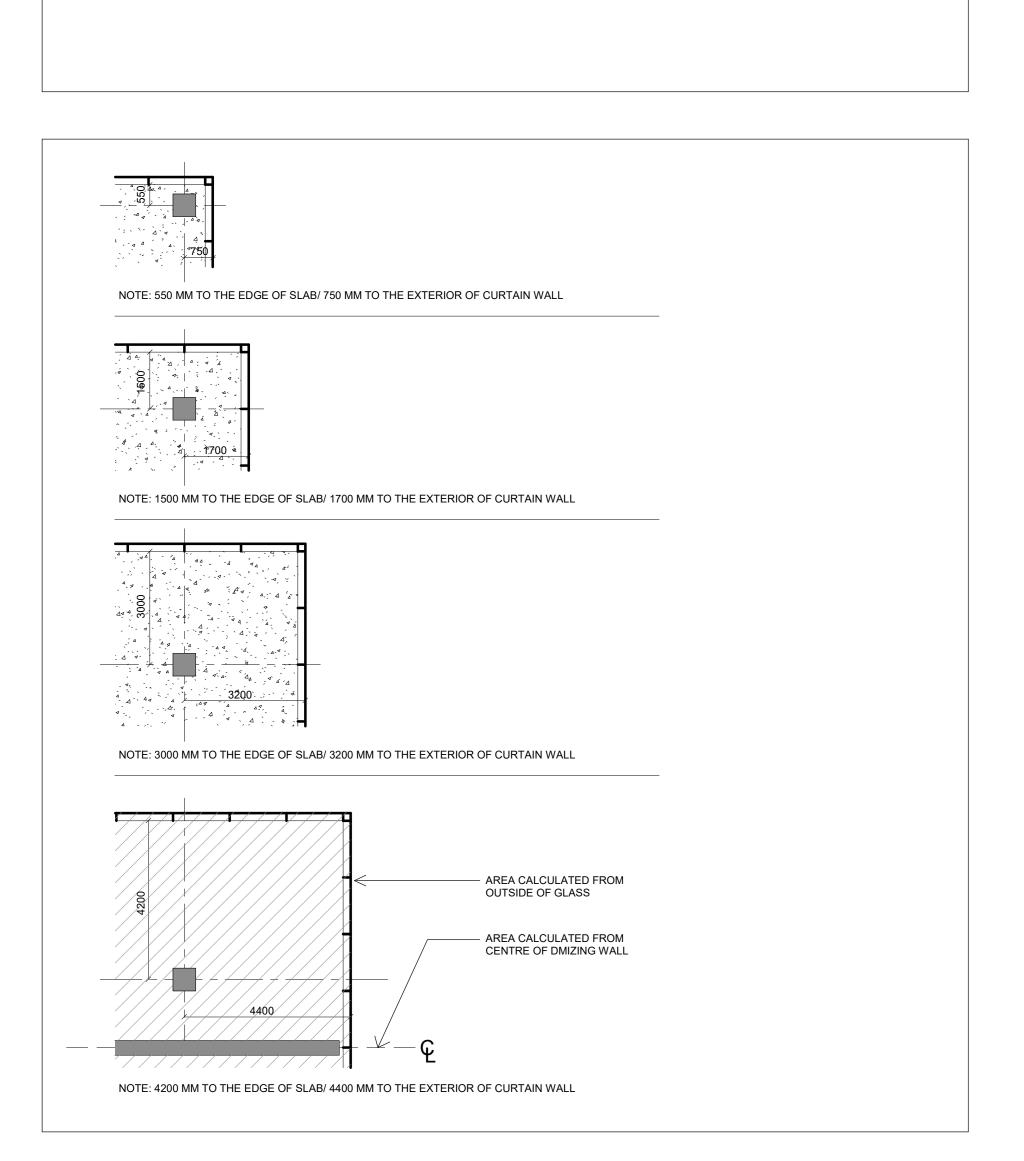ONBL 18-0225

Drawing No.






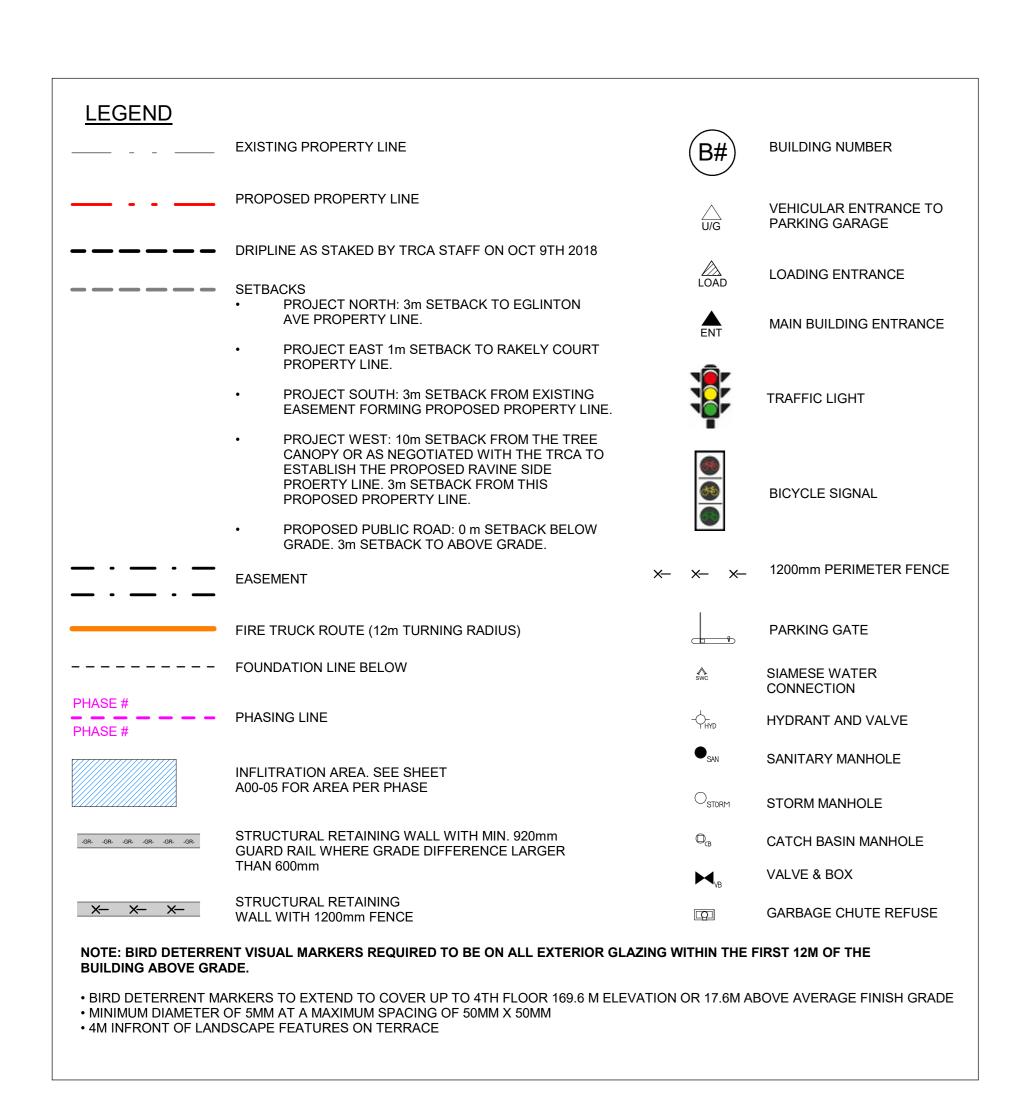

2022-10-03 ZONING BY-LAW AMENDMENT

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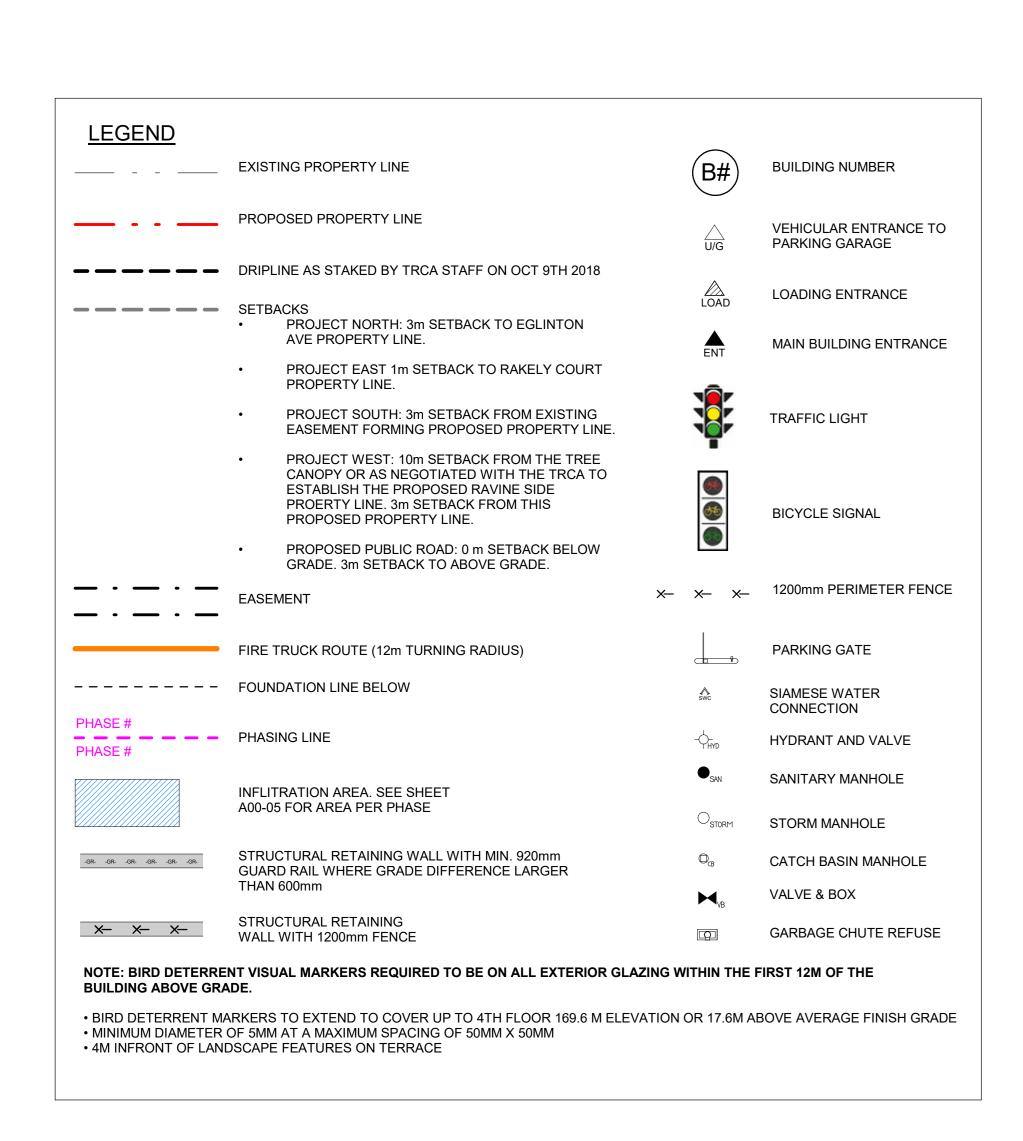
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Drawing Title LEVEL 8

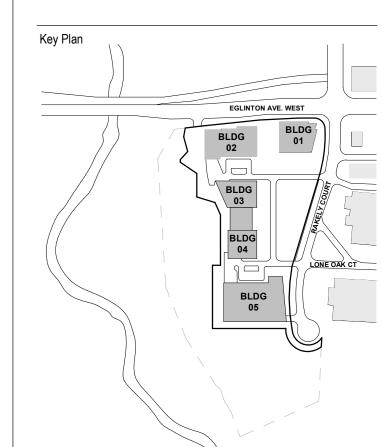1:400 Project No. ONBL 18-0225 Drawing No.





OFFICES

OFFICE CIRCULATION

ELEVATORS


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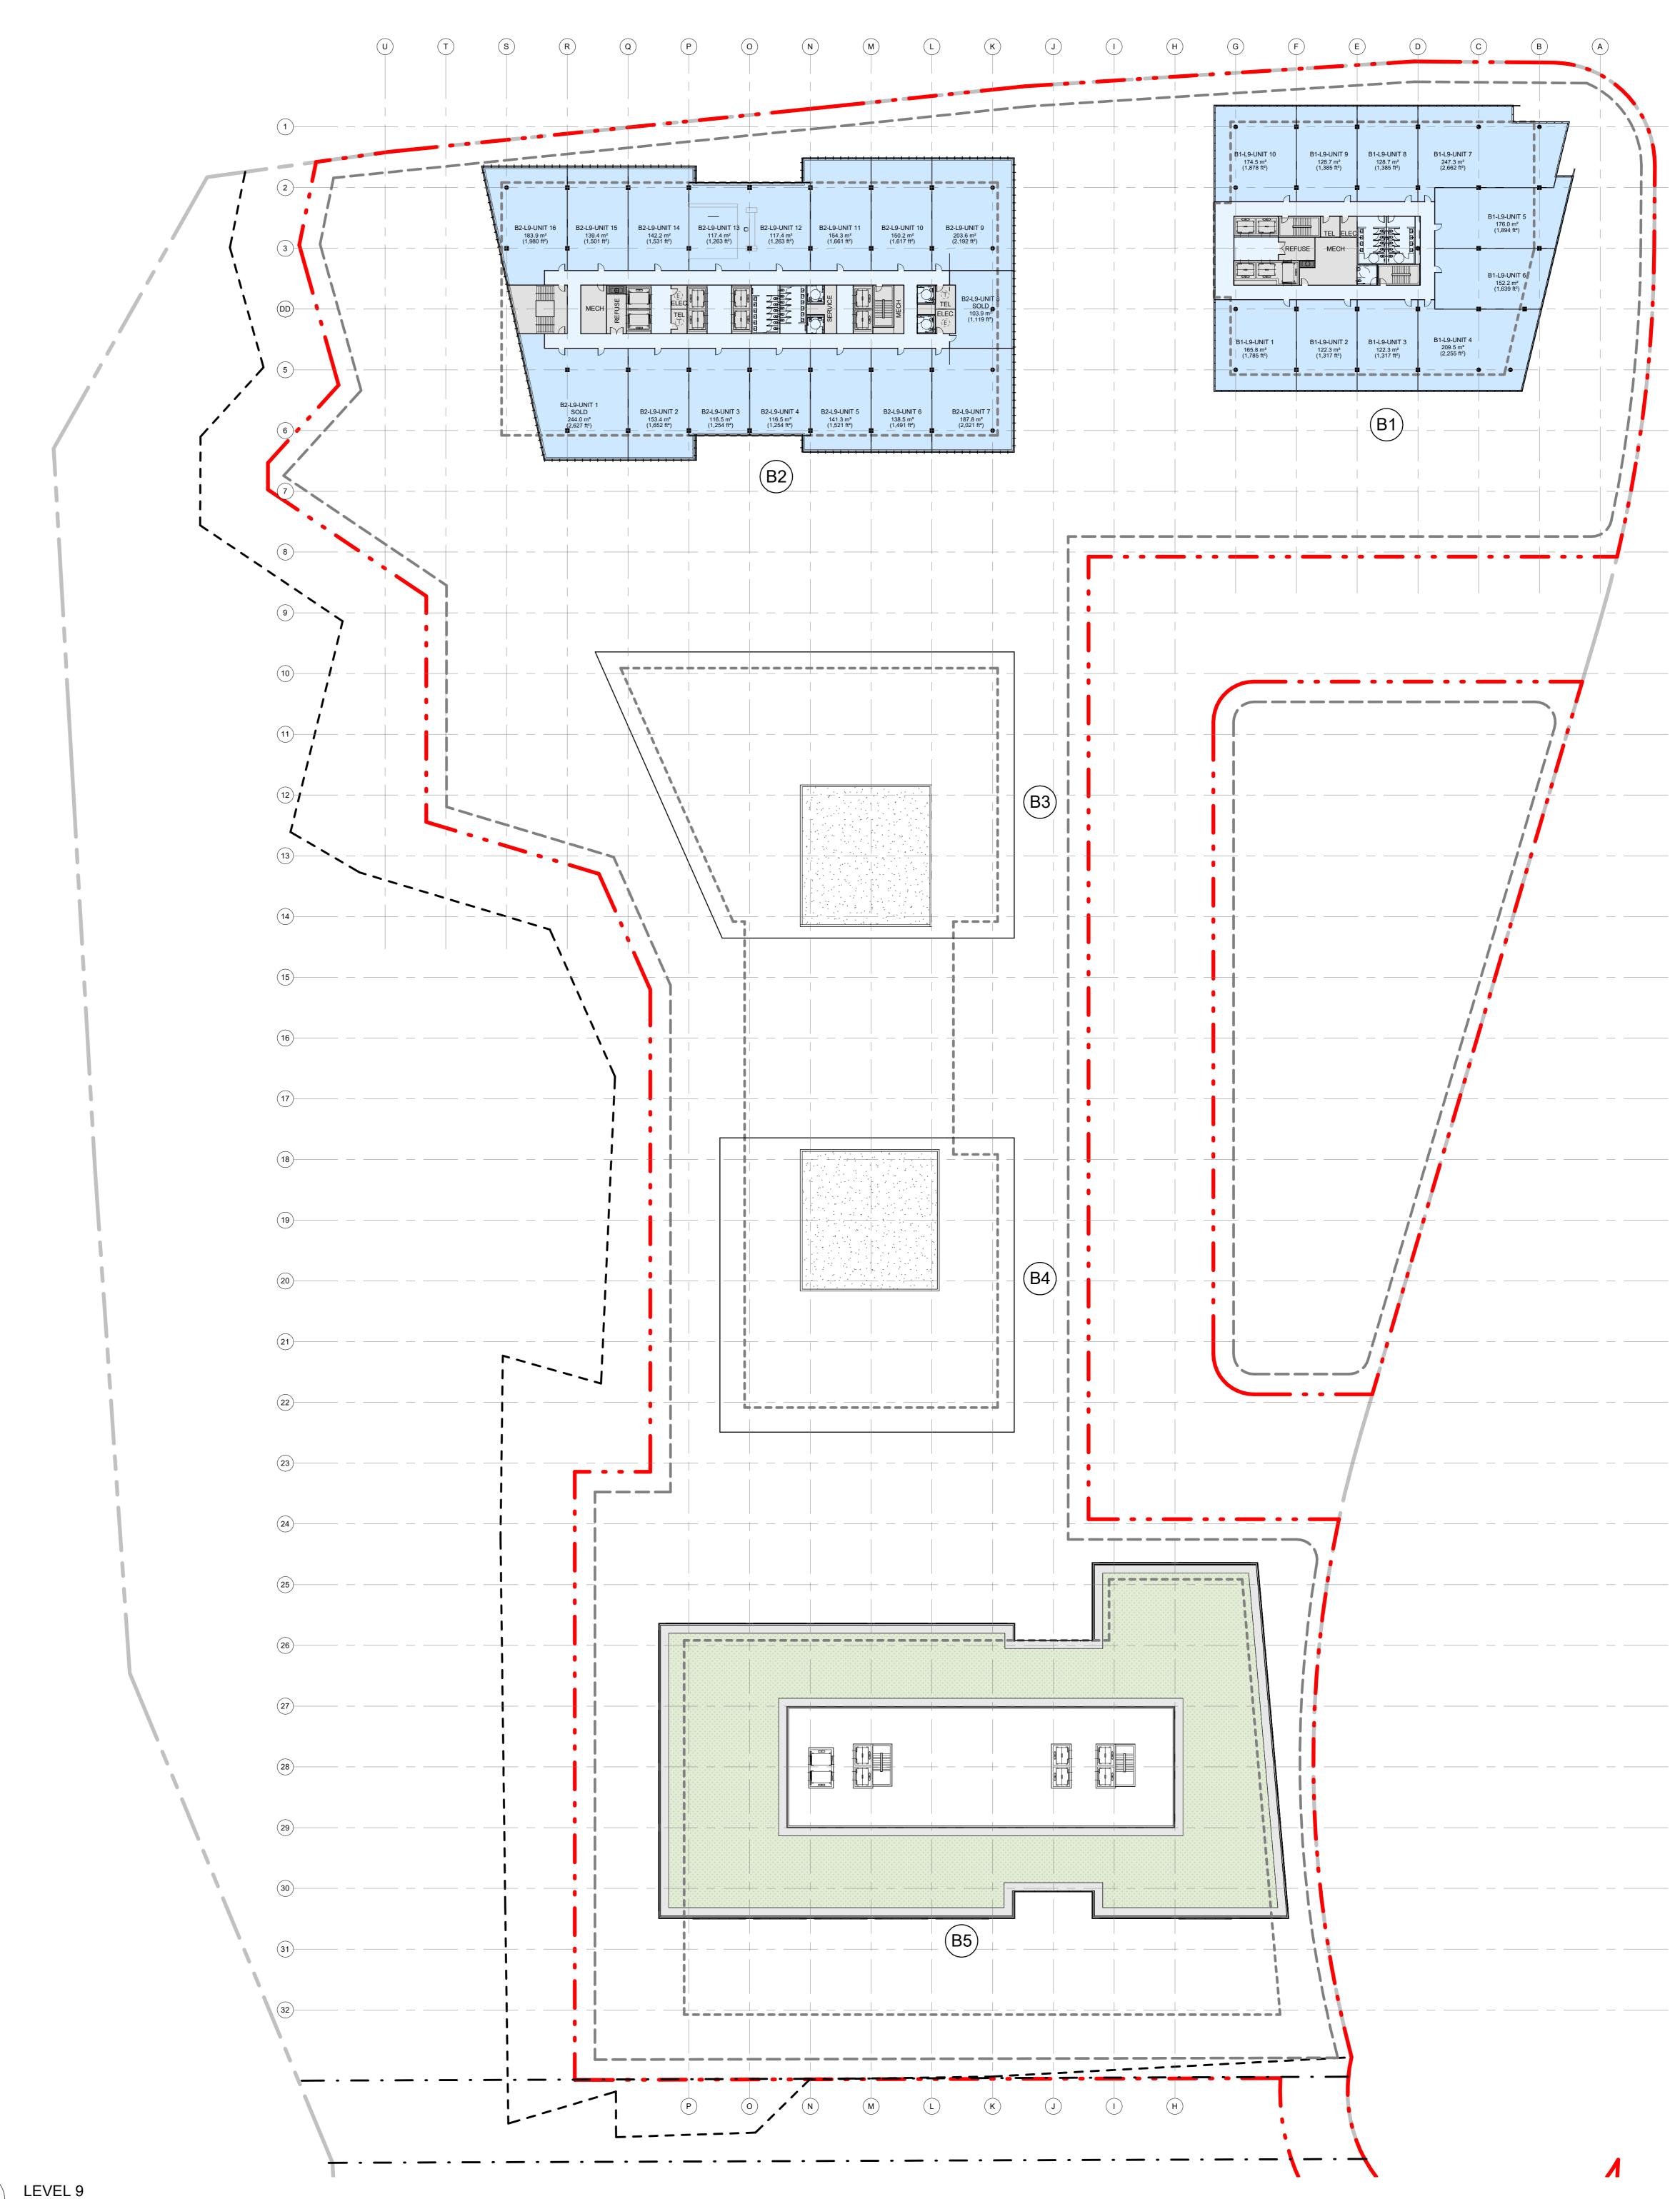
SERVICE

ELEC/TEL

SHOWERS


WASHROOMS



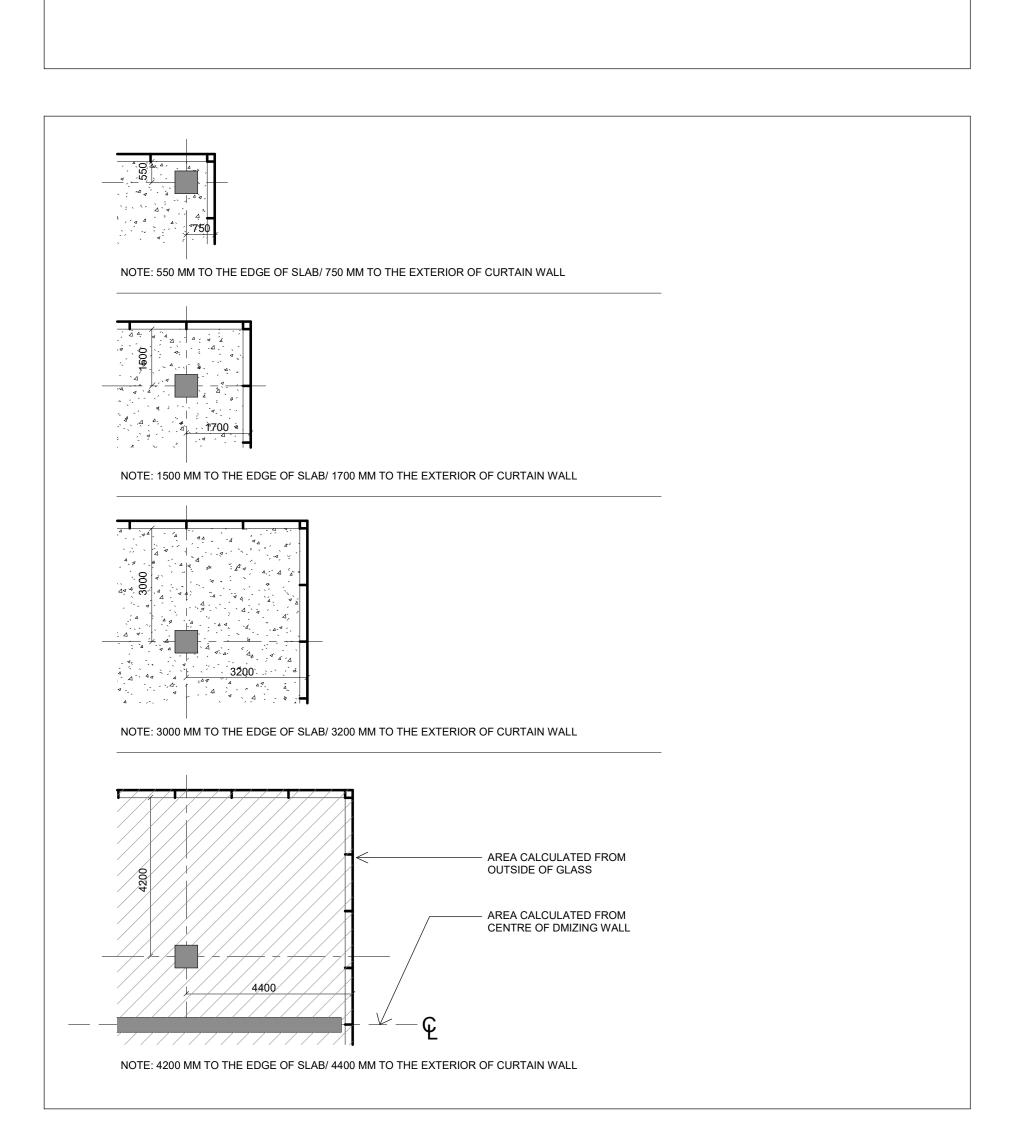

ISSUED FOR 2018-06-25 ZONING BY-LAW AMENDMENT 2021-01-15 ZONING BY-LAW AMENDMENT ZONING BY-LAW AMENDMENT 2022-10-03

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GABRIEL FAIN ARCHITECTS INC.

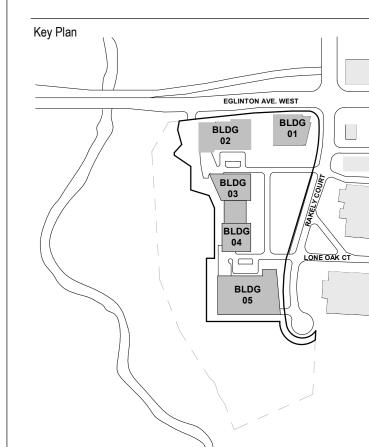NORR Architects & Engineers Limited
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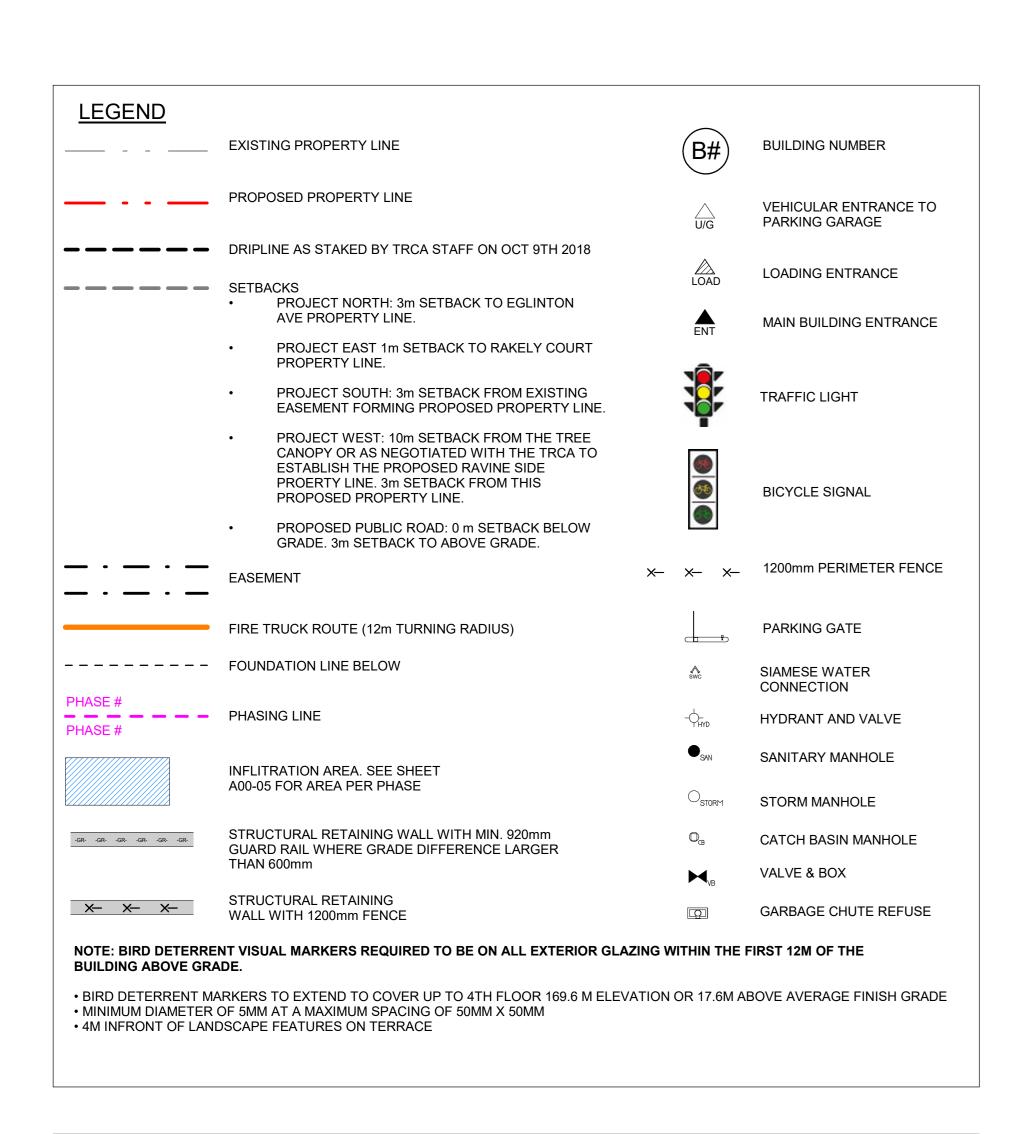
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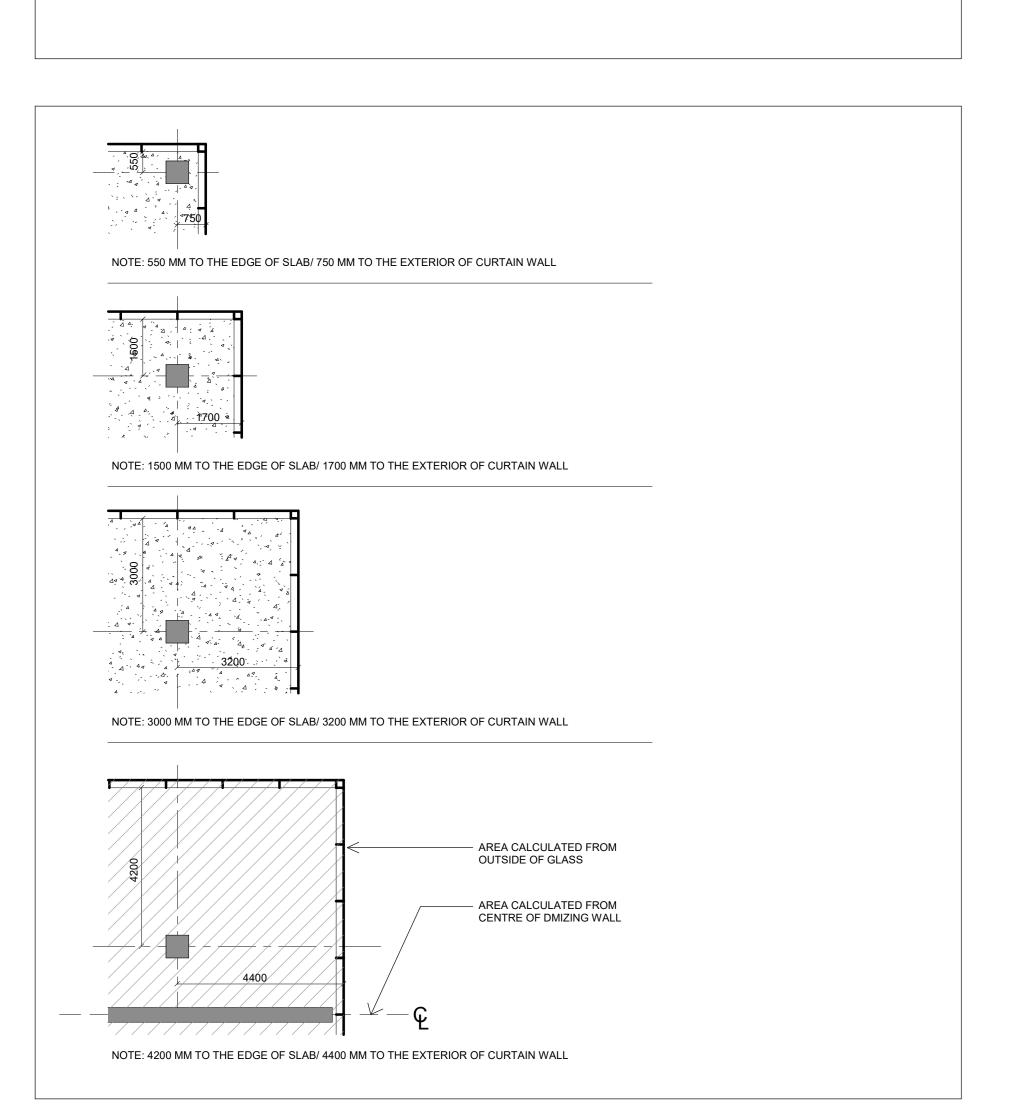
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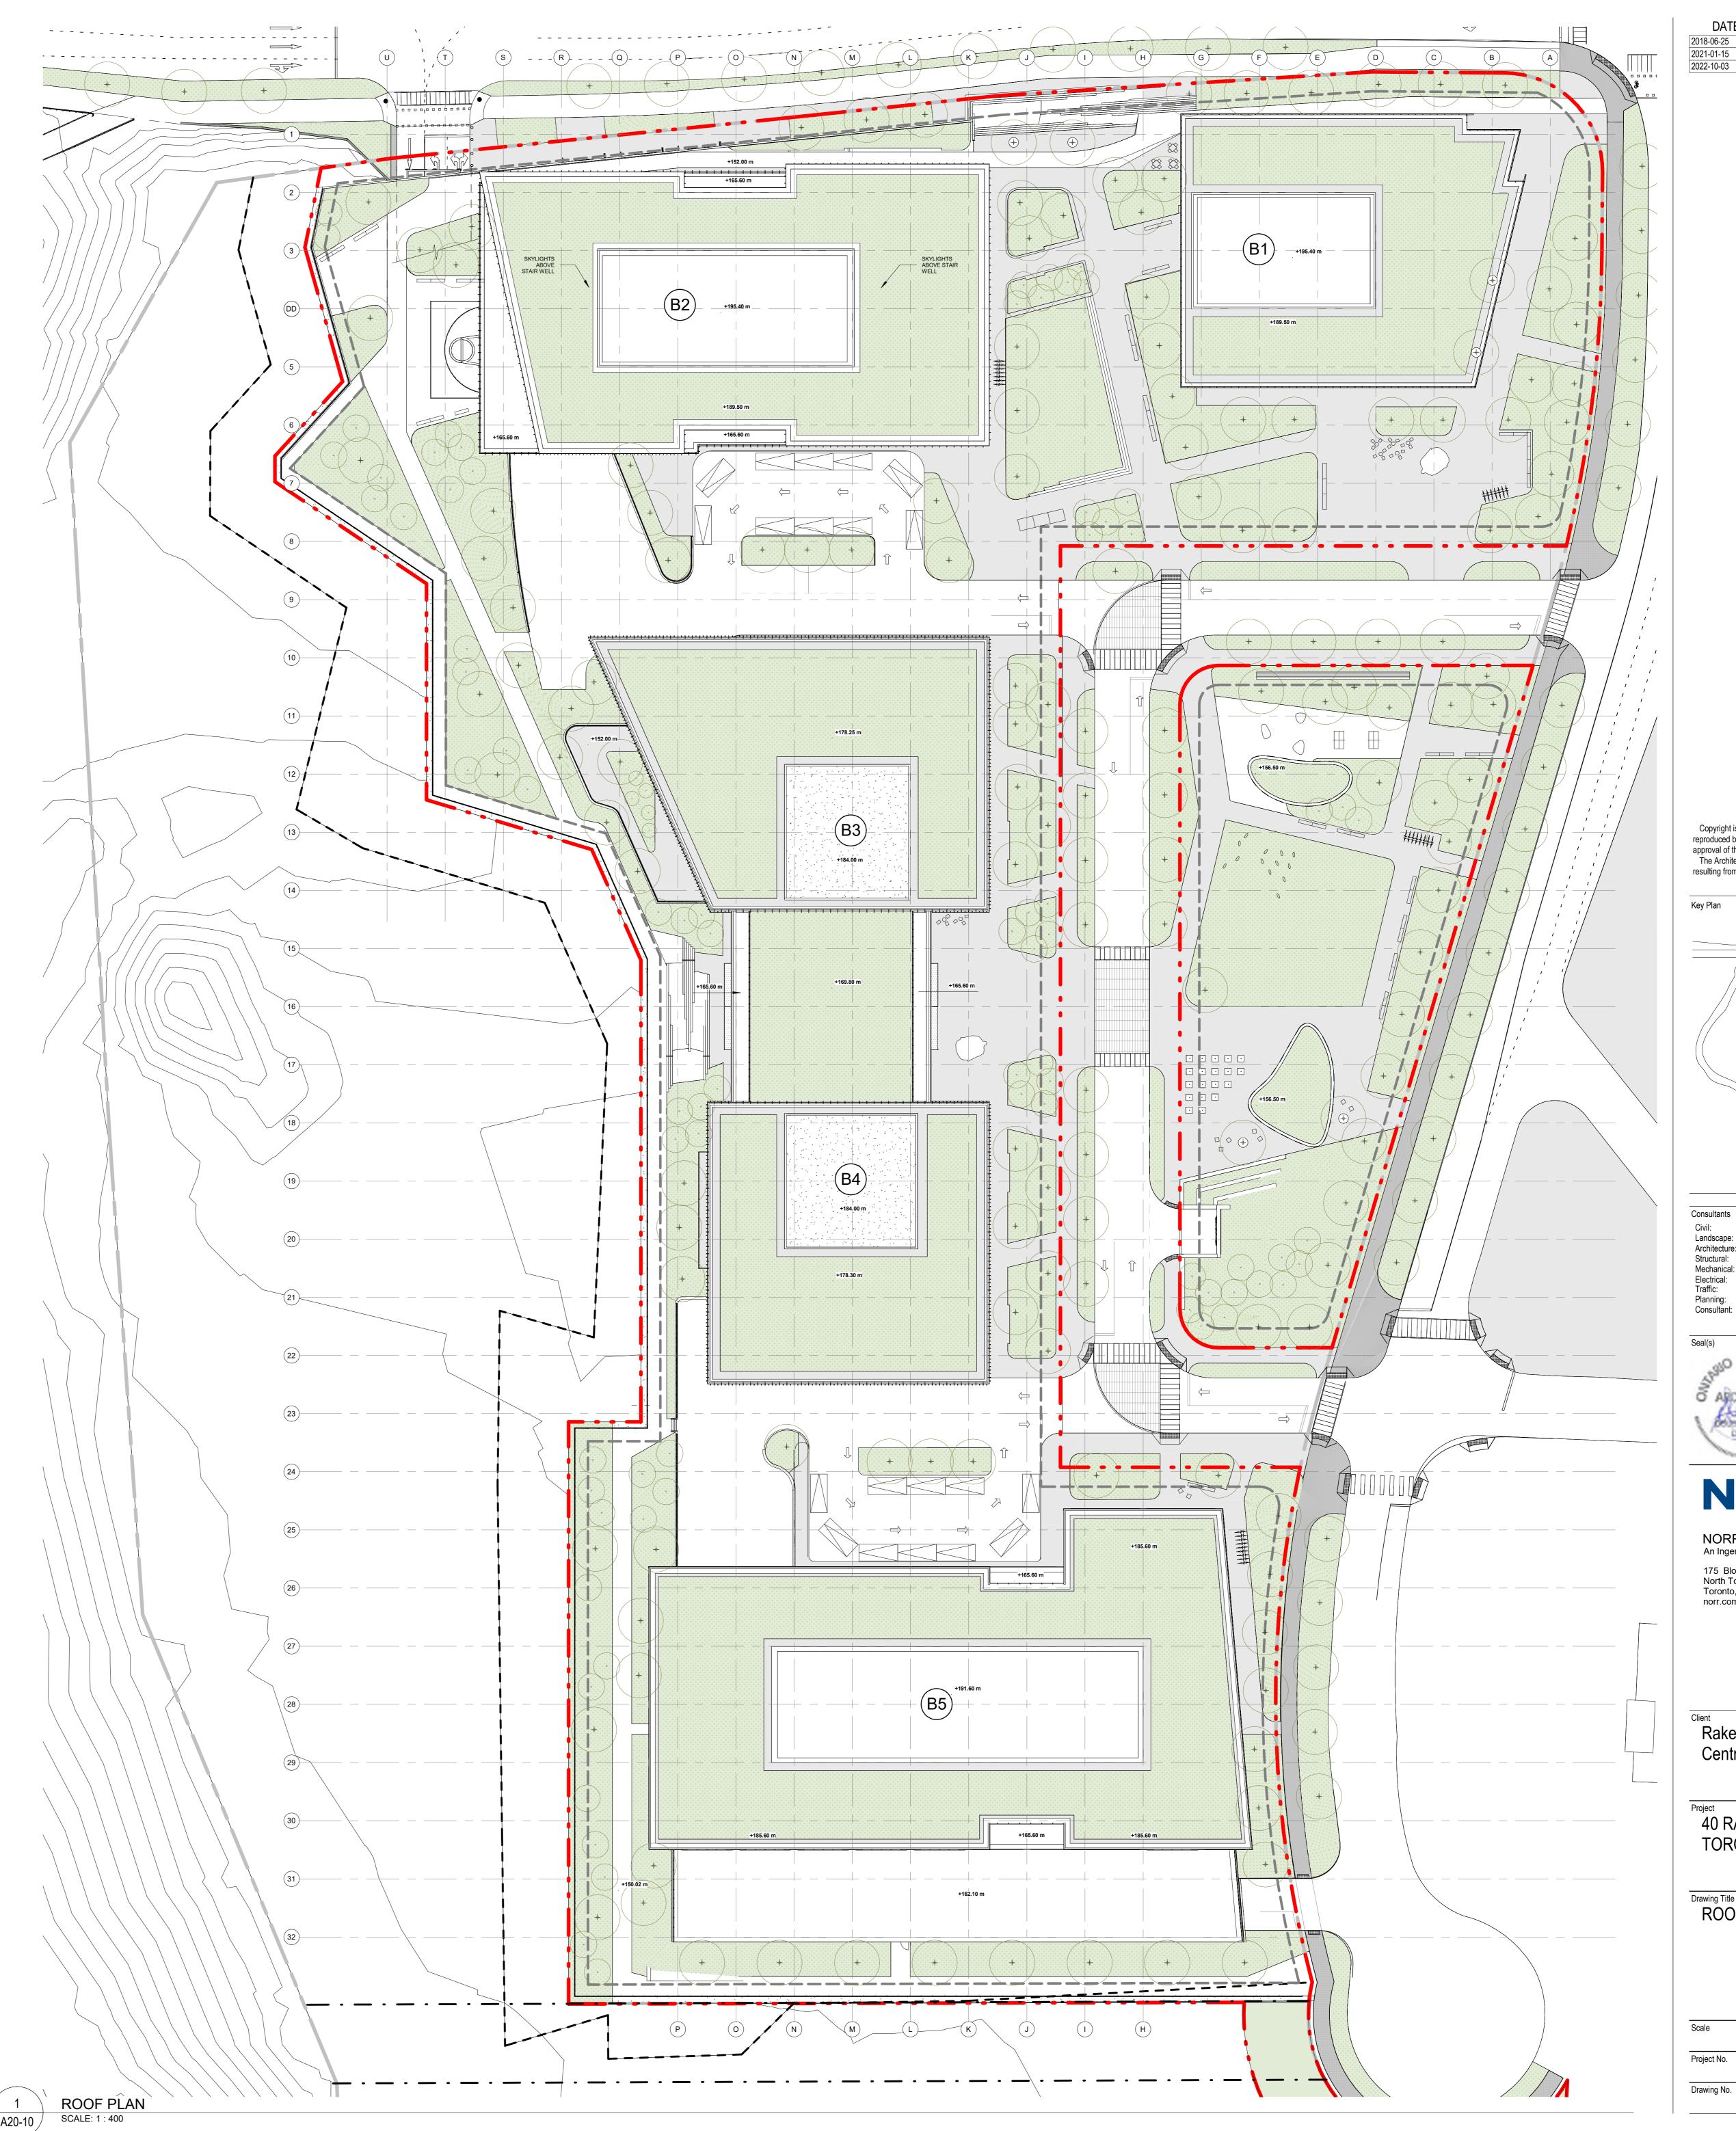
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> 1:400 ONBL 18-0225

LEVEL 9







 DATE
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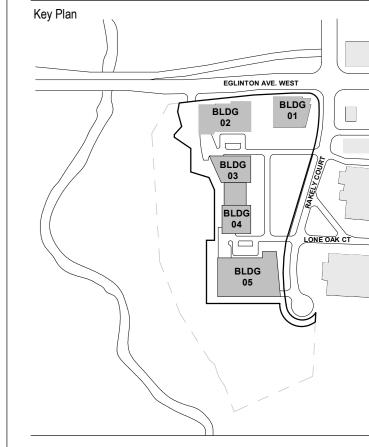
 2018-06-25
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Consultants

Civil: R.J. BURNSIDE & ASSOCIATES LIMITED
Landscape: JANET ROSENBERG & STUDIO INC.
Architecture: NORR ARCHITECTS AND ENGINEERS LIMITED
Structural: NORR ARCHITECTS AND ENGINEERS LIMITED
Mechanical: NORR ARCHITECTS AND ENGINEERS LIMITED
Electrical: NORR ARCHITECTS AND ENGINEERS LIMITED
Traffic: BA CONSULTING GROUP LTD
Planning: URBAN STRATEGIES INC.
Consultant: GABRIEL FAIN ARCHITECTS INC.

ANCHITECTS 2

# NORR

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Drawing Title
ROOF PLAN

Scale 1 : 400

Project No. ONBL 18-0225